





GENERAL NOTES 1. FLOOR STRUCTURE IS EXISTING UNLESS NOTED OTHERWISE. EXISTING BUILDING IS DESIGNED BY JOHN F. ROSS ARCHITECT ON YEAR 1958. 2. ULESS NOTED OTHERWISE PROVIDE NEW 102mm SLAB ON GRADE AS PER SPECIFICATION THROUGHOUT AND AS PER 2/S1. SAWCUT SLAB INTO AREAS 6m x 6m MAX. PROVIDE CONTROL JOINTS IN ALL DOORWAYS. REINF. 1 LAYER 152 X 152 MW18.7/MW18.7 WWF OR USING FIBRE MESH. REFER TO "NEW SLAB ON GRADE" DETAIL ON THIS DRAWING. 3. USE DETAIL 3/S1 AT ALL LOCATIONS WHERE EXISTING SLAB IS TO BE CUT AND REPAIRED AND FOR ALL NEW BELOW GRADE SERVICES. 4. SHORE AS REQUIRED.

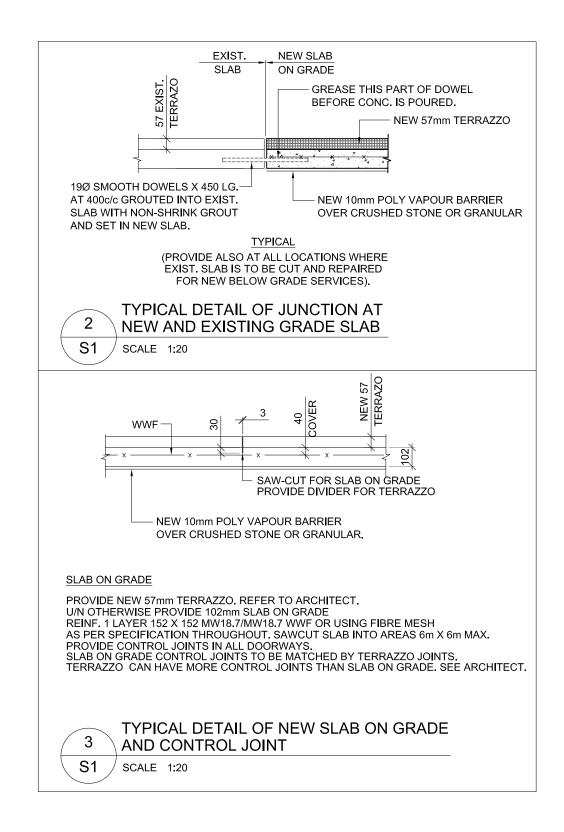

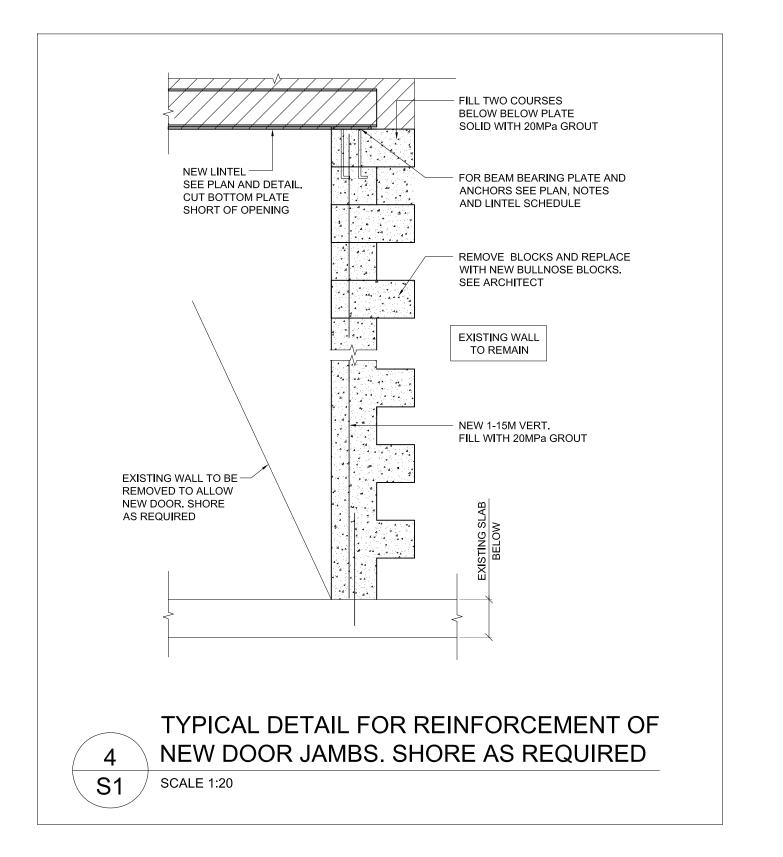

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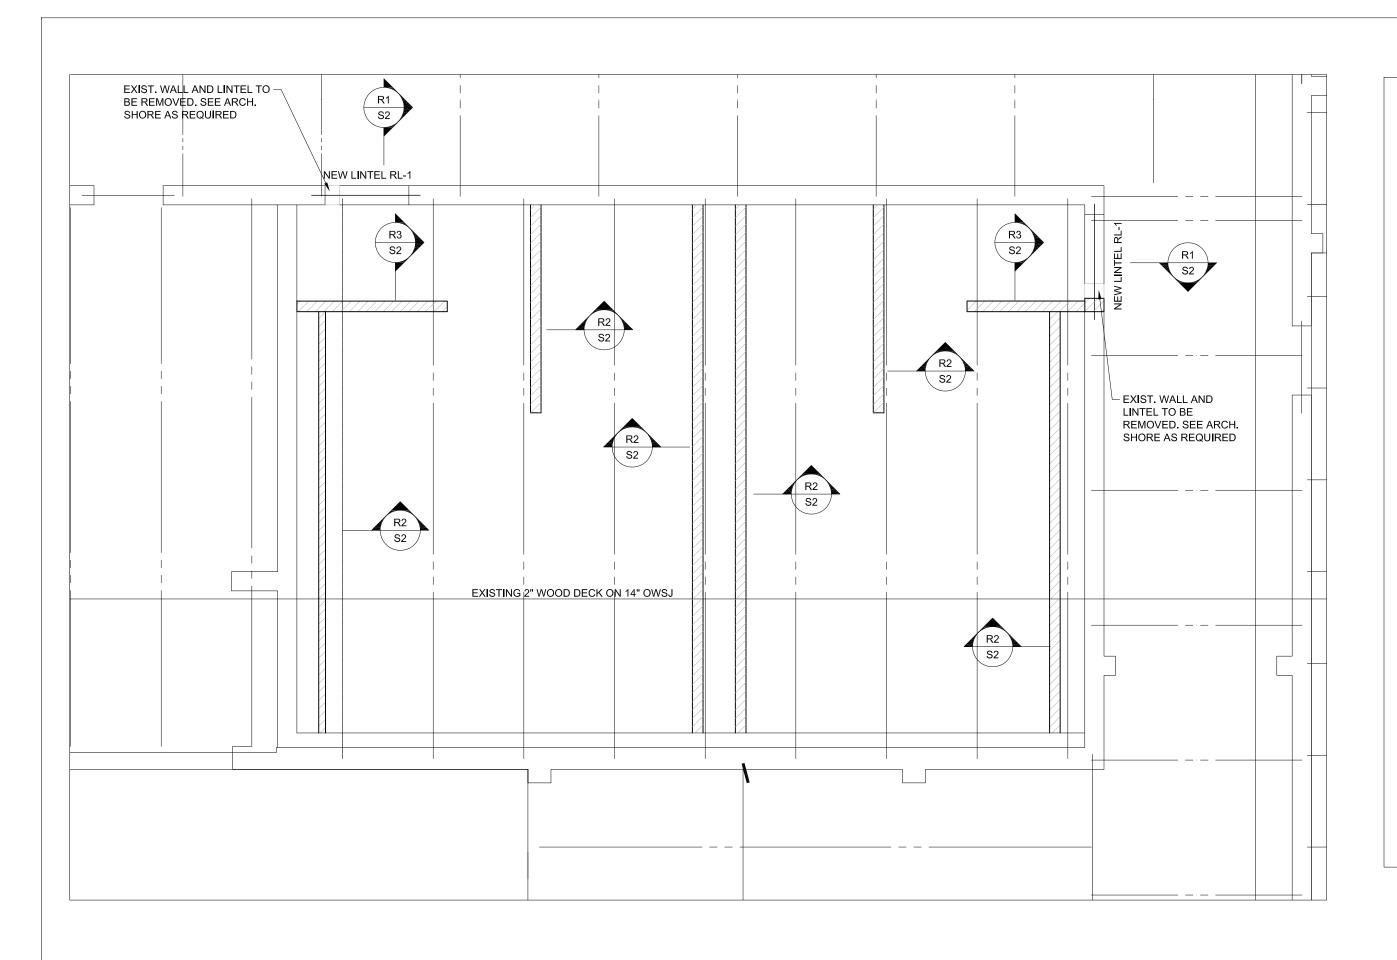
WATERLOO REGION DISTRICT SCHOOL BOARD 184 TAIT ST., CAMBRIDGE, ON N1S 3G3 PART GROUND FLOOR PLAN

drawing scale 1:50 ward99 project number VX Engineering project number 2405 - TAIT CEILINGS 23013 - WRDSB TAIT ST CEILINGS ward99

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drawing no.



PART ROOF FRAMING PLAN

- 1. FOR ROOF SLOPES AND ELEVATIONS SEE ARCHITECTURAL DRAWINGS.
- ROOF STRUCTURE IS EXISTING UNLESS NOTED OTHERWISE. EXISTING FRAMING DATA ARE TAKEN FROM THE ORIGINAL DRAWINGS DESIGNED BY JOHN F. ROSS ARCHITECT ON YEAR 1958. REPORT TO CONSULTANTS DISCREPANCIES AND NECESSARY ADJUSTMENTS DUE TO ACTUAL CONDITIONS BEFORE PROCEEDING WITH WORK...
- 3. SPECIFIED SNOW LOAD IS 1.68kN/m2. ADD DRIFT SNOW AS SHOWN. MULTIPLY SNOW LOADS BY IMPORTANCE FACTOR SEE IMPORTANCE FACTOR TABLE.
- 4. SEE ALSO TYPICAL DETAILS AND GENERAL NOTES ON THESE DRAWINGS.
- 5. UNLESS NOTED OTHERWISE PROVIDE 170 X 12 X 200 BEARING PLATES EACH END OF ALL STEEL BEAMS. ALL BEARING PLATES SHALL BE WITH 2-19Ø WELDED ANCHORS X 250 LG. WELD BEAM TO BEARING PLATES TYPICAL.
- REFER TO OTHER CONSULTANTS DRAWINGS AND SPECIFICATIONS FOR ROOF MOUNTED OR SUSPENDED UNITS. SHOW THE UNITS ON THE STEEL FABRICATORS SHOP DRAWINGS AND OBTAIN ARCHITECTS, MECHANICAL AND OR ELECTRICAL ENGINEERS APPROVAL OF WEIGHTS AND LOCATIONS BEFORE FABRICATION IS STARTED.
- UNLESS NOTED OTHERWISE FOR LINTELS OVER MECHANICAL WALL OPENINGS REFER TO "LINTELS FOR DUCTS AND SERVICES" ON TYPICAL DETAIL SHEET. FOR ALL NEW LINTELS IN EXISTING WALLS CONFIRM WALL THICKNESS BEFORE LINTELS ARE FABRICATED. REFER TO ARCHITECTURAL AND MECHANICAL DRAWINGS FOR EXACT LOCATIONS.
- 8. BLOCK VOIDS WITH REINFORCING OR SHOWN AS "FILLED SOLID" SHALL BE FILLED WITH 20MPa CONCRETE WITH PEA GRAVEL OR 20MPa COARSE GROUT.
- 9. WIND LOAD PARAMETERS, AS PER OBC 2012 AND CHANGES 2020, PART 4, $\frac{1}{50}$ WIND PRESSURE 0.36kPa, $\frac{1}{50}$ WIND PRESSURE 0.28kPa.
- 10. SEISMIC LOAD PARAMETERS, AS PER OBC 2012 AND CHANGES 2020, PART 4, EQUIVALENT STATIC ANALYSIS, SHEAR WALL SYSTEM. Sa(0.2)=0.141, Sa(0.5)=0.084, Sa(1.0)=0.047, Sa(2.0)=0.024, Sa(5.0)=0.0058, Sa(10.0)=0.0024, Fa=1.24, Fv=1.55, Ie=1.3, Rd=1.5, Ro=1.5. SOIL CLASS D (ASSUMED), IeFaSa(0.20)=0.227<0.35
- 11. REFER TO "IMPORTANCE FACTOR" TABLE.
- SHORE AS REQUIRED.

IMPORTANCE FACTOR CATEGORY `HIGH'					
	ULS	SLS			
SNOW	1.15	0.9			
WIND	1.15	0.75			
EARTHQUAKE	1.3	1.0			

	ROOF NEW LIN	ITEL SCHED	ULE
MARK	MATERIAL	TYPE	REMARKS
NEW RL-1	W200 X 27 + 240 X 8 PL. BOTT.	EXIST. WALL	STOP BOTT. PL. SHORT OF OPENING & PROVIDE TYPICAL BEARING PLATE E.E. EXTEND 200mm EACH END BUILD TIGHT TO U/S OF EXIST. W

LINTEL NOTES:

- A. GENERAL CONTRACTOR SHALL PROVIDE 38 X 5 X 150 MASONRY TIES WELDED TO BM AT 600 c/c TYP. FOR ALL BEAM LINTELS AND BEAMS IN MASONRY
- B. PROVIDE 1-190 A. BOLTS X 200 LG GROUTED INTO BLOCK VOIDS OF PIERS
- BETWEEN OPENINGS. WHERE APPLICABLE. C. UNLESS NOTED OTHERWISE BOTT. PLATE OF BEAM LINTELS
- SHALL STOP SHORT OF OPENINGS AND BEAM BEARING PLATE SHALL BE PROVIDED. D. FIRST BLOCK COURSE ABOVE STEEL LINTEL SHALL BE FILLED SOLID WITH 20MPa CONCRETE. TYP.




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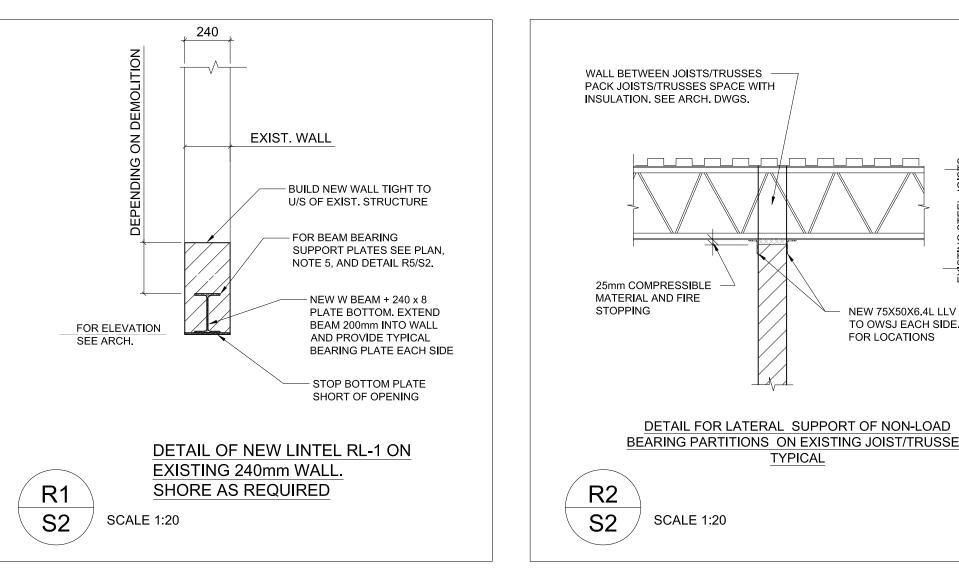
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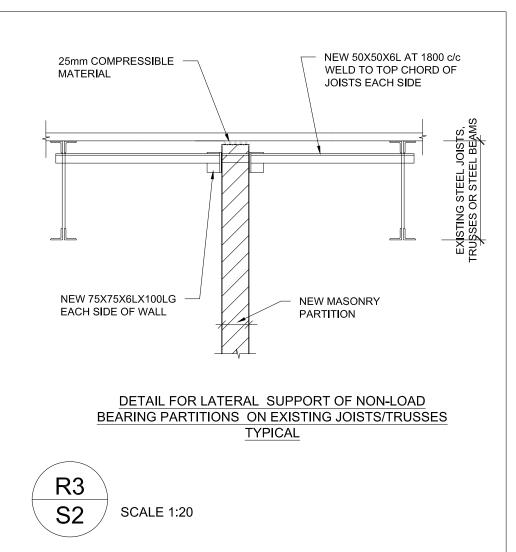
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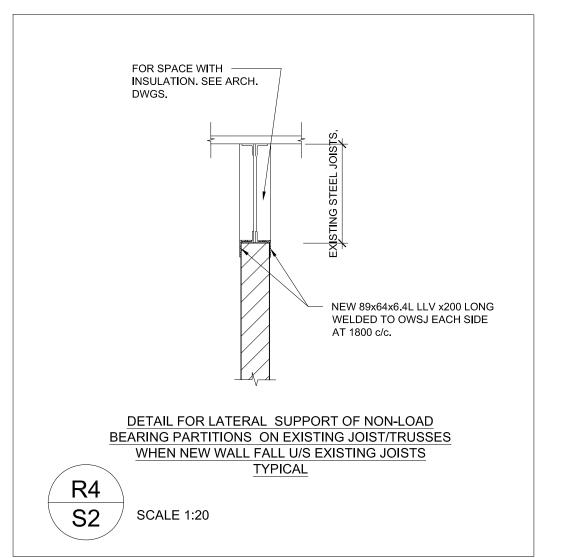
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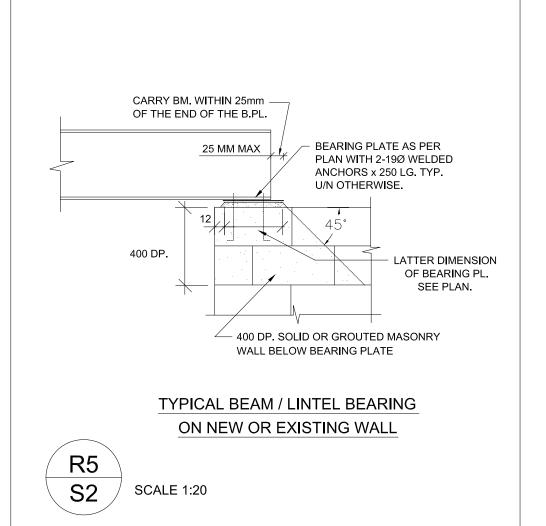
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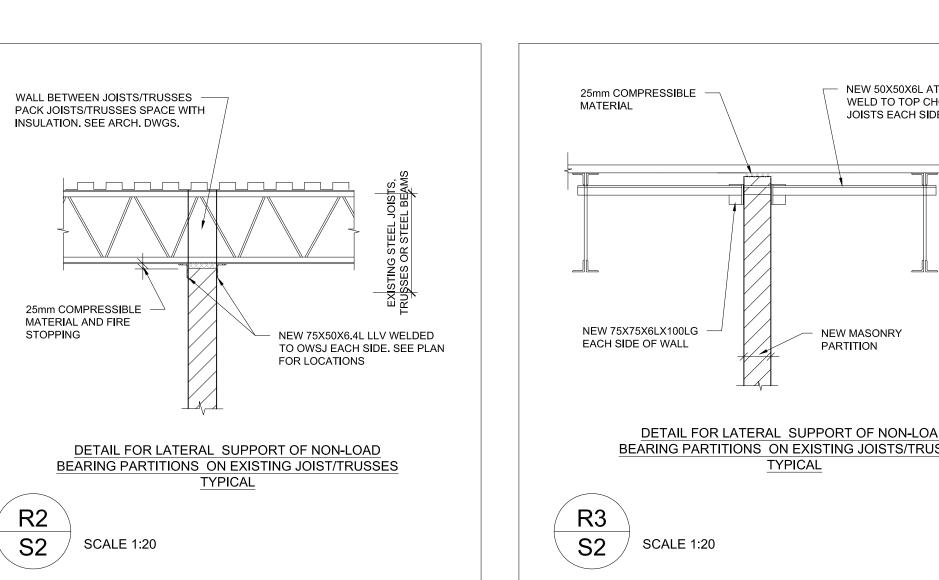
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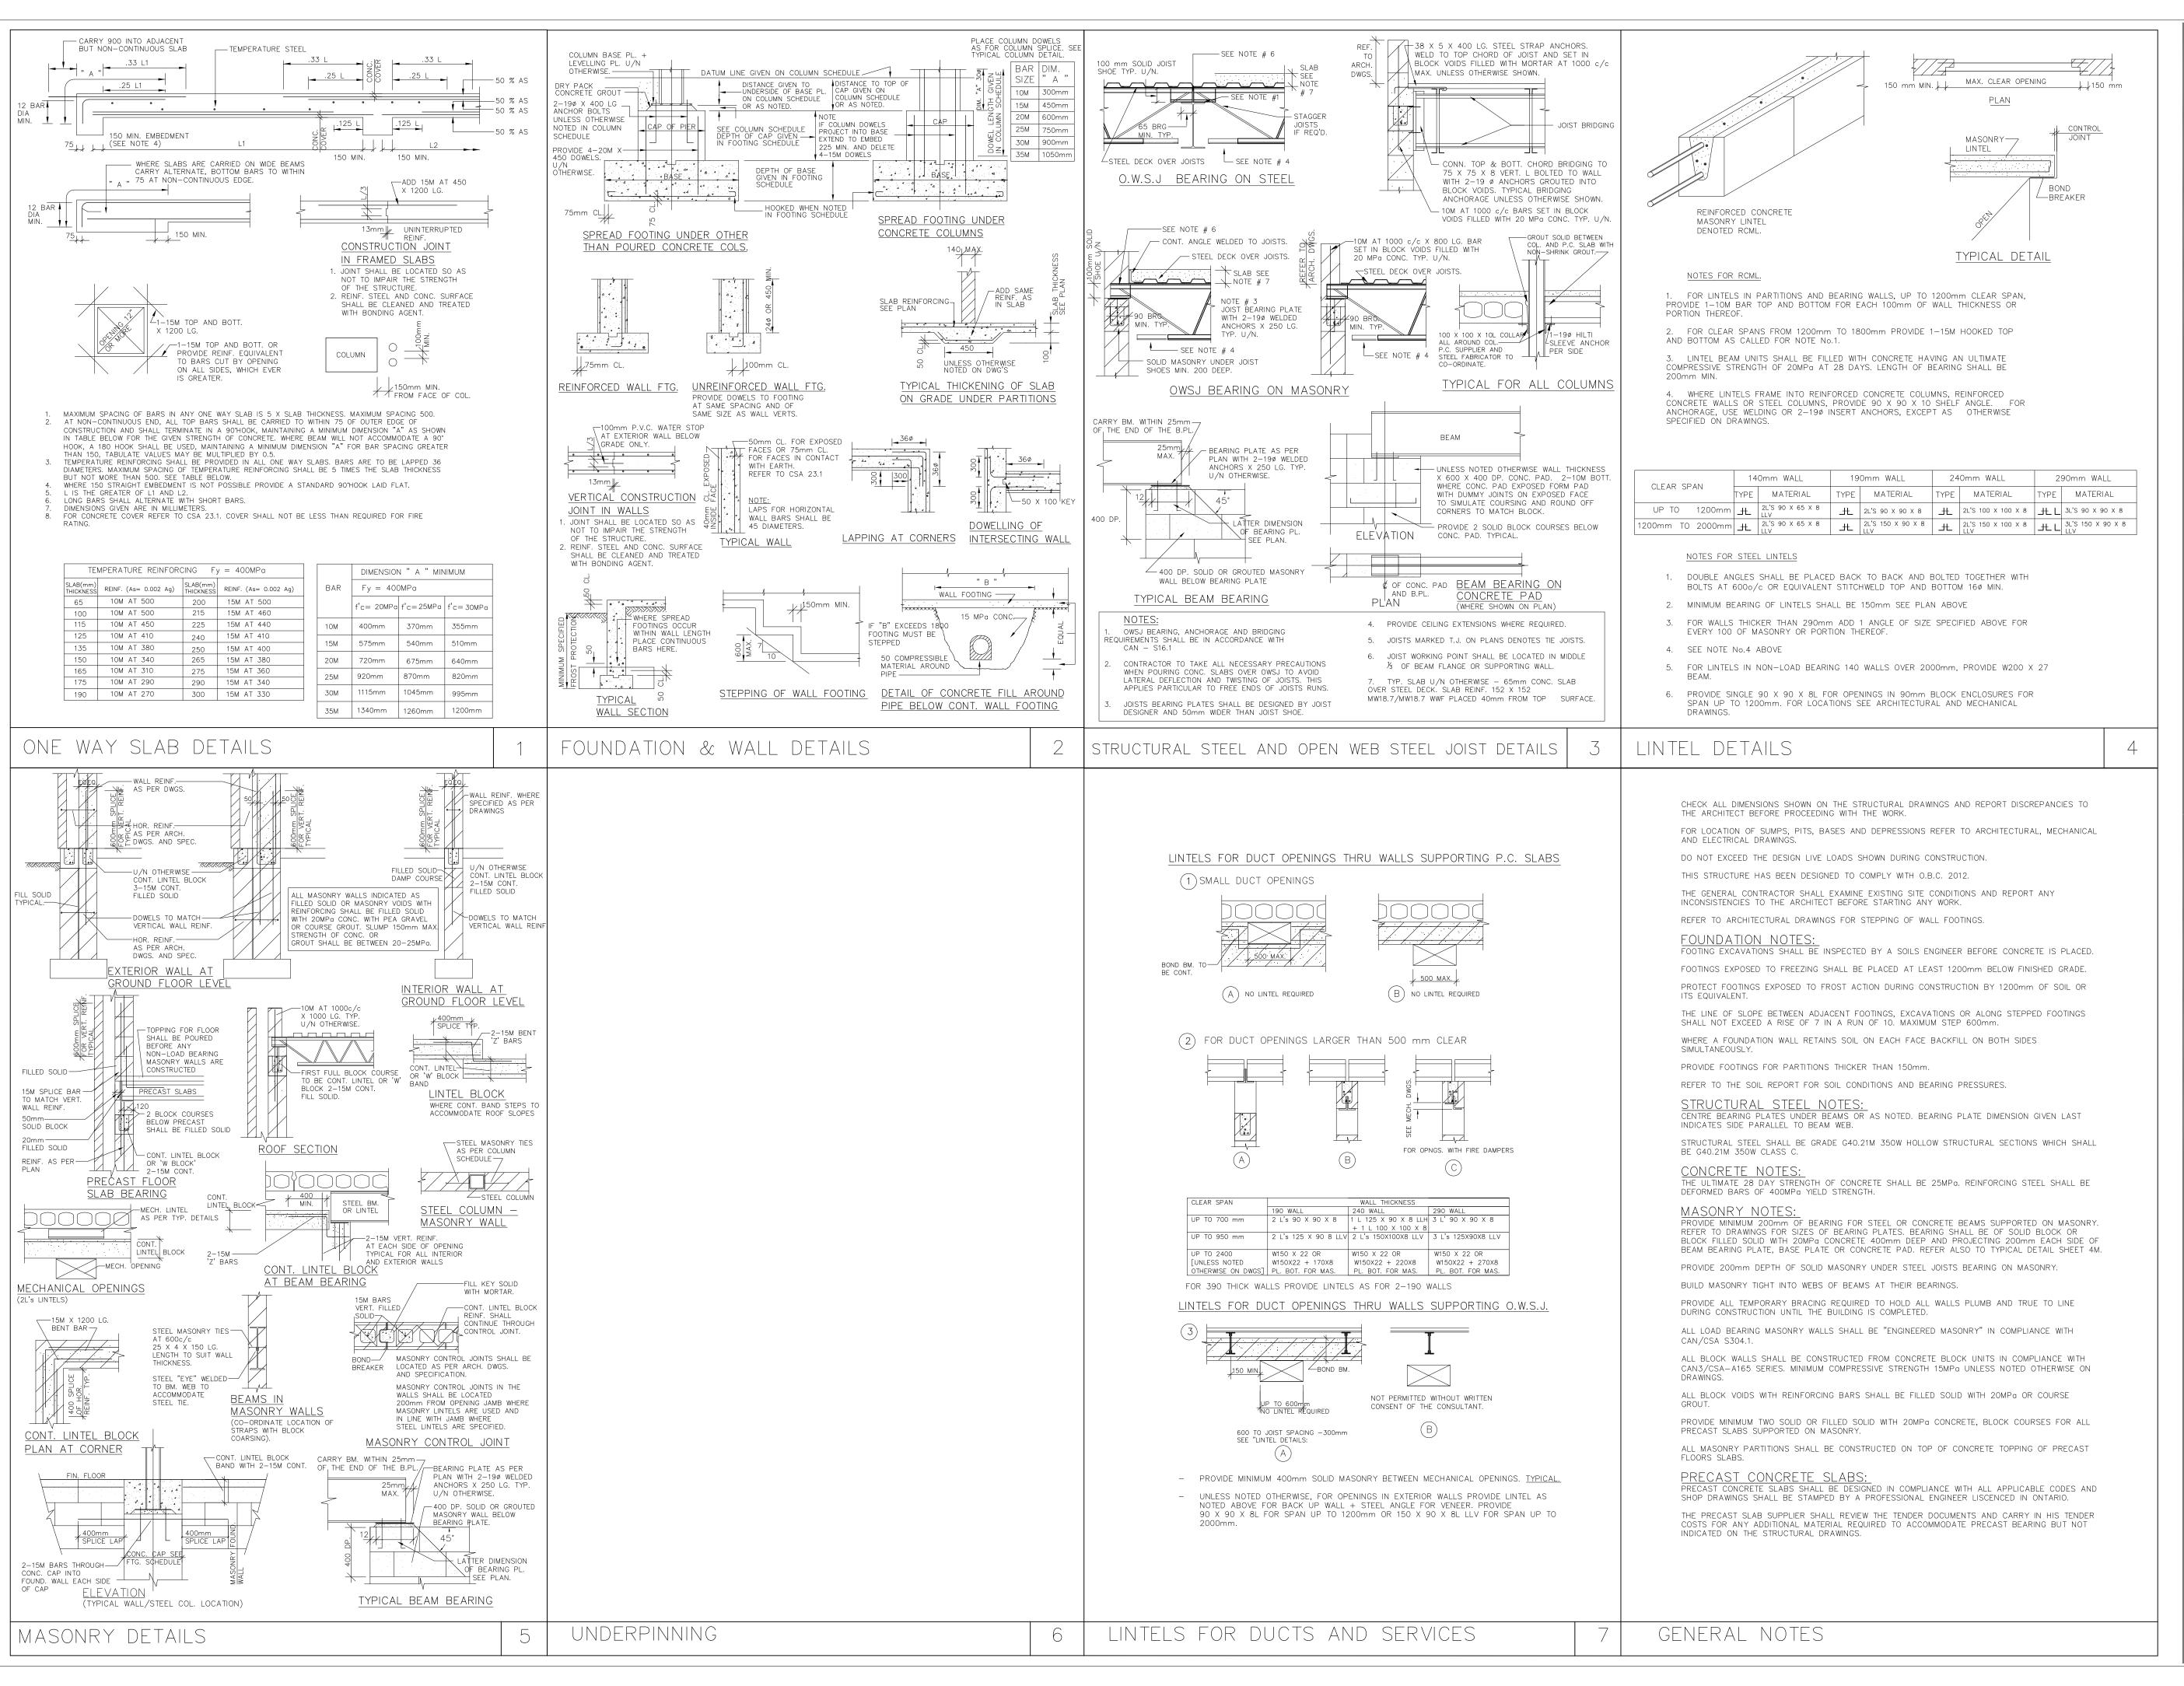








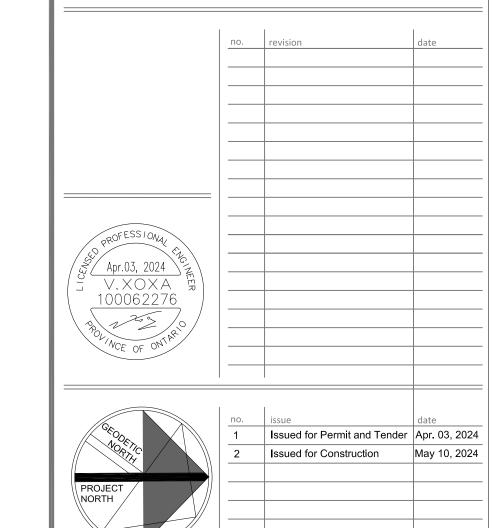



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