

#### HUNTER STREET

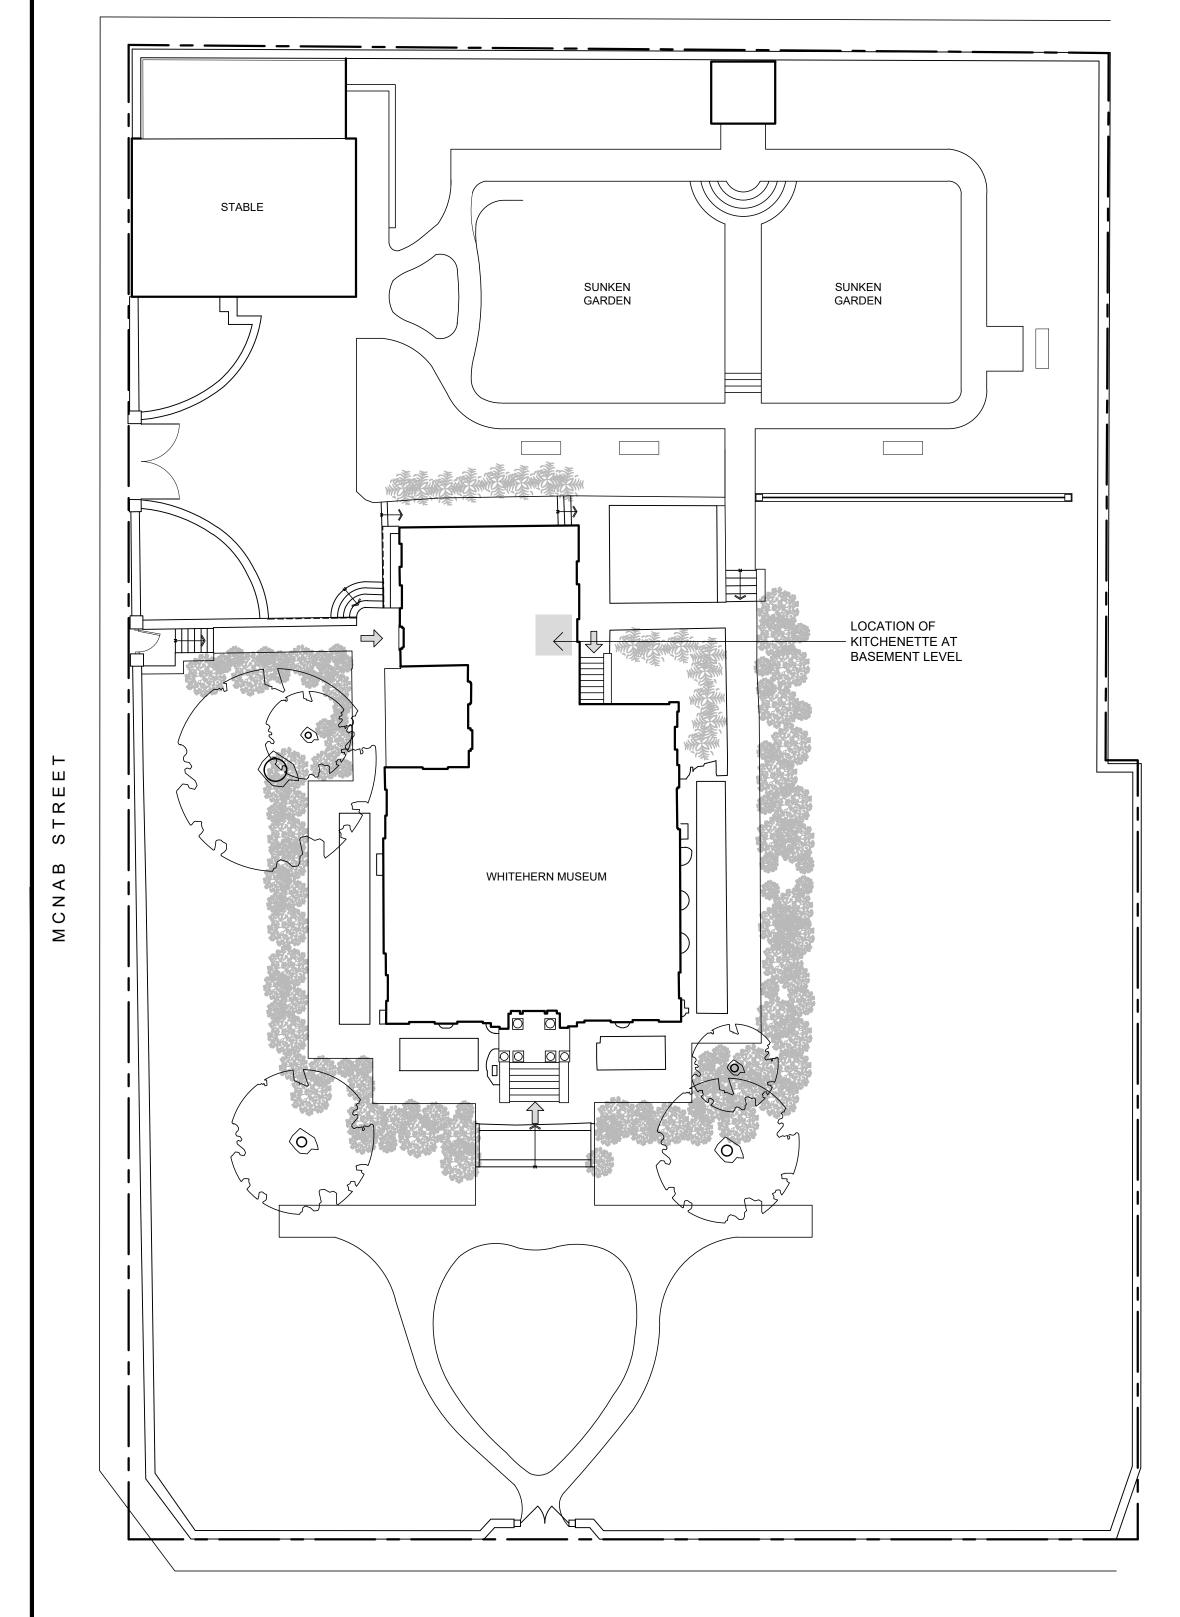

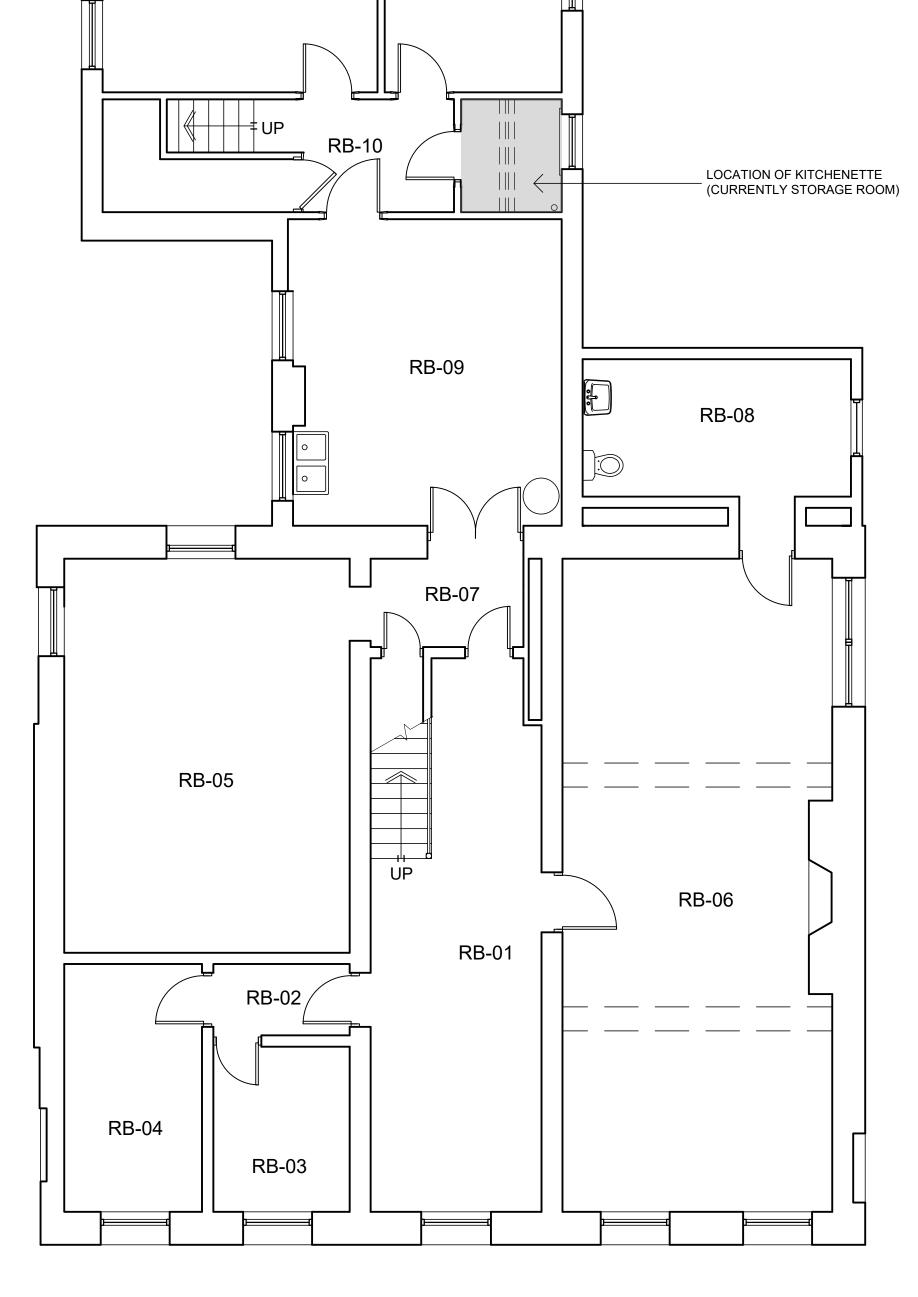

RB-12

RB-11

# **DRAWING LIST:**

# ARCHITECTURAL:

SITE & BASEMENT KEY PLAN

CABINET PLAN & ELEVATIONS A102a DRAWER PLAN

DOOR PLAN

SECTION DETAILS

# MECHANICAL:

MECHANICAL NOTES,

SCHEDULES, DETAILS,

# ELECTRICAL:

FLOOR PLAN, LEGEND,

**DETAILS & SPECIFICATIONS** 




# CITY OF HAMILTON

# GEORGE ROBB ARCHITECT

PLUMBING & FIRE PROTECTION
SPECIFICATIONS

4800 DUNDAS STREET WEST, SUITE 201
TORONTO ONTARIO M9A 1B1
(TEL) 416-596-8301
(FAX) 416-596-1508

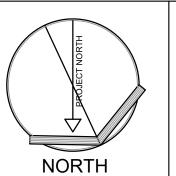



VERIFY DIMENSIONS ON SITE. DRAWINGS ARE PREPARED TO ILLUSTRATE THE GENERAL LAYOUT.
DO NOT SCALE DRAWINGS.

10.	Issue	Date
01	CLIENT COORDINATION	2024.07.29
02	PERMIT/TENDER	2024.09.05

SITE AND KEY PLAN

WHITEHERN HISTORIC HOUSE STAFF KITCHENETTE 41 JACKSON STREET HAMILTON, ON


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SCALE	as shown
DATE	JULY 2024
DRAWN	
CHECKED	
SET NO.	DRAWING NO.


A100

2 KEY PLAN (BASEMENT) A100 1" = 3/16'-0"

JACKSON STREET

SITE PLAN

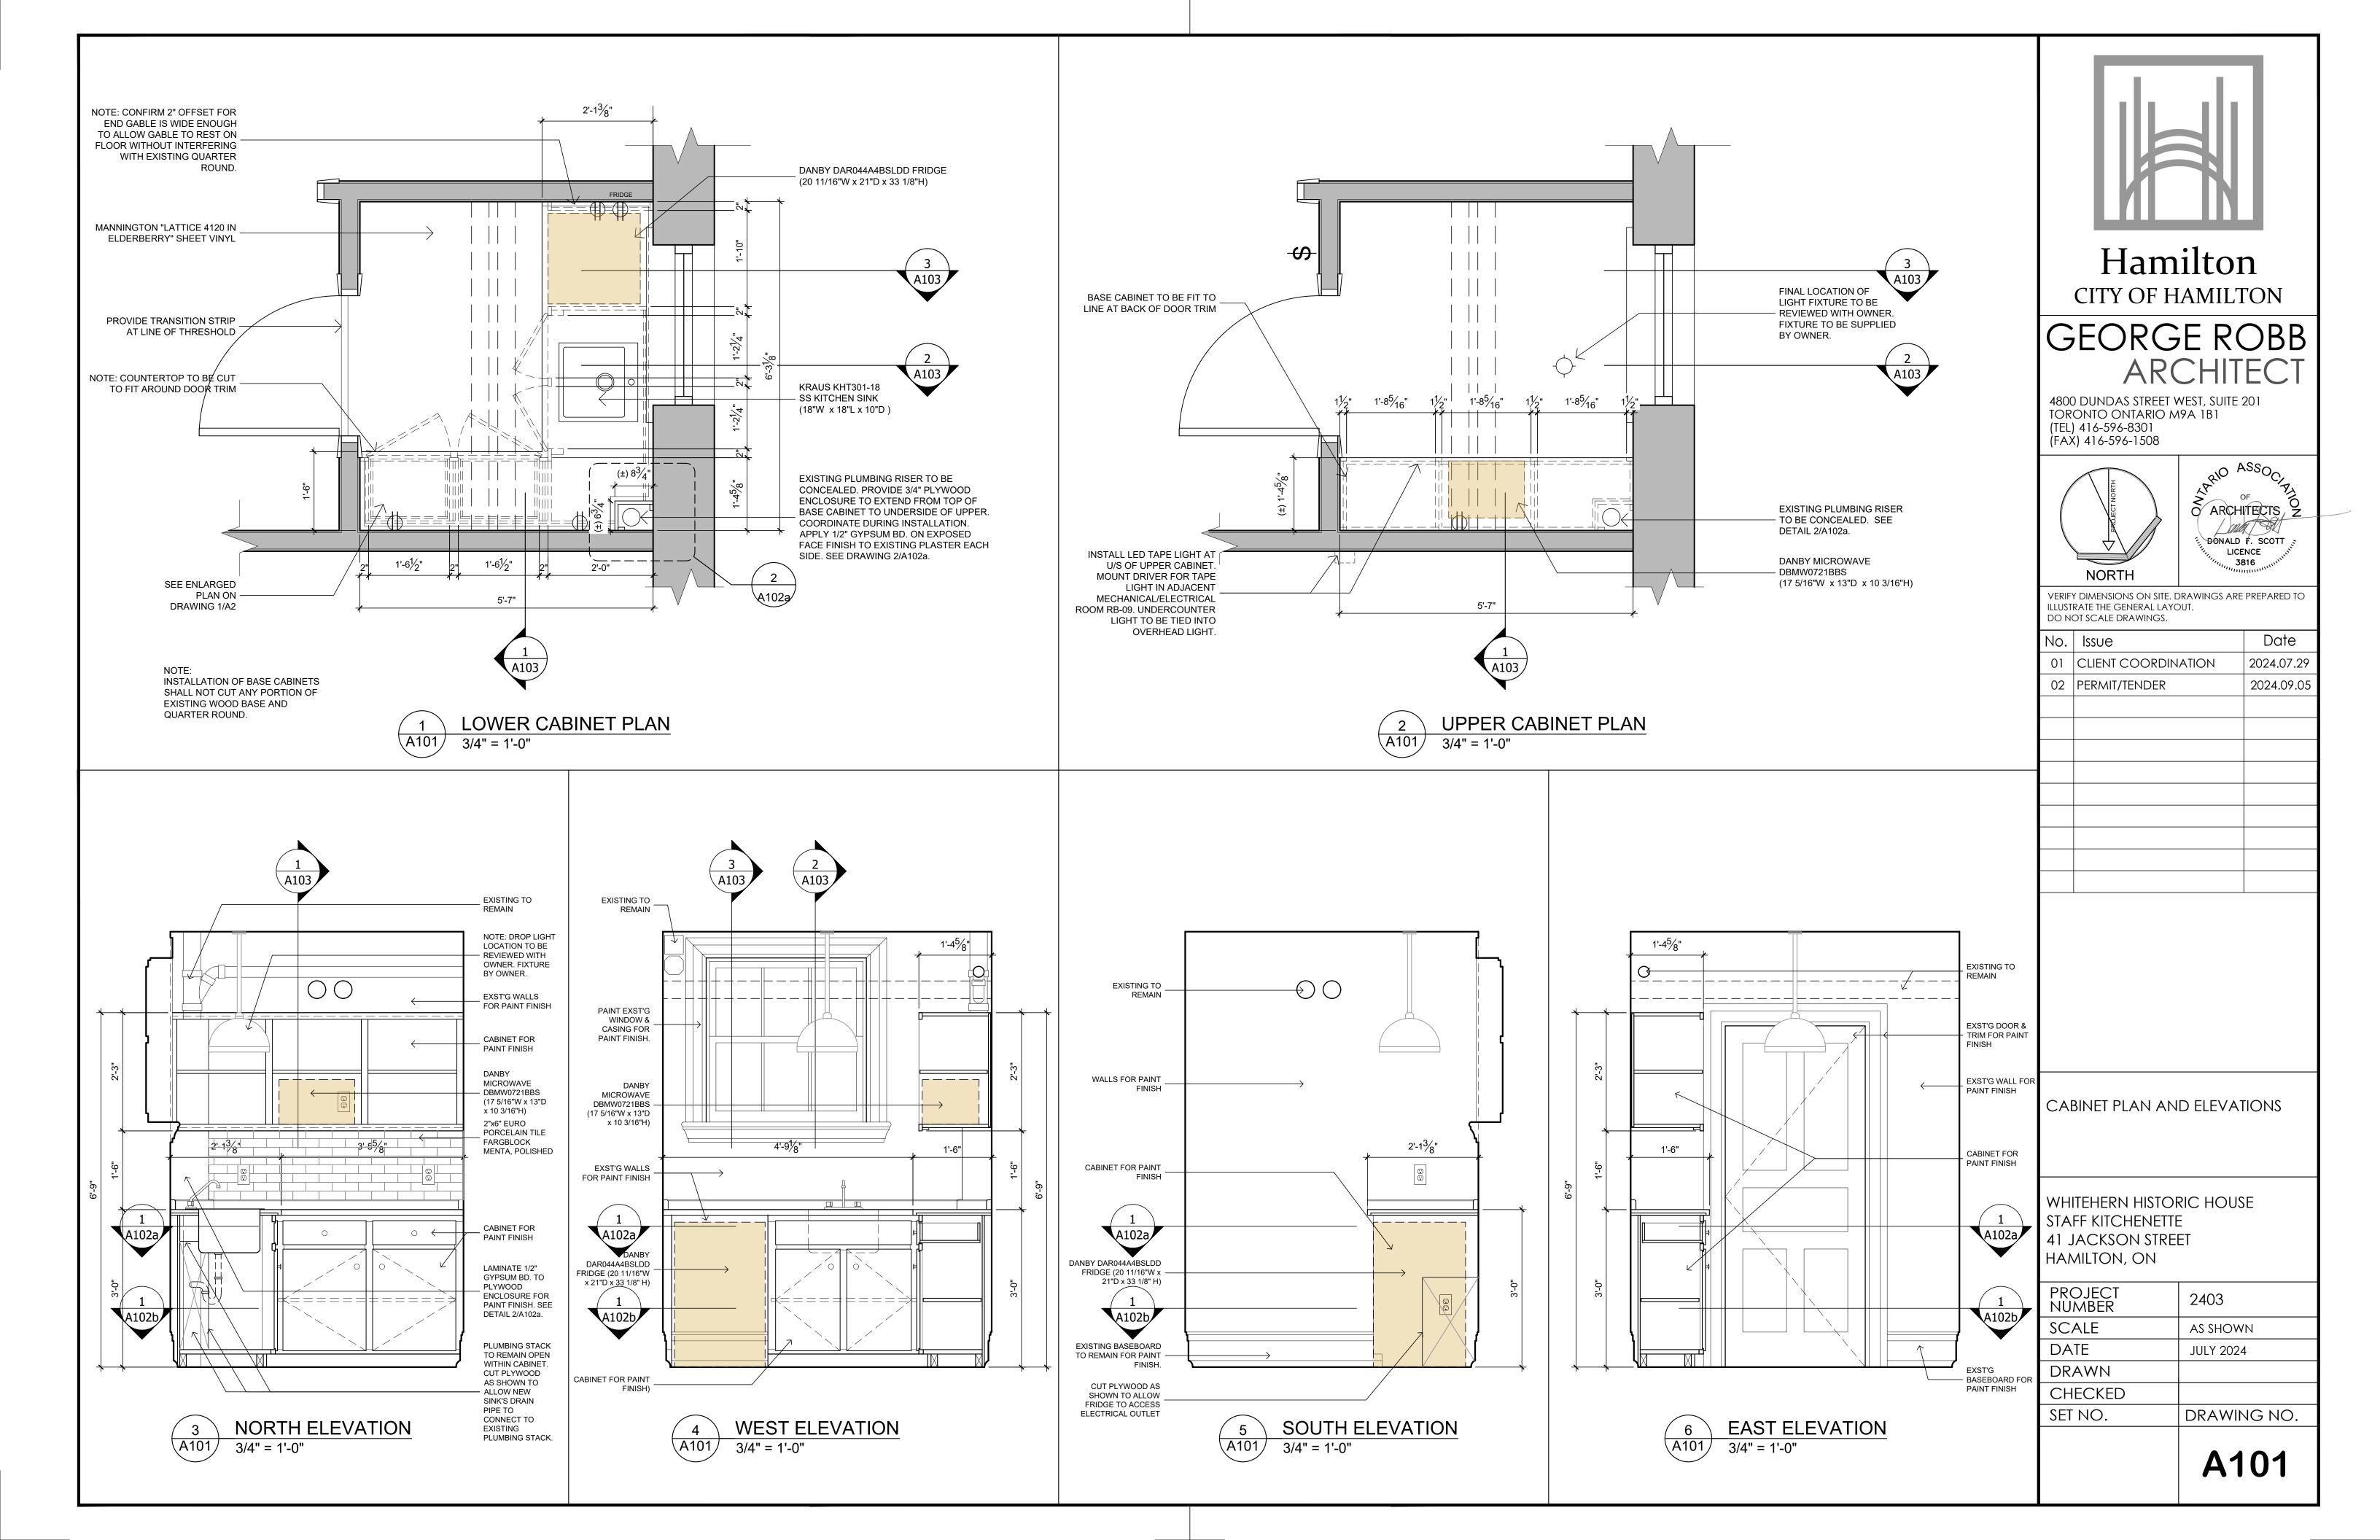

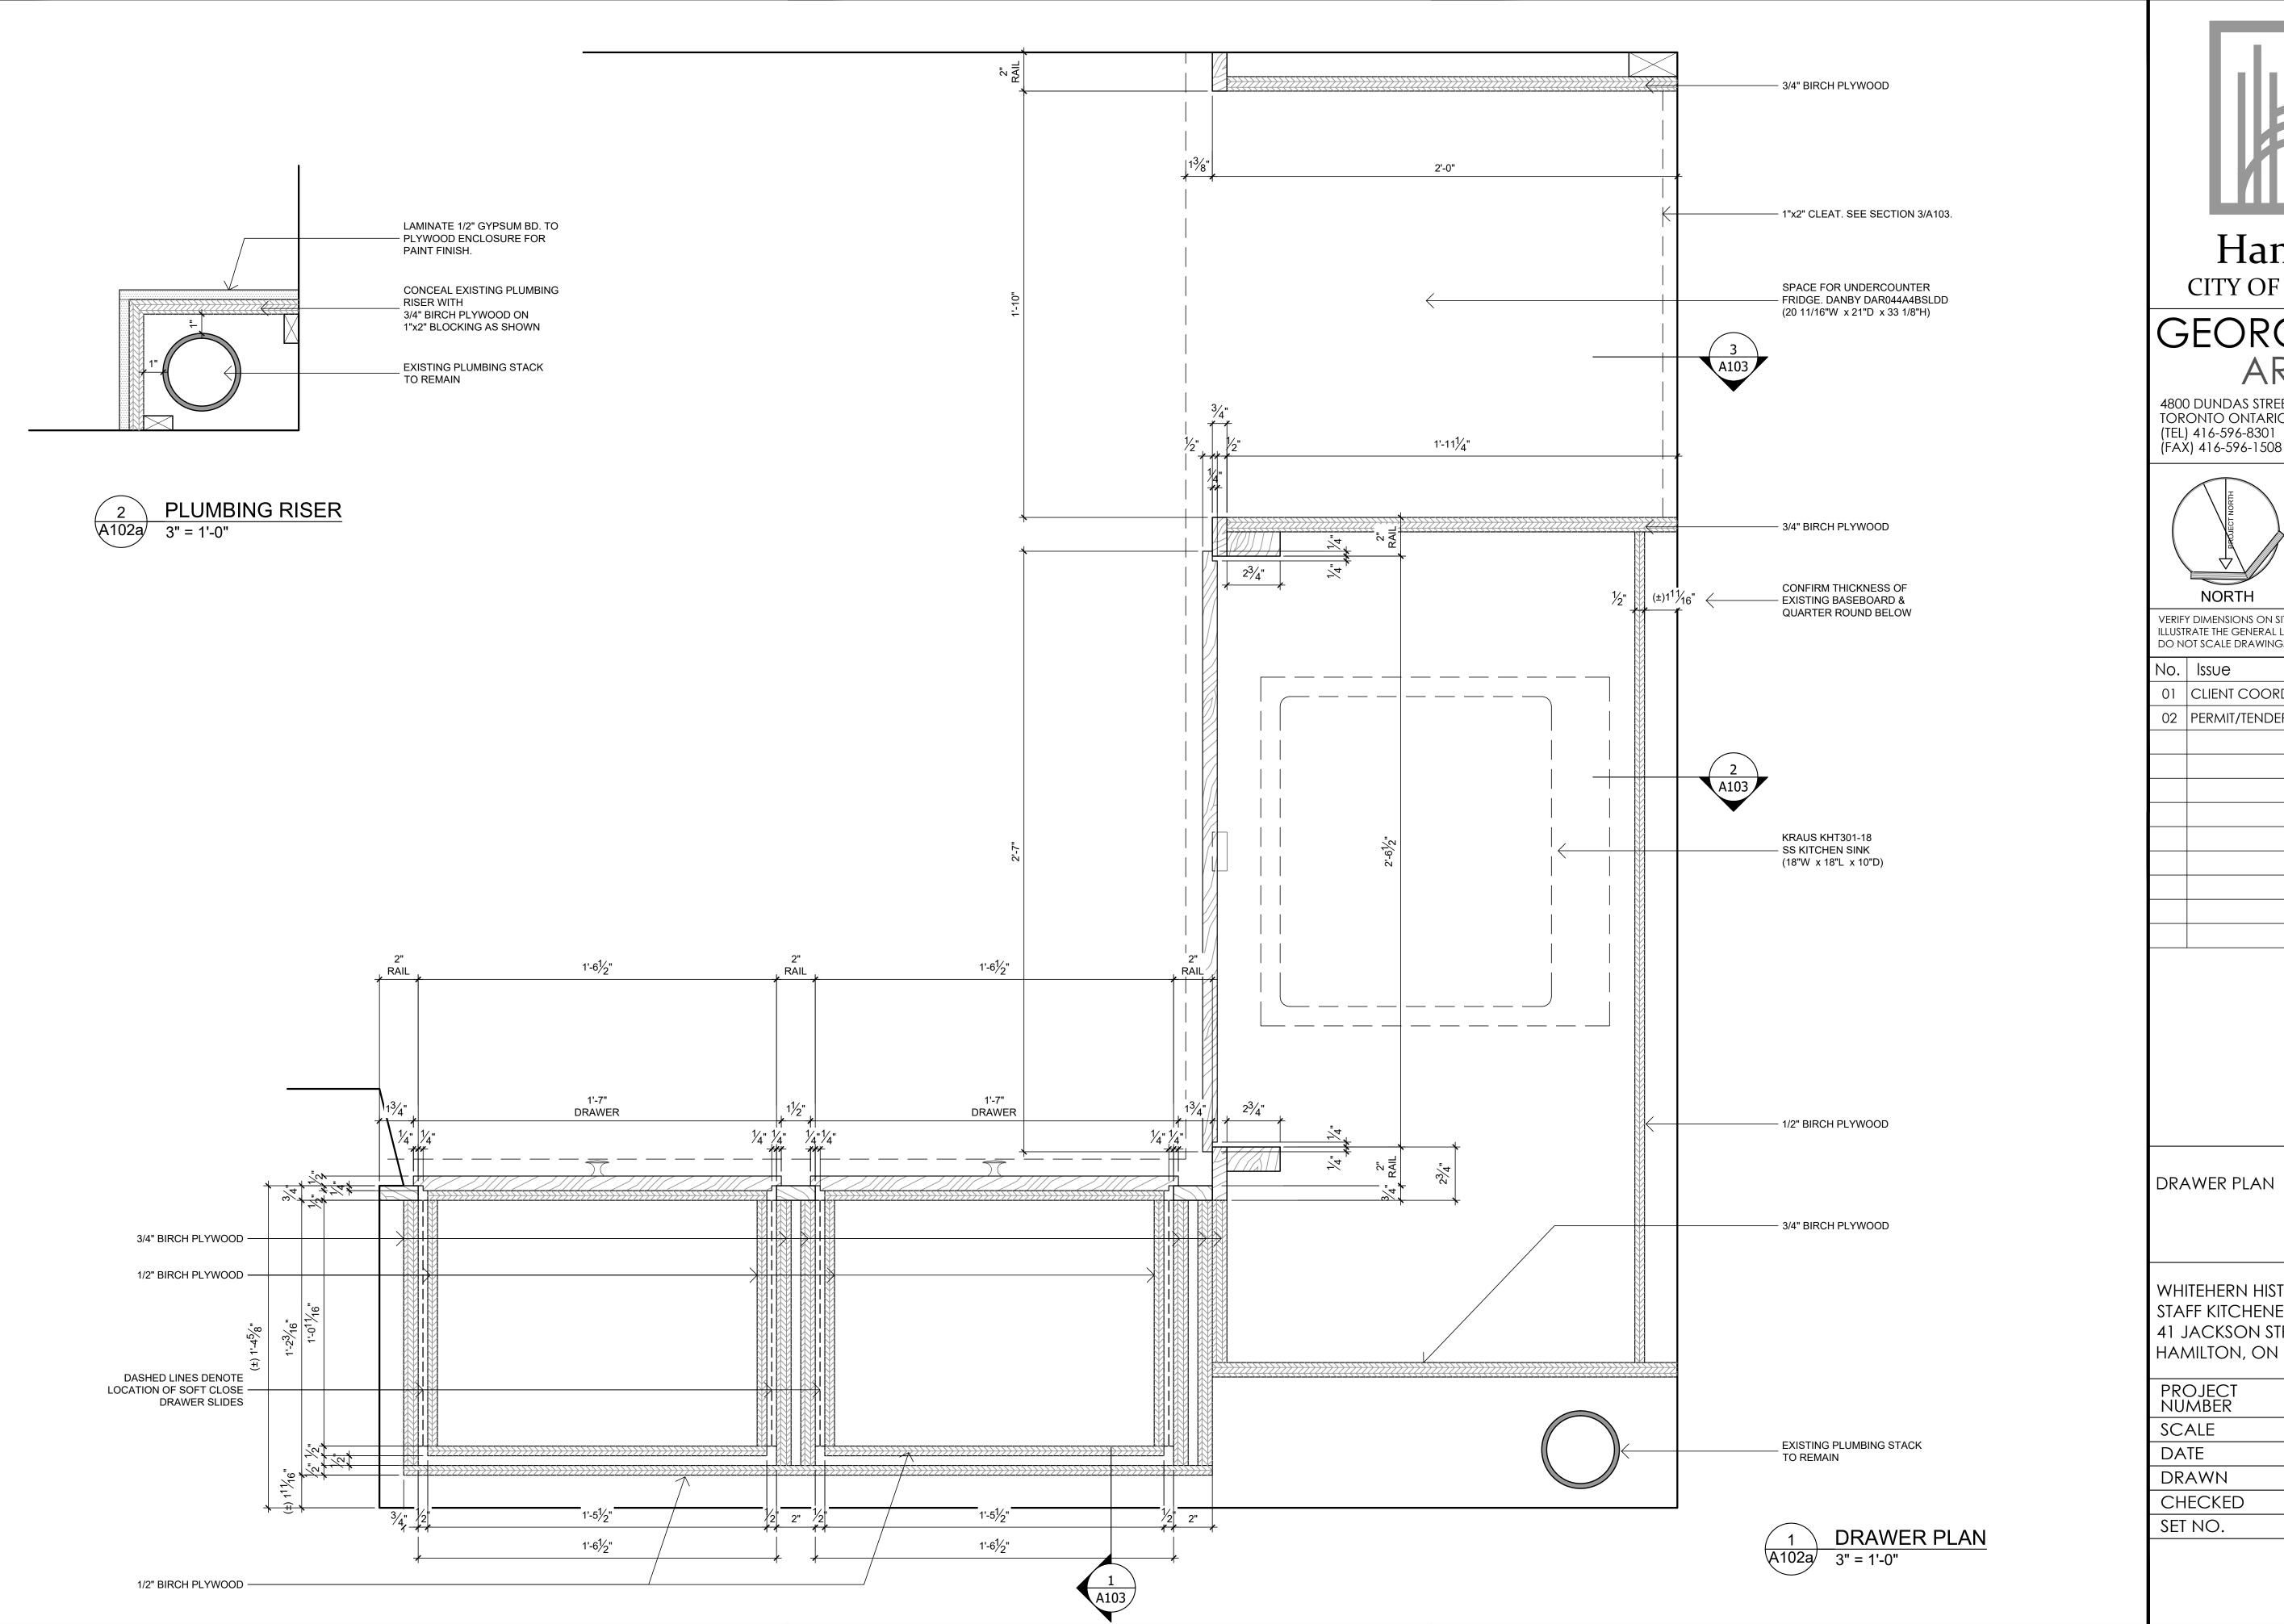



CITY OF HAMILTON

# GEORGE ROBB ARCHITECT

4800 DUNDAS STREET WEST, SUITE 201 TORONTO ONTARIO M9A 1B1 (TEL) 416-596-8301 (FAX) 416-596-1508




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DO NOT SCALE DRAWINGS.

Issue	Date
CLIENT COORDINATION	2024.07.29
PERMIT/TENDER	2024.09.05

WHITEHERN HISTORIC HOUSE STAFF KITCHENETTE 41 JACKSON STREET

PROJECT NUMBER	2403
SCALE	as shown
DATE	JULY 2024
DRAWN	
CHECKED	
SET NO.	DRAWING NO.

A102a

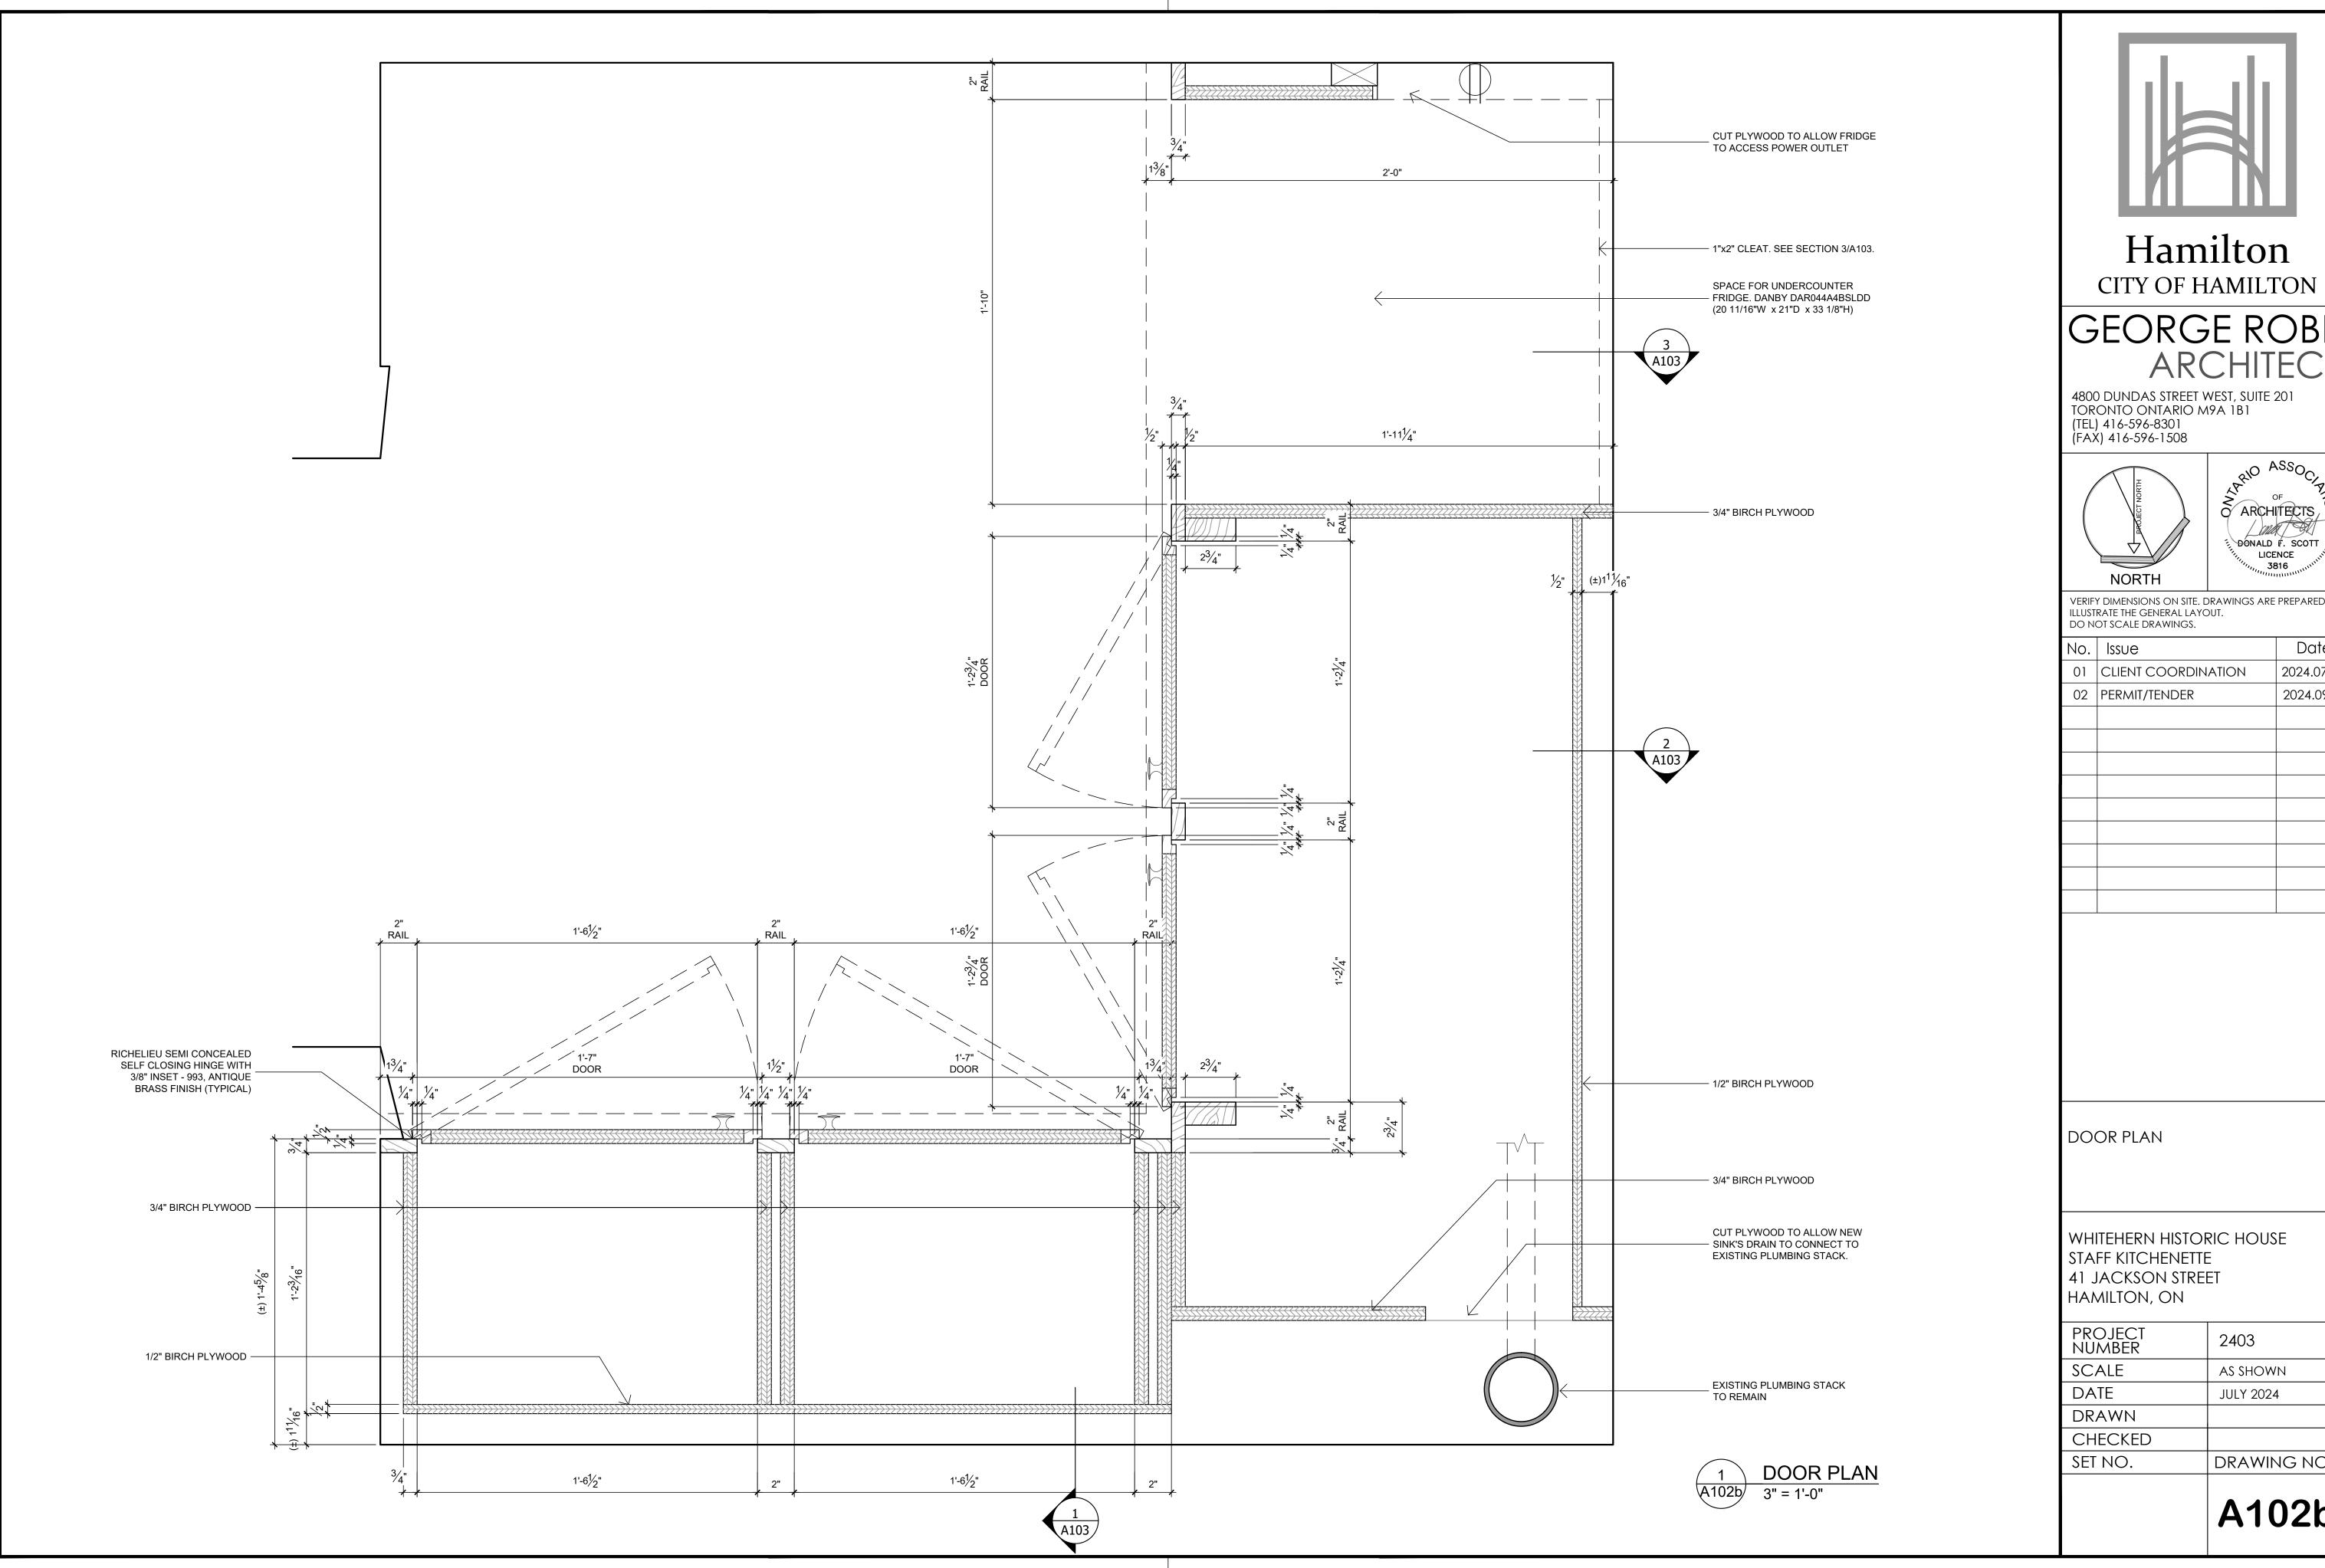



# GEORGE ROBB ARCHITECT

4800 DUNDAS STREET WEST, SUITE 201 TORONTO ONTARIO M9A 1B1 (TEL) 416-596-8301 (FAX) 416-596-1508




VERIFY DIMENSIONS ON SITE. DRAWINGS ARE PREPARED TO ILLUSTRATE THE GENERAL LAYOUT.
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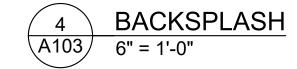
No.	Issue	Date
01	CLIENT COORDINATION	2024.07.29
02	PERMIT/TENDER	2024.09.05


WHITEHERN HISTORIC HOUSE


PROJECT NUMBER	2403
SCALE	as shown
DATE	JULY 2024
DRAWN	
CHECKED	
SET NO.	DRAWING NO.
· ·	

A102b



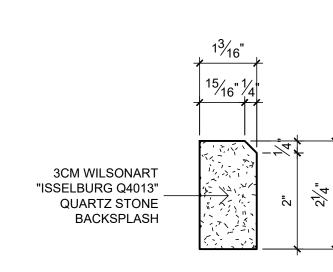

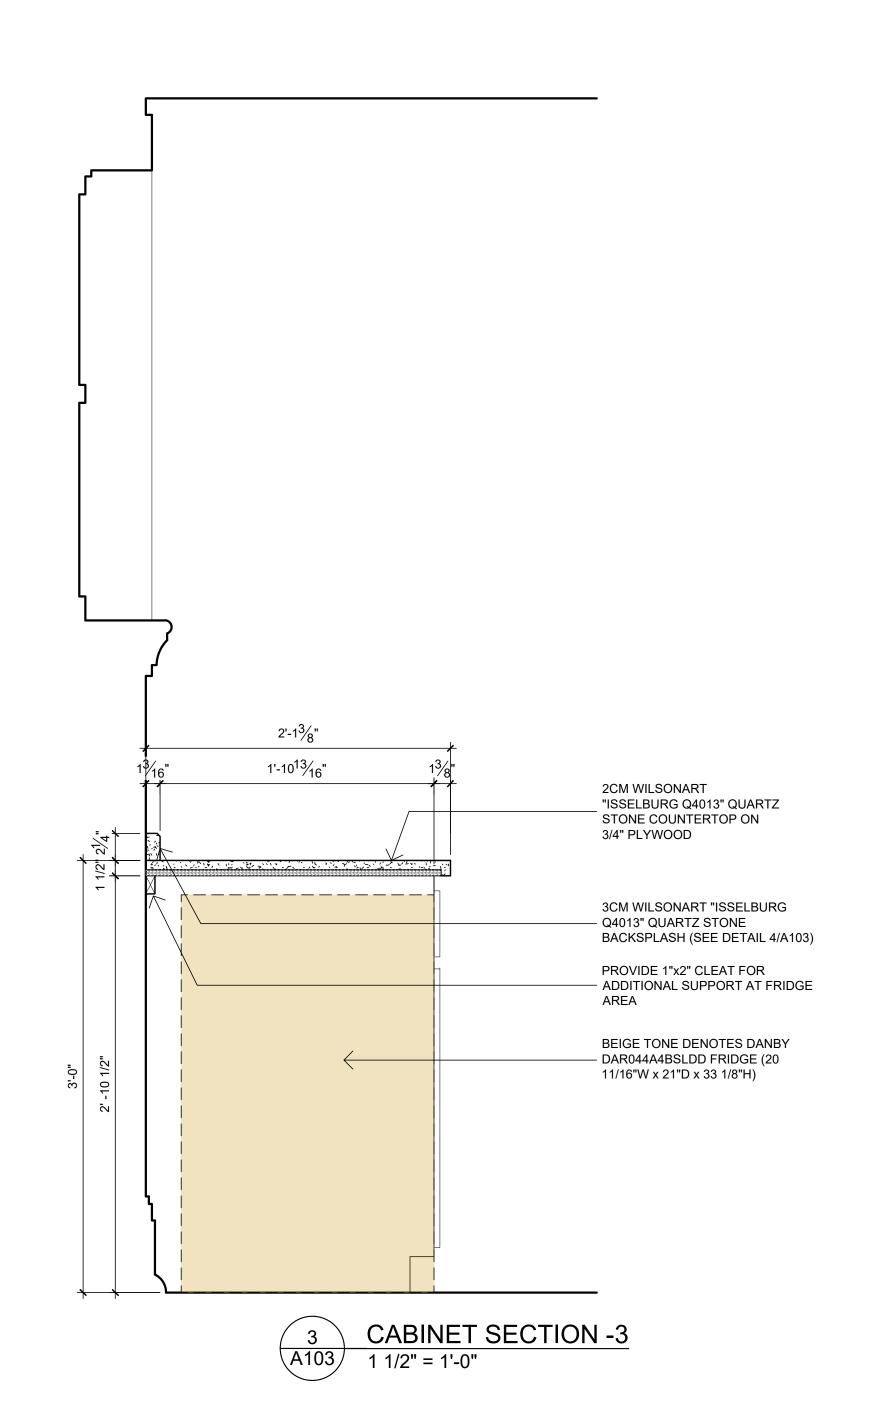

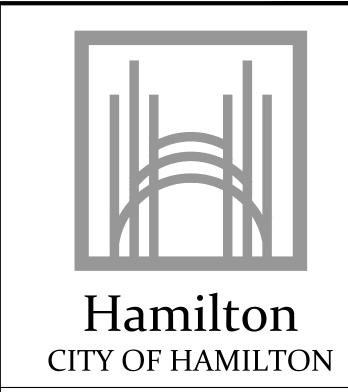

# GEORGE ROBB ARCHITECT

4800 DUNDAS STREET WEST, SUITE 201 TORONTO ONTARIO M9A 1B1 (TEL) 416-596-8301 (FAX) 416-596-1508



VERIFY DIMENSIONS ON SITE. DRAWINGS ARE PREPARED TO ILLUSTRATE THE GENERAL LAYOUT.
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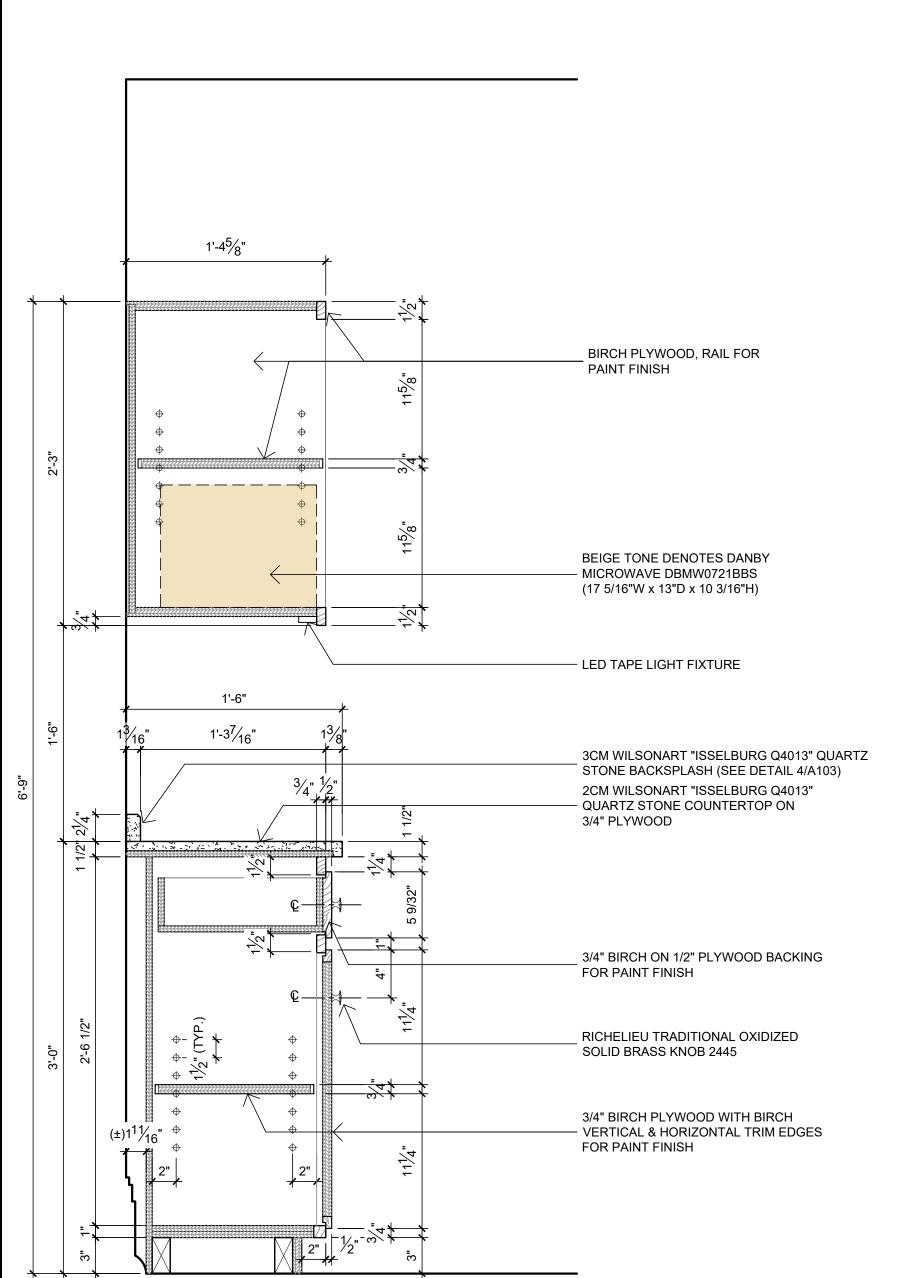
0.	Issue	Date
01	CLIENT COORDINATION	2024.07.29
02	PERMIT/TENDER	2024.09.05

# SECTION DETAILS

WHITEHERN HISTORIC HOUSE STAFF KITCHENETTE 41 JACKSON STREET HAMILTON, ON


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SCALE	as shown
DATE	JULY 2024
DRAWN	
CHECKED	
SET NO.	DRAWING NO.

A103




**CABINET SECTION -1** 

A103) 1 1/2" = 1'-0"

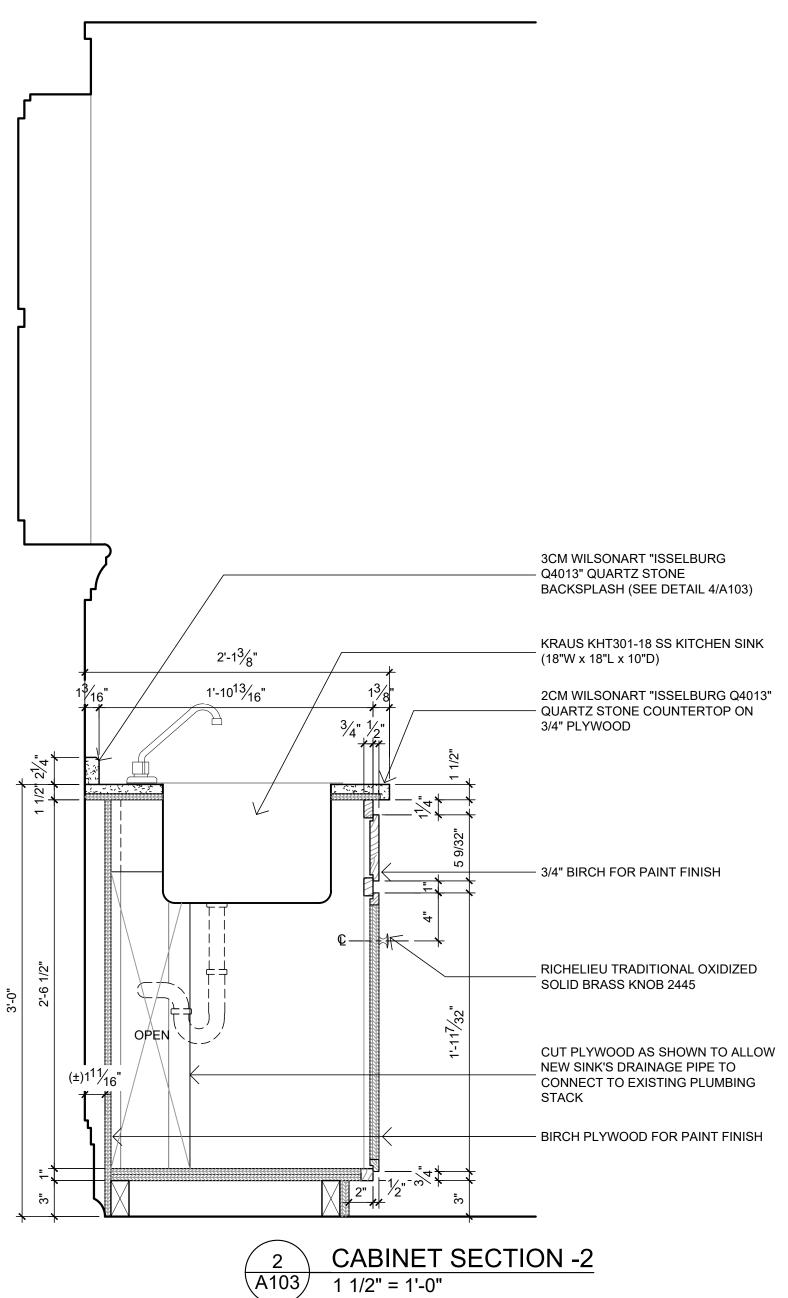

ITEM	DESCRIPTION
11 [11]	
	NEW ITEM
	EXISTING ITEM TO REMAIN
	BELOW FLOOR PIPING
	POTABLE (DOMESTIC) COLD WATER (DCW)
	POTABLE (DOMESTIC) HOT WATER (DHW)
——SAN—	SANITARY DRAIN
—⋈—	GATE VALVE
—б	BALL VALVE
	BACKFLOW PREVENTER
DCVA	DOUBLE CHECK VALVE ASSEMBLY
RP	REDUCED PRESSURE ASSEMBLY
o—	ELBOW TURNED UP
<del>с</del> —	ELBOW TURNED DOWN
<b>5</b>	PIPE SINGLE LINE CUTOFF
<b>—</b> □co	FLOOR CLEAN OUT
—II <sup>co</sup>	WALL CLEAN OUT
FD <b>Ø</b> C	FLOOR DRAIN; FFD: FUNNEL FLOOR DRAIN; HD: HUB DRAIN
<b>⊗</b> FEX	FIRE EXTINGUISHER
<del>•</del>	NEW CONNECTION TO EXISTING

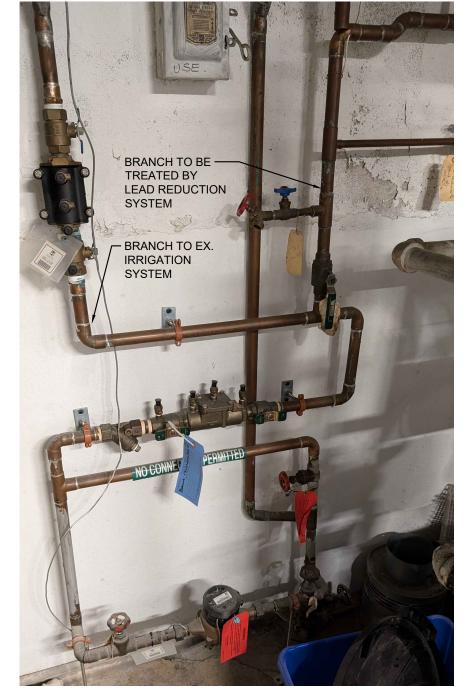

LEAD REDUCTION INSTALLATION REFERENCE DETAIL


#### GENERAL NOTES: (APPLICABLE TO ALL DRAWINGS)

- THESE DRAWINGS ARE AN INTEGRAL PART OF THE SPECIFICATIONS WHICH ACCOMPANY THEM.
- ALL MATERIALS AND WORKMANSHIP SHALL BE NEW UNLESS NOTED OTHERWISE, FREE OF DEFECTS, AND COMPLY WITH ALL APPLICABLE STANDARDS.
- ALL DIMENSIONS ARE IN INCHES UNLESS NOTED OTHERWISE
- INSTALL PIPING TIGHT TO UNDERSIDE OF STRUCTURE UNLESS NOTED OTHERWISE.
- DO NOT SCALE DRAWINGS. OBTAIN ALL DIMENSIONS FROM EXISTING ARCHITECTURAL PLANS, SITE INSPECTIONS, AND MANUFACTURER'S SHOP
- REFER TO ARCHITECTURAL DRAWINGS FOR LOCATION OF FIRE RATED ASSEMBLIES.
- OPENINGS IN EXTERIOR WALLS AND ROOF ARE TO BE PROPERLY FLASHED AND MADE WEATHERPROOF.
- ALL NECESSARY CUTTING / PATCHING FOR MECHANICAL WORK SHALL BE PROVIDED BY APPROPRIATE TRADE(S) AT CONTRACTOR'S EXPENSE UNLESS NOTED OTHERWISE.
- MAKE GOOD ALL BUILDING COMPONENTS DAMAGED BY WORK OF THIS TRADE TO THE CONSULTANT SATISFACTION.
- PROVIDE ALL SLEEVES, INSERTS AND HANGERS REQUIRED FOR THE WORK. TREAT ALL SLEEVES OR HOLES PIERCING ACOUSTICAL SEPARATIONS FOR INSTALLATIONS OF THIS DIVISION TO MAINTAIN ACOUSTICAL RATING. ALL GAPS SHALL BE PACKED WITH ACOUSTICAL INSULATION AND SEALED AT BOTH ENDS WITH ACOUSTICAL CAULKING. PATCH ALL OPENINGS AROUND INSTALLATIONS OF THIS DIVISION PIERCING FIRE OR SMOKE SEPARATIONS WITH AN APPROVED WATERTIGHT SMOKE AND FIRE STOP SEALANT.
- INSTALL ALL EQUIPMENT & ASSOCIATED PIPING, APPURTENANCES TO PROVIDE MAINTENANCE ACCESS. ALLOW FOR ALL ACCESS DOORS REQUIRED FOR EQUIPMENT INSTALLATIONS & SERVICE. ENSURE PROPER ACCESS DOOR SIZE, TYPE AND FIRE RATING.
- COORDINATE ALL WORK WITH OTHER TRADES AND SUPPLIERS/MANUFACTURERS TO AVOID INTERFERENCES AND CONFLICTS BETWEEN SERVICES. PLAN WORK WELL IN ADVANCE TO ELIMINATE INSTALLATION AND COORDINATE DIFFICULTIES. COOPERATE WITH OTHER TRADES ON SITE TO RESOLVE INTERFERENCES TO SATISFACTORILY COMPLETE THE PROJECT.
- THIS TRADE IS RESPONSIBLE FOR ALL EXCAVATION / BACKFILL REQUIRED TO INSTALL SERVICES SHOWN ON THESE DRAWINGS
- DEBRIS WILL BE KEPT TO A MINIMUM. ON COMPLETION OF CONSTRUCTION AND PRIOR TO THE FINAL INSPECTION AND ACCEPTANCE BY THE OWNER, SITE SHALL BE CLEANED AND ALL SCRAP MATERIALS RESULTING FROM THE WORK SHALL BE REMOVED.
- PRIOR TO THE FINAL INSPECTION, ALL EQUIPMENT SHALL BE CLEANED.
   ALL CONSTRUCTION DUST AND DIRT SHALL BE REMOVED FROM INSTALLED EQUIPMENT AT THE END OF THE JOB.
- EXISTING INSTALLATIONS SHOWN FOR GENERAL REFERENCE ONLY.
   ATTEND SITE TO ASSESS WORK PRIOR TO BID SUBMISSION. INCLUDE ALL COSTS TO MODIFY AND / OR EXTEND NEW WORK AS REQUIRED TO MEET DESIGN INTENT. VERIFY ALL EXISTING DUCT / PIPE SIZES & CLEARANCES ON SITE.
- ALL EXISTING MECHANICAL EQUIPMENT TO REMAIN UNLESS NOTED OTHERWISE
- SCHEDULE AND PHASE WORK TO REDUCE INTERFERENCE AND DOWNTIME OF EXISTING SYSTEMS. NOTIFY OWNER'S REPRESENTATIVE OF ALL DOWNTIME PRIOR TO PROCEEDING WITH WORK.
- REMOVE EXISTING CEILING TILES AS REQUIRED TO PERFORM WORK.
   SAFELY STORE TILES FOR REINSTALLATION AFTER WORK & INSPECTIONS
   ARE COMPLETE. EXISTING DAMAGED TILES MUST BE IDENTIFIED &
   REPORTED TO OWNER'S REPRESENTATIVE BEFORE REMOVAL. REPLACE
   ANY DAMAGED TILES TO MATCH EXISTING.
- ALLOW FOR SCOPING OF EXISTING CONCEALED DRAINAGE PIPING TO VERIFY LOCATION & ROUTING.

# DRAWING NOTES (INDICATED WITH HEXAGONS):


- FACILITATE INSTALLATION OF LEAD REDUCTION SYSTEM ON DOMESTIC COLD WATER PIPING UPSTREAM OF EXISTING WATER HEATER AND NEW & EXISTING FIXTURES, AND DOWNSTREAM OF EXISTING IRRIGATION SYSTEM. REFER TO INSTALLATION DETAIL FOR CLARIFICATION.
- 2. ROUTE DOMESTIC HOT & COLD WATER AND SANITARY PIPING THROUGH MILLWORK TO/FROM KITCHEN SINK.
- 3. REVISE EXISTING SPRINKLER HEAD LOCATIONS TO SUIT REVISED USE OF SPACE AS NECESSARY FOR COMPLIANCE WITH NFPA 13. SUBMIT SPRINKLER DRAWINGS & HYDRAULIC CALCULATIONS FOR APPROVAL BY PROFESSIONAL ENGINEER PRIOR TO COMMENCING WORK.

PLUMBING F	PLUMBING FIXTURE SCHEDULE					
DWG REF	DESCRIPTION			COLD	DRAIN	
KS	SINK:  FAUCET:  DRAIN:	KRAUS MODEL KHT301-18 SINGLE BOWL STAINLESS STEEL KITCHEN SINK, OVERALL DIMENSIONS 18"x18"x10" (450x450x250mm), SINGLE REAR CENTER SET DRAIN AND 35mm (1-3/8") TOP SPUD INLET.  CHICAGO FAUCETS MODEL 434-ABCP SINGLE LEVER DECK MOUNTED SINK FAUCET WITH PULL DOWN SIDE SPRAY. CHROME PLATED. INTEGRAL TUBULAR BRASS SPOUT. DUAL PATTERN 1.5 USGPM OUTLET.  BENEKE SOLID WHITE PLASTIC, OPEN FRONT WITH REMOVABLE BUMPERS, CONCEALED CHECK HINGE AND COVER.	13mm 1/2"	13mm 1/2"	32mm 1-1/4"	
LR		PENTAIR LR-BB50 HEAVY DUTY POLYPROPYLENE WHOLE-HOME LEAD REDUCTION SYSTEM, 40,000 GALLON CAPACITY & IAXIMUM FLOW RATE, C/W MODEL 655210-43 REPLACEMENT CARTRIDGE		19mm 3/4"		

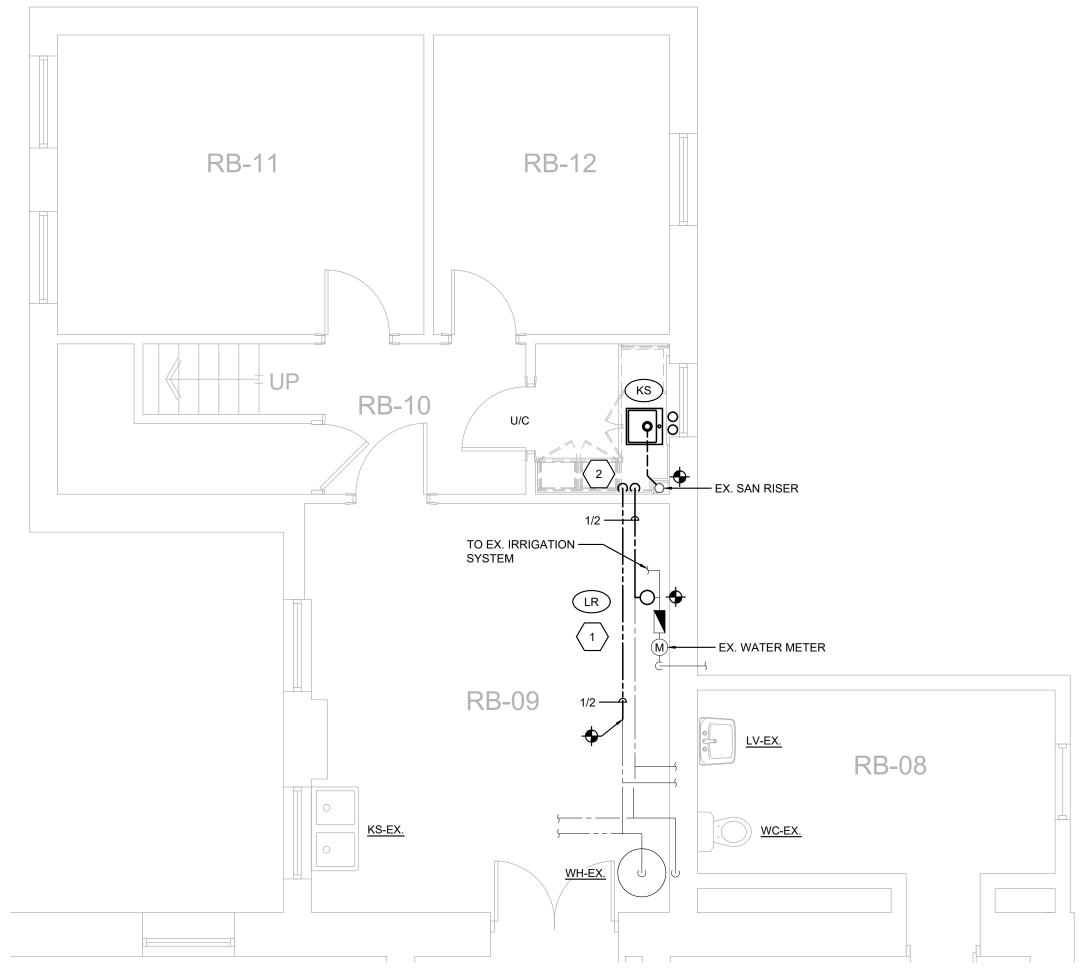

# PARTIAL GROUND FLOOR PLAN - PLUMBING

SCALE: 1/4" = 1'-0"

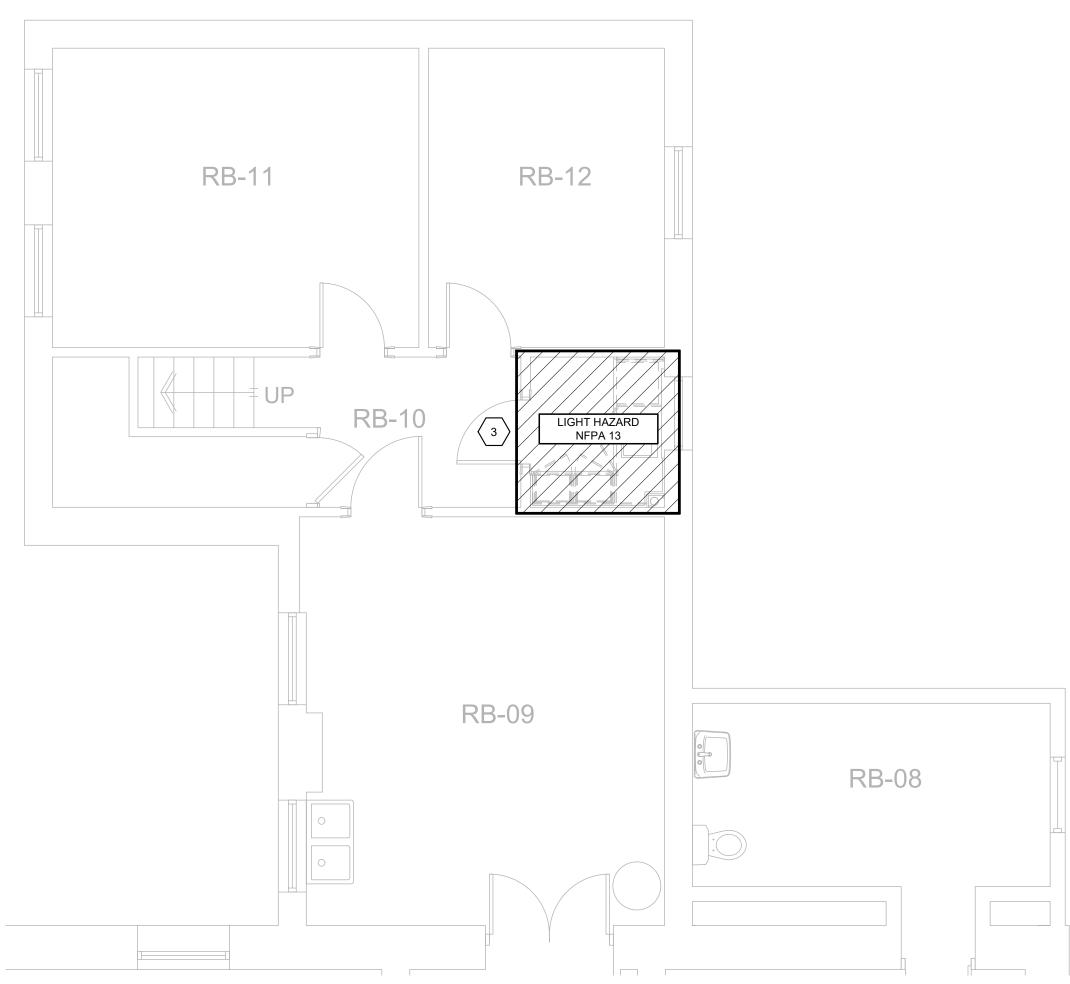

PARTIAL GROUND FLOOR PLAN - FIRE PROTECTION


SCALE: 1/4" = 1'-0"




LONDON: 1385 North Routledge Park, Unit 9
London, ON N6H 5N5 P 519.472.7640


KINGSTON: 1471 John Counter Blvd. Unit 301
Kingston, ON K7M 8S8 P 613.900.0845

KITCHENER: 210-137 Glasgow Street, Office #141
Kitchener, ON N2G 4X8 P 519.472.7640

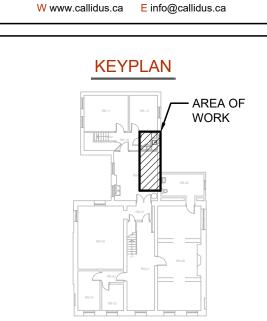

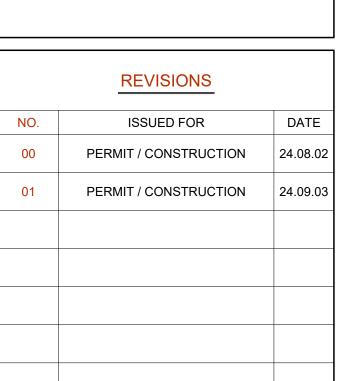



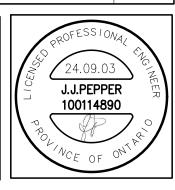



PROJECT
WHITEHERN HOUSE

KITCHENETTE DESIGN

**ADDRESS** 

41 JACKSON STREET, HAMILTON, ON

PROJECT NO.

CE-5977

DRAWING TITLE

MECHANICAL NOTES, SCHEDULES, DETAILS, PLUMBING & FIRE PROTECTION

DRAWING NUMBER

M1 OF 2

#### MECHANICAL GENERAL REQUIREMENTS:

- 1.1. <u>GENERAL:</u>
- 1.1.1. MAKE SITE VISIT(S) AS NECESSARY BEFORE BID CLOSING TO ESTABLISH AND VERIFY ALL EXISTING CONDITIONS. MAKE ALLOWANCE FOR ANY NEW OR EXISTING SERVICE AND EQUIPMENT RELOCATIONS NECESSARY TO COMPLETE THE WORK AND INCLUDE IN THE BID PRICE. EXTRAS WILL NOT BE ALLOWED FOR FAILURE TO PROPERLY EVALUATE
- 1.1.2. THE DRAWINGS SHOW THE GENERAL INTENT OF THE WORK, NOT THE DETAILS OF INSTALLATION. CO-ORDINATE THE ROUTING AND INSTALLATION OF ALL MECHANICAL SERVICES WITH ALL EXISTING CONDITIONS, STRUCTURE AND THE WORK OF ALL OTHER TRADES. PROVIDE INSTALLATION DRAWINGS AS REQUIRED.
- 1.1.3. DO NOT SCALE MECHANICAL DRAWINGS. TAKE FIELD DIMENSIONS PRIOR TO ANY
- DESCRIPTION: PROVIDE WORK IN ACCORDANCE WITH FULL INTENT AND MEANING OF DRAWINGS ND SPECIFICATIONS. THE WORD "PROVIDE" WHERE USED IN THE CONTRACT DOCUMENTS, IS TO BE INTERPRETED AS "SUPPLY AND INSTALL" ALONG WITH ALL ASSOCIATED HARDWARE AND
- 1.3. WORKMANSHIP: PROVIDE ALL NEW MATERIALS AND EQUIPMENT WITH THE APPROPRIATE LISTING (I.E. CSA, ULC, CETL, ETC.) ALL WORKMANSHIP BY THIS TRADE SHALL BE FIRST CLASS, CONFORMING TO INDUSTRY STANDARD PRACTICES FOR SAFETY, ACCESSIBILITY, DURABILITY AND NEATNESS FOR ACCEPTANCE BY THE OWNER'S REPRESENTATIVES.
- 1.4. <u>SLEEVES, HANGERS, INSERTS:</u> PROVIDE ALL SLEEVES, INSERTS AND HANGERS REQUIRED FOR THE MECHANICAL WORK/ TREAT ALL SLEEVES OR HOLES PIERCING ACOUSTICAL SEPARATIONS FOR INSTALLATIONS OF THE DIVISION TO MAINTAIN ACOUSTICAL RATING. ALL GAPS SHALL BE PACKED WITH ACOUSTICAL INSULATION AND SEALED AT BOTH ENDS WITH ACOUSTICAL CAULKING, PATCH ALL OPENINGS AROUND INSTALLATIONS OF THIS DIVISION PIERCING FIRE OR SMOKE SEPARATIONS WITH AN APPROVED WATERTIGHT SMOKE AND FIRE STOP SEALANT.
- 1.5. <u>INTERPRETATION:</u> DIVISION OF THE WORK AMONG SUPPLIERS OR VENDORS AND SUBCONTRACTORS IS SOLELY THE CONTRACTOR'S RESPONSIBILITY. NEITHER THE OWNER NOR CONSULTANT ASSUMES ANY RESPONSIBILITY TO ACT AS AN ARBITER TO ESTABLISH SUBCONTRACT TERMS BETWEEN SECTORS OR DISCIPLINES OF WORK.
- COORDINATION BETWEEN TRADES: CO-ORDINATE THE WORK OF THIS TRADE WITH ALL OTHER TRADES ON THE JOB SO THAT THE WORK MAY PROGRESS WITHOUT ANY DELAY. SCHEDULE AND PHASE DEMOLITION AND NEW WORK TO REDUCE INTERFERENCE AND DOWNTIME OF EXISTING SYSTEMS. NOTIFY OWNER'S REPRESENTATIVE OF ALL DOWNTIME PRIOR TO PROCEEDING WITH
- <u>DISCREPANCY:</u> IF A DISCREPANCY IS FOUND IN THE SPECIFICATION OR ON THE DRAWINGS, REQUEST CLARIFICATION PRIOR TO THE END OF THE QUESTION PERIOD SO THAT CLARIFICATION CAN BE PROVIDED IN WRITING.
- 1.8. REGULATORY REQUIREMENTS: CONFORM TO GOVERNING MUNICIPAL AND PROVINCIAL CODES, RULES AND REGULATIONS AND/OR AUTHORITIES HAVING JURISDICTION.

#### 1.9. CODES AND STANDARDS:

1.9.1. ALL WORK SHALL BE IN ACCORDANCE WITH THE LATEST EDITION OF THE ONTARIO BUILDING CODE, THE ONTARIO FIRE CODE AND ANY OTHER LOCAL REGULATIONS HAVING JURISDICTION OVER THE WORK OF THIS TRADE.

1.9.2. WHERE A CODE OR STANDARD IS REFERENCED, THE LATEST VERSION OF THE CODE OR

- STANDARD REFERENCED IN THE APPLICABLE BUILDING CODE IS TO BE APPLIED.
- 1.10. SAFETY: COMPLY WITH ALL PROVINCIAL/FEDERAL AND/OR LOCAL SAFETY REGULATIONS, NCLUDING THE OCCUPATIONAL HEALTH AND SAFETY ACT. IN ADDITION, COMPLY WITH ALL OF THE OWNER'S HEALTH AND SAFETY REQUIREMENTS.
- 1.11. PERMITS AND FEES: OBTAIN ALL PERMITS REQUIRED FOR INSTALLATION OF MECHANICAL TRADES WORK, ARRANGE FOR INSPECTIONS TESTS THEREWITH AND PAY ALL COSTS FOR PERMITS, INSPECTIONS, AND ASSOCIATED FEES. THIS INCLUDES ANY TSSA INSPECTION AND/OR CERTIFICATION. OBTAIN PERMITS IMMEDIATELY AFTER NOTIFICATION OF AWARD OF CONTRACT.
- 1.12. TAXES: ENSURE THAT PROVINCIAL AND/OR FEDERAL TAXES ARE INCLUDED WHERE REQUIRED.
- 1.13. WARRANTY: PROVIDE A WRITTEN WARRANTY FOR ALL MATERIALS, EQUIPMENT AND LABOUR FOR A ONE-YEAR PERIOD TO BEGIN AT THE TIME OF SUBSTANTIAL COMPLETION. COMPLETE ALL WARRANTY REGISTRATION DOCUMENTATION ON BEHALF OF THE BUILDING OWNER. INCLUDE COPIES OF COMPLETED DOCUMENTATION IN OPERATIONS AND MAINTENANCE MANUALS.
- 1.14. <u>CERTIFICATION:</u> PROVIDE MANUFACTURER'S WRITTEN CERTIFICATION OF THE INSTALLATION AND OPERATION OF ALL SYSTEMS AND MAJOR EQUIPMENT.

- 1.15.1. DO NOT SHUT DOWN OR MAKE CONNECTIONS TO ANY EXISTING SERVICE WITHOUT
- 1.15.2. BE RESPONSIBLE FOR DEMOLITION AND REMOVAL OF MECHANICAL EQUIPMENT AND SERVICES DESIGNATED FOR REMOVAL ON DRAWINGS.
- 1.16. <u>SITE PROTECTION AND CLEANLINESS:</u> PROTECT ALL WORK AND MATERIALS, BEFORE AND AFTER ERECTION, FROM WEATHER AND OTHER HAZARDS, AND KEEP IN A CLEAN AND ORDERLY MANNER. AVOID ACCUMULATION OF DEBRIS AS THE WORK PROGRESSES. ON COMPLETION OF THE CONSTRUCTION AND PRIOR TO THE FINAL INSPECTION AND ACCEPTANCE BY THE OWNER, CLEAN UP AND REMOVE FROM THE SITE ALL SCRAP MATERIALS RESULTING FROM THE WORK OF
- 1.17. ADJUSTMENT AND OPERATION OF SYSTEMS: WHEN WORK IS COMPLETE, ADJUST ALL EQUIPMENT ITEMS, OF VARIOUS SYSTEMS, FOR PROPER OPERATION WITHIN FRAMEWORK OF DESIGN INTENT, AND OPERATING CHARACTERISTICS AS PUBLISHED BY EQUIPMENT MANUFACTURER.
- 1.18. MISCELLANEOUS STEEL: SUPPLY AND INSTALL MISCELLANEOUS STRUCTURAL SUPPORTS, PLATFORMS, AND BRACES, AS REQUIRED TO HANG OR SUPPORT ALL EQUIPMENT, PIPING AND
- 1.19. EQUIPMENT INSTALLATION: INSTALL AND START UP ALL ITEMS OF EQUIPMENT, DEVICES AND SYSTEMS IN ACCORDANCE WITH MOST RECENT MANUFACTURER'S PUBLISHED GUIDELINES AND RECOMMENDATIONS. CONTRACTOR IS RESPONSIBLE FOR ASCERTAINING MANUFACTURERS INSTALLATION GUIDELINES AND RECOMMENDATIONS. TOUCH-UP ALL SHOP PAINTED EQUIPMENT DAMAGED IN TRANSIT OR DURING INSTALLATION TO MATCH ORIGINAL SHOP FINISH.
- 1.20. <u>CUTTING AND PATCHING:</u> PROVIDE ALL CUTTING AND PATCHING REQUIRED FOR THE WORK OF THIS TRADE. ALL CUTTING AND PATCHING SHALL BE PERFORMED BY TRADE SPECIALIZING IN THE MATERIAL TO BE PATCHED. INCLUDE ALL COSTS FOR CUTTING AND PATCHING RELATED TO THE WORK OF THIS TRADE IN THE BID PRICE. WHERE PIPES AND DUCTS ARE SHOWN PASSING THROUGH EXISTING WALLS, FLOORS, AND ROOF, CUT AND PATCH THE NECESSARY OPENINGS. SHOULD CUTTING. REPAIRING. AND PATCHING OF PREVIOUSLY FINISHED WORK. OF OTHER TRADES, BE REQUIRED TO ALLOW INSTALLATION OF MECHANICAL WORK, PAY ALL COSTS FOR TRADE SECTION CONCERNED TO PERFORM WORK.
- 1.21. SPARE PARTS / TOOLS TO BE FURNISHED:
- 1.21.1. ALL SPECIALITY TOOLS NECESSARY FOR EQUIPMENT INSTALLED IN THIS PROJECT.
- 1.22. CHANGES IN THE WORK: CHANGES TO THE CONTRACT REQUIRING ADDITIONS TO OR DELETIONS FROM THE WORK OF THIS DIVISION SHALL BE CARRIED OUT UPON WRITTEN REQUEST OF THE CONSULTANT. EXTRAS TO THE CONTRACT OR CREDITS SHALL BE SUBMITTED WITH A COMPLETE COST BREAKDOWN AS FOLLOWS:
- MATERIALS, QUANTITIES AND UNIT PRICES FOR ALL EQUIPMENT REQUIRED OR DELETED
- TOTAL MATERIAL COST
- TOTAL HOURS
- HOURLY RATE (REFER TO SUPPLEMENTARY CONDITIONS AND GENERAL CONTRACT)
- TOTAL OVERHEAD AND PROFIT (REFER TO SUPPLEMENTARY CONDITIONS AND GENERAL
- 1.23. COMPLETION: PRIOR TO THE FINAL INSPECTION, CLEAN ALL MECHANICAL EQUIPMENT. CLEAN ALL CONSTRUCTION DUST AND DIRT FROM INSTALLED EQUIPMENT AT THE END OF THE JOB. REPAIR ANY DAMAGE BY THE MECHANICAL TRADE TO EXISTING BUILDINGS OR EQUIPMENT, ETC TO THE CONSULTANTS SATISFACTION.

## 1.24. SUBMITTALS:

## 1.24.1. SHOP DRAWINGS:

- 1.24.1.1. SUBMIT SHOP DRAWINGS FOR ALL EQUIPMENT SUPPLIED BY MECHANICAL DIVISION. SUBMIT ELECTRONIC COPIES TO CONSULTANT FOR REVIEW.
- 1.24.1.2. SUBMIT UNITS OF MEASURE IN EITHER METRIC OR IMPERIAL THAT MATCH THOSE OF THE DRAWINGS.
- 1.24.1.3. PROVIDE TITLE SHEET INCLUDING PROJECT NAME. SHOP DRAWING NAME

(INCLUDING SPECIFICATION CLAUSE REFERENCE).

1.24.1.4. EACH SHOP DRAWING MUST BEAR STAMP AND SIGNATURE OF RESPONSIBLE OFFICIAL IN CONTRACTOR'S AND SUBCONTRACTOR'S ORGANIZATION. FOR EACH SUBMISSION, AS EVIDENCE THAT DRAWING HAS BEEN CHECKED AGAINST REQUIREMENTS AS CALLED FOR IN SPECIFICATIONS AND DRAWINGS.

## 1.24.2. OPERATION AND MAINTENANCE INSTRUCTION MANUALS:

1.24.2.1. PROVIDE PDF COPIES OF COMPLETE OPERATION AND MAINTENANCE INSTRUCTIONS FOR EQUIPMENT FURNISHED UNDER THIS CONTRACT. MANUAL SPECIFICATION SECTIONS. ONCE MANUAL IS REVIEWED AND ACCEPTED, PROVIDE PDF VERSION ON ELECTRONIC MEDIA.

1.24.2.2. MANUALS SHALL INCLUDE THE FOLLOWING INFORMATION:

CONTACT INFORMATION OF CONSULTANTS AND CONTRACTORS COMPLETE SET OF FINAL PROJECT SHOP DRAWINGS

TO BE ORGANIZED WITH BOOKMARKS IN A FORMAT TO MATCH THE

MAINTENANCE INSTRUCTIONS, INCLUDING PREVENTIVE MAINTENANCE INSTRUCTIONS FOR COMPONENTS OF EQUIPMENT

FINAL TESTING AND BALANCING REPORT MANUFACTURERS' WARRANTIES AND GUARANTEES

#### 1.24.3. AS-BUILT DRAWINGS

- 1.24.3.1. MAINTAIN AN ACCURATE RECORD OF DEVIATIONS AND CHANGES FROM CONTRACT DRAWINGS WITH RED LINE MARKINGS. TRANSFER AS-BUILT MARK-UPS TO DIGITAL DRAWING FORMAT. THIS PROCESS SHOULD BE COMPLETED BEFORE TESTING, BALANCING AND/OR COMMISSIONING. SUBMIT TO THE CONSULTANT WITH THE O&M MANUALS AT COMPLETION OF PROJECT.
- 1.24.3.2. FORMAT FILES TO MATCH EXACTLY THE LAYERING SYSTEM AND SYMBOLOGY OF THE CONSULTANT. BIND ALL EXTERNAL REFERENCES.
- 1.24.3.3. THE AS-BUILT DRAWINGS SHALL HAVE A VALUE OF \$5,000 UNLESS THE MECHANICAL CONTRACT VALUE IS LESS THAN \$100,000 WHICH SHALL HAVE A \$3,000 VALUE. ONCE AS-BUILT DRAWINGS HAVE BEEN COMPLETED, SUBMITTED AND REVIEWED, PAYMENT WILL BE RELEASED. THIS VALUE IS NOT INCLUDED IN THE AMOUNT REQUIRED BY THE CONSTRUCTION LIEN ACT.
- 1.24.3.4. THIS PROJECT UTILIZED THE FOLLOWING DIGITAL FORMAT(S): AUTOCAD
- 1.25. EQUIPMENT NAMEPLATES: PROVIDE LAMINATED WHITE PHENOLIC PLASTIC NAMEPLATES WITH 10 MM HIGH BLACK LETTERS FOR EQUIPMENT INSTALLED UNDER THIS DIVISION. INCLUDE EQUIPMENT NUMBER AND EQUIPMENT NAME GENERALLY AS LISTED ON DRAWING SCHEDULES. SUBMIT LIST OF NAMEPLATES TO CONSULTANT FOR REVIEW PRIOR TO FABRICATION. IF THE OWNER HAS SPECIFIC STANDARDS, FOLLOW THESE STANDARDS.

#### 1.26. FIRESTOPPING AND SMOKE SEAL:

- 1.26.1. PROVIDE ULC LISTED FIRESTOP SYSTEM TO SEAL AROUND ALL MECHANICAL SERVICES WHICH PENETRATE PART OF A BUILDING ASSEMBLY REQUIRED TO HAVE A FIRE
- 1.26.2. SUBMIT DETAILED SHOP DRAWINGS TO THE CONSULTANT FOR REVIEW. INCLUDING:
  - MANUFACTURER'S TECHNICAL PRODUCT DATA AND INSTALLATION INSTRUCTIONS FOR EACH SPECIFIC TYPE AND LOCATION OF PENETRATION -CERTIFICATION THAT PROPOSED FIRESTOPPING MATERIALS AND ASSEMBLIES
  - -ULC LISTINGS WITH COPIES OF ULC DATA SHEETS FOR EACH SPECIFIC TYPE AND LOCATION OF PENETRATION

#### 1.27. MECHANICAL PROJECT COMPLIANCE:

- 1.27.1. THE FOLLOWING DOCUMENTS AND/OR CONFIRMATION IS REQUIRED TO ALLOW THE CONSULTANT TO ISSUE OUR LETTER OF GENERAL REVIEWS:
- CONFIRMATION THAT FIRESTOPPING IS COMPLETE

COMPLY WITH CAN4-S115-M

# 2. TESTING AND BALANCING:

- 2.1.1. PROVIDE PRESSURE TESTS ON ALL PIPING INCLUDED IN THIS CONTRACT. FURNISH ALL PUMPS, COMPRESSORS, GAUGES AND CONNECTORS NECESSARY FOR TESTS.
- 2.1.2. CONDUCT HYDROSTATIC TESTS FOR A MINIMUM PERIOD OF 2 HOURS. DURING THIS TIME THE PRESSURE SHALL REMAIN CONSTANT.
- 2.1.3. FOR PNEUMATIC TESTS, FIRST PRESSURIZE SYSTEM WITH AIR TO APPROXIMATELY ONE-HALF SPECIFIED PRESSURE, BUT NOT TO EXCEED 345 KPA (50 PSIG), AND EXAMINE ALL JOINTS FOR LEAKS WITH A SOAPSUDS SOLUTION. REPAIR ANY LEAKS.
- 2.1.4. FORWARD COPIES OF ALL FINAL TESTS ON ALL PRESSURE AND DRAINAGE PIPING TO

#### MECHANICAL INSULATION:

- 3.1. WHERE INSULATION THICKNESS IS NOT IDENTIFIED, COMPLY WITH ASHRAE 90.1 REQUIREMENTS.
- 3.2. ALL PRODUCTS TO HAVE FLAME SPREAD RATING LESS THAN 25 AND SMOKE DEVELOPED CLASSIFICATION LESS THAN 50 IN COMPLIANCE WITH CAN/ULC-S102.
- 3.3. PROVIDE A CONTINUOUS VAPOUR BARRIER ON ALL COLD SYSTEMS.

## 3.4. <u>DEFINITIONS:</u>

CONCEALED: INSULATED MECHANICAL SERVICES AND EQUIPMENT IN SUSPENDED CEILINGS AND NON ACCESSIBLE CHASES AND FURRED IN SPACES.

## EXPOSED: NOT CONCEALED

## 3.5. <u>INSULATION TYPES:</u>

- 3.5.1. PGF PREFORMED GLASS FIBRE: FIBROUS GLASS SPLIT SECTIONAL PIPE INSULATION CONFORMING TO CAN/ULC C-S702, WITH FACTORY APPLIED VAPOUR BARRIER JACKET TO ASTM C921 AND SELF-SEAL LAP JOINT.
- 3.5.2. FGF FLEXIBLE GLASS FIBRE: ASTM C553 FLEXIBLE NON-COMBUSTIBLE BLANKET, WITH FACTORY APPLIED VAPOUR BARRIER JACKET TO ASTM E96/E96M. THERMAL CONDUCTIVITY TO ASTM C518.
- RGF RIGID GLASS FIBRE: ASTM C612 RIGID NON-COMBUSTIBLE BLANKET, WITH FACTORY APPLIED VAPOUR BARRIER JACKET TO ASTM E96/E96M. THERMAL CONDUCTIVITY TO ASTM C518.
- CELLULAR FOAM: ASTM C534/C534M, FLEXIBLE, CELLULAR ELASTOMERIC, MOULDED OR SHEET WITH ANTIMICROBIAL COATING. USE WATERPROOF VAPOUR BARRIER ADHESIVE. EXPOSED INSULATION TO HAVE WHITE FINISH.

- 3.6.1. DO NOT INSULATE FLANGES OR UNIONS AT CONNECTION TO EQUIPMENT.
- 3.6.2. VALVE OPERATORS AND BALANCING VALVE TEST PORTS TO BE ACCESSIBLE WITHOUT REMOVAL OF INSULATION.
- 3.6.3. <u>PIPE INSULATION INSERTS AND SHIELDS:</u> PROVIDE RIGID INSERTS AND SHIELDS AT ALL HANGER SUPPORTS WHERE PIPING IS INSULATED. INSERT THICKNESS TO MATCH INSULATION THICKNESS. INSERT TO BE HYDROUS CALCIUM SILICATE RIGID PIPE INSULATION. INSERT AND SHIELD TO PROTECT BOTTOM HALF OF PIPE. SHIELD TO BE FABRICATED FROM GALVANIZED STEEL. SHIELD COLOUR TO MATCH COLOUR OF INSULATION FINISH. SHIELD AND INSERT LENGTH TO BE AS FOLLOWS:

#### NOMINAL PIPE SIZE INSERT LENGTH MM (IN) MM (IN) 40-65 (1-1/2 - 2-1/2) 250 (10)

- 3.6.4. PIPE INSULATION TYPE AND THICKNESS:
- 3.6.4.1. <u>PLUMBING:</u>
  - 3.6.4.1.1. POTABLE (DOMESTIC) COLD WATER AND CITY WATER (PGF): 25 MM

- 3.6.4.1.2. POTABLE (DOMESTIC) HOT WATER (PGF): <=32 MM (1-1/4") - 25 MM (1")

## >=40 MM (1-1/2") - 40 MM (1-1/2")

3.6.4.1.3. <u>SANITARY DRAIN (PGF):</u> 25 MM (1")

# 3.6.5. APPLICATION:

3.6.5.1. COMPLETELY INSULATE THE FOLLOWING SYSTEMS:

## -POTABLE (DOMESTIC) COLD WATER

-POTABLE (DOMESTIC) HOT WATER

3.6.5.2. SANITARY DRAIN:

#### 3.6.5.2.1. INSULATE HORIZONTAL ABOVE FLOOR STORM AND SANITARY DRAIN PIPING WITHIN BUILDING.

3.6.5.2.2. INSULATE VERTICAL SECTIONS OF RAINWATER CONDUCTORS BETWEEN BODY OF ROOF DRAIN AND HORIZONTAL SECTION OF PIPE, ALSO ANY EXPOSED VERTICAL PIPING IN HIGH HUMIDITY AREAS SUCH AS LOCKER AND SHOWER ROOMS.

#### 3.7. SURFACE FINISHES:

## 3.7.1. <u>PIPING:</u>

- EXPOSED INTERIOR PIPING; FINISH EXPOSED INSULATED PIPING, VALVES AND FITTINGS WITH PVC JACKETING. PVC MUST HAVE ATTAINED 25/50 FIRE RATING, BASED ON CAN/ULC-S102-M88 TESTING.
- SANITARY PIPING: FINISH INSULATED SANITARY PIPING BELOW BARRIER FREE LAVATORY TRAPS WITH PVC JACKETING. PVC MUST HAVE ATTAINED 25/50 FIRE RATING, BASED ON CAN/ULC-S102-M88 TESTING.

#### 4. PIPING SYSTEMS:

#### 4.1. GENERAL:

4.1.1. EXPANSION AND CONTRACTION: INSTALL ALL PIPING SO AS TO BE FREE FROM STRAIN AND DISTORTION DUE TO EXPANSION AND CONTRACTION AS GOVERNED BY REQUIREMENTS OF ANSI B31.1, EXCEPT AS HEREINAFTER MODIFIED. ALLOW FOR EXPANSION AND CONTRACTION BY OFFSETS, EXPANSION U-BENDS OR LOOPS. DO NOT USE EXPANSION JOINTS OF ANY TYPE UNLESS SPECIFICALLY INDICATED ON DRAWINGS.

#### 4.1.2. LINES, GRADES AND SLOPES:

- 4.1.2.1. INSTALL LIQUID AND AIR PIPING FREE OF POCKETS AND PITCH TO DRAIN, AT LOW POINTS IN PIPING, WITH VALVES OR TRAPS INSTALLED AS REQUIRED FOR DRAINAGE OF THE PIPING.
- 4.1.2.2. INSTALL PIPING TO FOLLOWING SLOPES:
  - DRAINAGE PIPING: 1:50 ON DRAINS OF NPS 3 SIZE AND LESS AND 1:100 ON DRAINS OF NPS 4 AND LARGER.
- POTABLE (DOMESTIC) WATER PIPING: PITCH TO LOW POINTS SO THAT ALL PIPING MAY BE COMPLETELY DRAINED.
- 4.1.3. <u>UNIONS OR FLANGES PROVIDE IN THE FOLLOWING LOCATIONS:</u>
  - SYSTEMS, AND ELSEWHERE INDICATED ON DRAWINGS. 4.1.3.2. AT CONNECTIONS TO EQUIPMENT (LOCATE BETWEEN SHUT-OFF VALVE AND

4.1.3.1. FOR BY-PASSES AROUND EQUIPMENT, CONTROL VALVES, DEVICES IN PIPING

- 4.1.3.3. PROVIDE DIELECTRIC UNIONS, OR ISOLATING TYPE COMPANION FLANGES, AT ALL CONNECTIONS BETWEEN COPPER TUBING AND FERROUS PIPING.
- 4.1.4. PIPING CONNECTIONS TO MAINS:
- 4.1.4.1. MAKE BRANCH CONNECTIONS OF STEAM, GAS, AND COMPRESSED AIR PIPING, TO RESPECTIVE HORIZONTAL PIPING OF LARGER DIAMETER, TO UPPER QUADRANT OF LARGER PIPE
- 4.1.4.2. MAKE DOWN FEED PIPING CONNECTIONS, TO HORIZONTAL SUPPLY AND RETURN WATER MAINS, ON BOTTOM QUADRANT OF MAINS.
- 4.1.5.1. INSTALL SLEEVES WHERE PIPING PASSES THROUGH FOUNDATIONS, ABOVE GRADE FLOORS, AND WALLS. FABRICATE SLEEVES OF SCHEDULE 40 BLACK STEEL PIPE OR TYPE "K" COPPER TUBING.
- 4.1.5.2. SLEEVES FOR PIPING PASSING THROUGH ROOFS WILL BE SUPPLIED AND
- 4.1.5.3. MAKE SLEEVES LARGE ENOUGH TO PASS FULL THICKNESS OF PIPE COVERING WHERE SAME IS USED, AND WITH SUFFICIENT CLEARANCE BETWEEN PIPE AND SLEEVE TO ALLOW FOR ANY LATERAL MOVEMENT OF PIPING DUE TO
- EXPANSION AND CONTRACTION.

INSTALLED UNDER THIS DIVISION

4.1.5.4. FILL SLEEVES FOR FUTURE USE WITH LIME MORTAR. 4.1.6. <u>ESCUTCHEON PLATES:</u> PROVIDE ESCUTCHEON PLATES ON BARE PIPING PASSING HROUGH FINISHED WALLS OR FLOORS.

#### 4.1.7. PIPE IDENTIFICATION:

- 4.1.7.1. LABEL PIPING INSTALLED UNDER THIS DIVISION TO INDICATE CONTENT AND DIRECTION OF FLOW. INCLUDE OPERATING PRESSURE OR VACUUM, AS
- 4.1.7.2. ALL LABELS SHALL BE OF SUFFICIENT WIDTH TO OVERLAP ITSELF
- 4.1.7.3. PROVIDE LABELS OF PLASTIC COATED TAPE, WITH SELF-ADHESIVE BACKING SURFACE FOR INSTALLATION ON INSULATED PIPE PROVIDE ADHESIVE SUITABLE FOR THIS APPLICATION. CONFORM WITH CAN/CGSB-24.3 AND/OR OWNER STANDARDS FOR PRIMARY LABEL COLOUR, AND WITH LEGEND AND OR A RECOGNIZED ABBREVIATION OF SERVICE INVOLVED.
- 4.1.7.4. LOCATE LABELS AS FOLLOWS: AT EVERY END OF EVERY PIPE RUN, ADJACENT TO VALVE OR ITEM OF EQUIPMENT SERVICES. ON EACH EXPOSED PIPE PASSING THROUGH WALL, PARTITION OR FLOOR AT INTERVALS OF 15 M (50'-0") ALONG EVERY EXPOSED PIPE RUN EXCEEDING 15 M (50'-0") IN LENGTH. AT EVERY ACCESS POINT ON CONCEALED PIPING.

# 4.2. HANGERS AND SUPPORTS:

## 4.2.1. <u>GENERAL:</u>

- 4.2.1.1. PIPE HANGERS & SUPPORTS TO CSA B214 & MSS SP-58.
- 4.2.1.2. SUPPORT OR SUSPEND ALL PIPING WITH NECESSARY HANGERS, STRUCTURAL SUPPORTS AND/OR BRACKETS AS REQUIRED. TO PREVENT SAGGING, WARPING
- 4.2.1.3. DO NOT ALLOW LOADS, OF ANY NATURE, TO BE TRANSMITTED THROUGH PIPING CONNECTIONS TO EQUIPMENT.
- 4.2.1.4. PROVIDE SUITABLY DAMPENED SPRING HANGERS FOR FIRST THREE SUPPORTS FROM EQUIPMENT CONNECTION ON PIPING SUBJECT TO EXCESSIVE
- 4.2.1.5. DO NOT HANG ANY PIPE, FROM ANOTHER PIPE OR FROM ROOF DECK, UNLESS
- SPECIFICALLY INDICATED ON DRAWINGS.

# 4.2.1.6. PROVIDE DIELECTRIC SEPARATION AS REQUIRED.

- 4.2.2. <u>HANGERS:</u> 4.2.2.1. FOR ALL INSULATED PIPING UP TO NPS 4, CARRYING LIQUIDS AT TEMPERATURES 10.5°C (51°F) AND HIGHER, USE STANDARD WEIGHT CLEVIS
  - 4.2.2.2. FOR INSULATED PIPING CARRYING LIQUIDS AT A TEMPERATURE OF 10°C (50°F)
  - OR LESS, USE ELONGATED CLEVIS TYPE HANGERS 4.2.2.3. PROVIDE INSULATION PROTECTION BEARING PLATES AT ALL HANGERS AND
  - SUPPORTS FOR ALL INSULATED PIPING. 4.2.2.4. FOR NON-INSULATED PIPING USE CLEVIS TYPE OF WROUGHT STEEL
  - CONSTRUCTION. 4.2.2.5. FOR COPPER TUBING PROVIDE COPPER COATED HANGERS.

#### 4.2.2.6. ATTACH HANGER RODS, TO BUILDING STRUCTURE, BY MEANS OF MALLEABLE IRON BEAM CLAMPS OR CONCRETE INSERTS

- 4.2.3. HANGER SPACING: 4.2.3.1. FOR HORIZONTAL RUNS OF PLUMBING AND DRAINAGE PIPING COMPLY WITH
  - HANGER SPACING REQUIREMENTS OF BUILDING CODE. 4.2.3.2. IN A HORIZONTAL RUN, PEX TUBING SHALL BE SUPPORTED AT INTERVALS NOT EXCEEDING 800 MM (32"), UNLESS OTHERWISE SPECIFIED BY THE

# 4.2.4. VERTICAL PIPING SUPPORTS:

MANUFACTURER.

- 4.2.4.1. SUPPORT VERTICAL PLUMBING AND DRAINAGE PIPING AS REQUIRED BY THE BUILDING CODE, UNLESS MORE STRINGENT REQUIREMENTS ARE SPECIFIED
- 4.2.4.2. PROVIDE LATERAL STABILITY, OF VERTICAL PIPING, BY FABRICATED BRACKETS OR MALLEABLE IRON EXTENSION TYPE SPLIT HANGERS. RUN VERTICAL PIPING AT COLUMNS IN THE COLUMN WEBS. ON EITHER OR BOTH SIDES OF THE COLUMN, UNLESS OTHERWISE DIRECTED BY THE CONSULTANT.

## 4.3. MATERIALS OF CONSTRUCTION:

# 4.3.1. SANITARY AND INDIRECT DRAIN (INCLUDING VENTING)

## 4.3.1.1. REFERENCE STANDARDS:

- 4.3.1.1.1. CAST IRON: TO CSA B70. MECHANICAL FITTINGS TO CSA B602.
- 4.3.1.1.2. COPPER, DWV: HARD DRAWN COPPER DRAINAGE TUBE ONFORMING TO ASTM B 306 WITH WROUGHT COPPER OR CAST

BRASS SOLDER JOINT DRAINAGE FITTINGS TO ASME B16.29 OR ASME

- 4.3.1.1.3. PVC, DWV: TO CAN/CSA-B182.1 OR B182.2. RUBBER RING GASKETS INTEGRAL WITH BELL OR SOLVENT WELD TO ASTM D2564.
- 4.3.1.1.4. PVC, SYSTEM 15: TO CSA B182.2. FLAME SPREAD RATING NOT

4.3.1.2.1.1. PIPING 75 MM (3") AND SMALLER: DWV COPPER

4.3.1.2.1.2. <u>PIPING 150 MM (6") AND SMALLER:</u> PVC DWV

4.3.2.1.2.1. PIPING: SEAMLESS WATER TUBE TO ASTM B88

B16.22 (WROUGHT) OR

4.3.2.1.3.1. CROSSLINKED POLYETHYLENE PIPING TO

WITH NO LIMITATIONS ON SPACING.

4.3.2.1.3.2. SEAL PENETRATIONS AT FIRE SEPARATIONS PER

4.3.2.1.3.4. ALL FITTINGS BY TUBING MANUFACTURER.

4.3.2.1.4. PVC: TO CSA B137.3 OR CSA B137.2. MINIMUM PRESSURE RATING

VALVES OR EQUIPMENT.

4.3.2.2.1.2. PEX-A FOR 38 MM (1-1/2") AND SMALLER (ON

4.3.2.1.3.5. 25 YEAR CSA SYSTEM WARRANTY (INCLUDING

4.3.2.2.1.1. TYPE "L" HARD DRAWN COPPER TUBING. PROVIDE

SOLDER TO THREADED ADAPTERS AT SCREWED

COMPLETION OF INSTALLATION THE SYSTEM SHALL BE

WHICH MEETS LOCAL PLUMBING CODES. THE SYSTEM

SHALL REMAIN AT THIS PRESSURE FOR A MINIMUM OF

24 HOURS TO ENSURE SYSTEM INTEGRITY). PROVIDE

CONNECTION, STUB-OUT TO BE MANUFACTURED FROM SEAMLESS COPPER TUBING WITH A MACHINED ASTM

OUTLET. FOLLOW MANUFACTURERS INSTRUCTIONS FOR

CONSTRUCTION, HIGH-RISE BUILDINGS AND IN RETURN

AIR PLENUMS. FIRESTOPPING SYSTEMS SHALL BE

LISTED UNDER CAN/ULC S115 AND TESTED WITH A

COPPER STUB-OUT ELBOWS AT EACH FIXTURE

F-1807 PEX BARB CONNECTION AND SPIN SEALED

CHARGED WITH POTABLE WATER TO A PRESSURE

4.3.2.1.3.3. PIPING WITHIN A FIRE SEPARATION PER CAN/ULC-S101.

CONSEQUENTIAL) FROM INSTALLATION DATE.

AT 100 PSI (689 KPA).

CAN/ULC-S115.

4.3.2.2.1. ABOVE GROUND PIPING 75 MM (3") AND SMALLER:

INSTALLATION.

4.3.3.1. STANDARD BLACK STEEL PIPE WITH SCREWED OR FLANGED CAST IRON

4.3.2.2.1.3. CPVC: BUILDINGS OF NON-COMBUSTIBLE

SPRINKLER FITTINGS SUITABLE FOR 1,200 KPA (175 PSIG) PRESSURE, COLD

MECHANICAL TYPE COUPLINGS. CANADIAN UNDERWRITER'S LISTED AND IAO

ACCORDANCE WITH NFPA 13 AND 14 FOR THE TYPE OF CONNECTIONS USED

ANSI/ASTM A53 FOR DRY PIPE SYSTEMS OR WHERE OTHERWISE INDICATED.

USE HOT-DIPPED ZINC COATED (GALVANIZED) WELDED AND SEAMLESS PIPE TO

TO BLAZEMASTER CPVC SDR 13.5 HAVING A RATED WORKING PRESSURE OF 175

PSI AT 150°F OR 315 PSI AT 73°F. USE THREADED, FLANGED OR SOLVENT WELD

INSTALLATION INSTRUCTIONS. USE CPVC PIPING FOR LIGHT HAZARD AREAS

AND FITTINGS OR VALVES. FOR PIPE SIZES 32 MM (1-1/4") AND LARGER,

APPROVED, MAY BE USED, ENSURE WALL THICKNESS OF PIPE IS IN

4.3.3.2. CPVC PIPE AND FITTINGS ULC LISTED FOR USE IN SPRINKLER SYSTEMS EQUAL

JOINTS FOR PIPE, FITTINGS AND VALVES, FOLLOW MANUFACTURER'S

ONLY, OR AS PERMITTED FOR ORDINARY HAZARD.

ETECT EXCESSIVE WATER LOSSES.

AS INDICATED ON DRAWINGS.

5.1.3. TESTING AND INSPECTION:

25 AND NFPA 13A.

INSPECTION AUTHORITY

4.4.1. WATER: HYDROSTATICALLY TEST WATER PIPING AT 862 KPA (125 PSIG) PRESSURE TO

5.1.1.1. PROVIDE A SPRINKLER SYSTEM TO PROTECT THE COMPLETE BUILDING,

EXISTING AND NEW. DESIGN FOR HAZARD OCCUPANCY IN ACCORDANCE WITH

TO NFPA 13, MANUFACTURERS INSTALLATION INSTRUCTIONS AND CONDITIONS

CONFORM TO NFPA 13. REFER TO ARCHITECTURAL, STRUCTURAL, MECHANICAL

AND ELECTRICAL DRAWINGS AS WELL AS SITE CONDITIONS FOR BUILDING

QUARTER POINTS WITH SPRINKLERS LOCATED SYMMETRICALLY WITH EACH

OTHER IN THE AREA OR ROOM. SECTION OF SPRINKLER HEAD TYPES SHALL BE

ELEMENTS, EQUIPMENT, AND SERVICES WHICH MAY AFFECT THIS WORK.

5.1.1.4. LOCATE SPRINKLER HEADS IN POSITIONS ACCEPTABLE TO THE ARCHITECT AND

NFPA 13. IN 'T' BAR CEILING THIS IS GENERALLY CENTER OF TILE OR AT

5.1.2. <u>SUBMITTAL:</u> PREPARE AND SUBMIT COMPLETE PLANS, INSTALLATION AND HYDRAULIC

PROVINCIAL AND LOCAL FIRE INSPECTION AUTHORITIES AND TO THE OWNER'S

ENGINEER TO COMPLETE THE COMMITMENT TO GENERAL REVIEW FOR THE FIRE

CALCULATION SHOP DRAWINGS FOR FIRE PROTECTION WORK TO CONSULTALNT,

INSURANCE UNDERWRITER. DESIGN TO BE COMPLETED BY FIRE PROTECTION ENGINEER

ARE TO BE SEALED AND SIGNED BY THE FIRE PROTECTION ENGINEER. FIRE PROTECTION

5.1.3.1. TEST AUTOMATIC SPRINKLER IN ACCORDANCE WITH REQUIREMENTS OF NFPA

5.1.3.2. ARRANGE AND PAY FOR ALL REVIEWS AND INSPECTIONS REQUIRED BY LOCAL

5.1.3.3. COORDINATE TESTING OF AUTOMATIC SPRINKLER SYSTEMS WITH FIRE ALARM

SYSTEM VERIFICATION TO ENSURE THAT ALL DEVICES ARE FULLY TESTED.

THAT IS QUALIFIED AND INSURED AS REQUIRED BY BUILDING CODE. SHOP DRAWINGS

THE REQUIREMENTS OF NFPA NO. 13 AND THE ONTARIO BUILDING CODE.

5.1.1.2. INSTALLATION OF PIPE, FITTINGS, VALVES, AND ACCESSORIES SHALL CONFORM

5.1.1.3. LOCATION, SPACING, AND POSITION OF SPRINKLER HEADS AND DRAINS SHALL

WATER, NON-SHOCK. USE SCREWED OR FLANGED TYPE JOINTS BETWEEN PIPE

PRESSURE DIFFERENTIAL OF 50 PA.

1.100 KPA (160 PSI)

4.3.3. FIRE PROTECTION:

4.4. <u>TESTING:</u>

FIRE PROTECTION SYSTEM

5.1. SPRINKLER SYSTEM:

5.1.1. <u>GENERAL:</u>

SOLDER JOINT FITTINGS TO ASME B16.18 (CAST) OR

COLD PRESS FITTINGS WITH EPDM SEALING ELEMENT

INSTRUCTED BY THE PRESS FITTING MANUFACTURER.

RATINGS: 93°C (200°F) AT 80 PSI (551 KPA), 82°C (180°F)

 $\underline{50~\rm MM}$  (2") AND SMALLER: CAN/ULC-S102.2 LISTED TO A MAXIMUM OF 25 FLAME SPREAD / 50 SMOKE DEVELOPED

65 MM (2-1/2") AND LARGER: CAN/ULC-S102.2 LISTED TO

DEVELOPED WITH RATED FIBERGLASS INSULATION.

A MAXIMUM OF 25 FLAME SPREAD / 50 SMOKE

TO ASME B16.18 OR ASME B16.22, INSTALLED USING

PROPER TOOL, ACTUATOR, JAWS, AND RINGS AS

CAN/CSA-B137.5. PRESSURE AND TEMPERATURE

4.3.2.1.1. ALL MATERIALS TO BE NSF/ANSI 61 & 372 CERTIFIED.

4.3.1.1.7. GALVANIZED STEEL: TO ASTM A52/A52M.

4.3.1.2. <u>APPLICATION:</u>

4.3.1.2.1. <u>ABOVE GRADE:</u>

4.3.2. POTABLE (DOMESTIC) HOT AND COLD WATER:

4.3.2.1. REFERENCE STANDARDS:

- GREATER THAN 25 PER CAN/ULC 102.2 WITH CERTIFICATION LABEL.
- 4.3.1.1.5. PVC, XFR: TO CSA B182.2. FLAME SPREAD RATING NOT GREATER HAN 25 & SMOKE DEVELOPED CLASSIFICATION NOT GREATER THAN 5.1.4.2. <u>UPRIGHT:</u> ULC LISTED, PLAIN BRONZE, STANDARD PATTERN, ORDINARY RATING, PRIGHT TYPE SPRINKLER HEADS CONFORMING TO NFPA 13. USE UPRIGHT 50 PER CAN/ULC 102.2 WITH CERTIFICATION LABEL.
- SPRINKLER HEADS IN EXPOSED LOCATIONS. 4.3.1.1.6. POLYETHELYNE: TO CSA B137.1. BUTT FUSION FITTINGS TO ASTM

5.1.4. SPRINKLER HEADS:

5.1.4.3. SPRINKLER HEADS SHALL COME COMPLETE WITH WIRE GUARD WHERE APPROPRIATE.

#### PLUMBING SYSTEM:

- 6.1. <u>REFERENCES STANDARDS:</u>
  - 6.1.1. CONFORM TO ALL APPLICABLE CODES INCLUDING, BUT NOT LIMITED TO, THE
  - 6.1.1.1. <u>CSA-B64.10:</u> SELECTION AND INSTALLATION OF BACKFLOW PREVENTERS

5.1.4.1. CONCEALED: ULC LISTED, ORDINARY RATING CHROME PLATED SPRINKLER

HEAD WITH COVER PLATE, CONFORMING TO NFPA 13, COMPLETE WITH WHITE

COATED TWO-PIECE STYLE ESCUTCHEON TO PERMIT REMOVING CEILING TILES

WITHOUT REMOVING SPRINKLERS, ESCUTCHEON PLATES TO BE ADJUSTABLE

UP TO 1/2". USE CONCEALED SPRINKLER HEADS IN AREAS WITH FINISHED

- 6.1.1.2. <u>CSA-B149.1:</u> NATURAL GAS AND PROPANE INSTALLATION CODE
- 6.2. <u>VENTING:</u> PLUMBING VENTING MAY NOT BE SHOWN ON DRAWINGS. PROVIDE A COMPLETE LUMBING VENTING SYSTEM FOR ALL PLUMBING FIXTURES SHOWN, IN ACCORDANCE WITH OBC

# 6.3. <u>STERILIZATION OF POTABLE (DOMESTIC) WATER SYSTEMS:</u>

- 6.3.1. FLUSH EACH SYSTEM, AFTER COMPLETION, BY ALLOWING FULL FLOW OF WATER THROUGH SYSTEM FOR A PERIOD OF FIFTEEN MINUTES, OR LONGER WHEN DIRECTED
- 6.3.2. AFTER FLUSHING OF THE SYSTEM IS COMPLETED, PROVIDE A 24 HOUR CONTACT STERILIZATION TREATMENT BY TREATING THE WATER WITH 50 PPM OF CHLORINE AS RECOMMENDED IN AWWA SPECIFICATION C-651. AFTER STERILIZATION PERIOD HAS ELAPSED, FLUSH SYSTEM TO REDUCE CHLORINE CONTENT TO AN ACCEPTABLE LEVEL.

#### 6.4. PLUMBING FIXTURES:

- 6.4.1. PROVIDE CSA COMPLIANT PLUMBING FIXTURES.
- 6.4.2. PROVIDE PLUMBING FIXTURES AS INDICATED IN SCHEDULE ON DRAWINGS
- 6.4.3. CAULK ALL AROUND BASES OF MOP SERVICE SINKS, BUILT-IN BATHTUBS, AND OTHER BUILT-IN FIXTURES.

- 6.5. <u>VALVES:</u> 6.5.1. SUBMIT SHOP DRAWINGS FOR ALL VALVES
- 6.5.2. POTABLE (DOMESTIC) WATER:
- 6.5.2.1. <u>REFERENCE STANDARDS:</u>

BAR (150 PSI) WORKING PRESSURE.

- 6.5.2.1.2. BRONZE TO ASTM C89530
- 6.5.2.1.3. BRASS TO ASTM C46750 6.5.2.1.4. CAST IRON TO ASTM A126
- 6.5.2.1.5. STAINLESS STEEL TO ASTM A351

6.5.2.1.6. CPVC RATED TO 1,600 KPA (232 PSI) AT 23°C (73°F)

WITH INSULATION STEM EXTENSION. SOLDERED, THREADED OR PEX

6.5.2.1.1. LEAD FREE, 0.25% CONTENT PER NSF-61/372

6.5.2.1.7. ALL PRESSURE RATINGS, SIZES TO MSS SP-25 ISOLATION / SHUT-OFF: 2 PIECE BRASS OR BRONZE BODY, 1,034 KPA (150 PSI) 60 WOG RATING, FULL PORT, STAINLESS STEEL BALL, LOCKING LEVER HANDLE


#### CONNECTIONS. MANUFACTURED TO MSS SP-110.

WATER HAMMER ARRESTORS: PROVIDE IN ACCORDANCE WITH THE PLUMBING AND DRAINAGE INSTITUTE STANDARD PDI-WH-201. ARRESTORS SHALL BE COPPER CONSTRUCTION WITH BELLOWS SIZED TO PDI WH-201 AND PRE-CHARGED FOR OPERATION IN TEMPERATURE RANGE -0.5C TO 82C (33F TO 180F) AND A MAXIMUM 10.6


LONDON: 1385 North Routledge Park, Unit 9 London, ON N6H 5N5 P 519.472.7640

KINGSTON: 1471 John Counter Blvd. Unit 301 Kingston, ON K7M 8S8 P 613.900.0845 KITCHENER: 210-137 Glasgow Street, Office #141 Kitchener, ON N2G 4X8 P 519.472.7640 W www.callidus.ca E info@callidus.ca

**REVISIONS** DATE ISSUED FOR PERMIT / CONSTRUCTION PERMIT / CONSTRUCTION

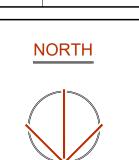

CHECKED

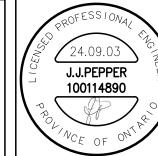

DRAWN

REVIEWED

PROJECT WHITEHERN HOUSE

KITCHENETTE DESIGN

**ADDRESS** 

TM

JP

41 JACKSON STREET HAMILTON, ON

PROJECT NO.

CE-5977

**MECHANICAL** 

**SPECIFICATIONS** 

DRAWING NUMBER

DRAWING TITLE

#### ELECTRICAL GENERAL REQUIREMENTS

REPRESENTATIVES.

#### **GENERAL CONDITIONS:**

- ALL WORK SHALL BE IN ACCORDANCE WITH THE LATEST EDITION OF THE ONTARIO ELECTRICAL SAFETY CODE, THE LOCAL ELECTRICAL SAFETY AUTHORITY INSPECTION OFFICE, THE ONTARIO BUILDING CODE, THE ONTARIO FIRE CODE AND ANY OTHER LOCAL REGULATIONS HAVING JURISDICTION OVER THE WORK OF THIS TRADE.
- BEFORE TENDERING, EXAMINE THE SITE AND ALL DRAWINGS AND SPECIFICATIONS OF ALL TRADES AND BE FAMILIAR WITH THE WORK OF THIS TRADE. NO EXTRAS WILL BE ALLOWED FOR THE FAILURE TO DO SO.
- ALL ELECTRICAL WORK SHALL COMPLY WITH CSA ELECTRICAL BULLETIN APPLICABLE AT TENDER CLOSE. WHERE SPECIFIC BULLETINS ARE NOT NAMED THEY ARE STILL CONSIDERED AN INTEGRAL PART OF THIS SPECIFICATION.
- PROVIDE ALL GROUNDING AND BONDING TO GROUND REQUIRED, REGARDLESS IF NOT SHOWN ON THE DRAWINGS. GROUNDING SHALL BE IN ACCORDANCE WITH THE REQUIREMENTS OF THE ONTARIO ELECTRICAL SAFETY CODE.
- PROVIDE ALL NEW MATERIALS HAVING CSA. CUL. WARNOCK HERSEY OR OTHER APPROVAL AGENCY LABEL AND LISTING. ALL WORKMANSHIP BY THIS TRADE SHALL BE FIRST CLASS, CONFORMING TO INDUSTRY STANDARD PRACTICES FOR SAFETY. ACCESSIBILITY, DURABILITY AND NEATNESS FOR ACCEPTANCE BY THE OWNERS'
- ARRANGE AND PAY FOR ALL PERMITS AND INSPECTION FEES REQUIRED FOR THE WORK OF THIS TRADE. SUBMIT TO THE LOCAL ELECTRICAL INSPECTION DEPARTMENT AND/OR ELECTRICAL SUPPLY AUTHORITY ANY AND ALL DRAWINGS REQUIRED FOR PERMITS, FEES, APPROVALS, EXAMINATIONS AND SERVICES.
- PROVIDE ALL CUTTING AND PATCHING REQUIRED FOR THE WORK OF THIS TRADE. ALL CUTTING AND PATCHING SHALL BE PERFORMED BY QUALIFIED TRADES PERSONS. INCLUDE ALL COSTS FOR CUTTING AND PATCHING RELATED TO THE WORK OF THIS TRADE IN THE TENDER PRICE.
- PROVIDE ALL SLEEVES, INSERTS AND HANGERS REQUIRED FOR THE ELECTRICAL WORK. TREAT ALL SLEEVES OR HOLES PIERCING ACOUSTICAL SEPARATIONS FOR INSTALLATIONS OF THE DIVISION TO MAINTAIN ACOUSTICAL RATING. ALL GAPS SHALL BE PACKED WITH ACOUSTICAL INSULATION AND SEALED AT BOTH ENDS WITH ACOUSTICAL CAULKING. PATCH ALL OPENINGS AROUND INSTALLATIONS OF THIS DIVISION PIERCING FIRE OR SMOKE SEPARATIONS WITH AN APPROVED WATERTIGHT SMOKE AND FIRE STOP SEALANT.
- PROVIDE ACCESS PANELS AS FOLLOWS: SHEET STEEL CONSTRUCTION WITH FACTORY APPLIED PRIME COAT OF PAINT. POSITIVE LATCHING SYSTEM. MINIMUM 18 GAUGE STEEL, PROVIDE HINGED DOORS FOR ALL ACCESS PANELS WITH A SIZE OF 450mm x 450mm (18" x 18") OR LARGER. WHERE THE ACCESS DOOR IS LOCATED IN A FIRE RATED ASSEMBLY OR A FIRE SEPARATION HAVING A FIRE RESISTANCE RATING, PROVIDE ACCESS DOORS WHICH ARE ULC LISTED FOR THE REQUIRED FIRE RESISTANCE RATING ALLOWED BY THE ONTARIO BUILDING CODE.
- TOUCH-UP ALL SHOP PAINTED EQUIPMENT DAMAGED IN TRANSIT OR DURING INSTALLATION TO MATCH ORIGINAL SHOP FINISH.
- AVOID ACCUMULATION OF DEBRIS AS THE WORK PROGRESSES. ON COMPLETION OF THE CONSTRUCTION AND PRIOR TO THE FINAL INSPECTION AND ACCEPTANCE BY THE OWNER, CLEAN UP AND REMOVE FROM THE SITE ALL SCRAP MATERIALS RESULTING FROM THE WORK OF THIS TRADE.
- CO-ORDINATE THE WORK OF THIS TRADE WITH ALL OTHER TRADES ON THE JOB SO THAT THE WORK MAY PROGRESS WITHOUT ANY DELAY. SCHEDULE AND PHASE DEMOLITION AND NEW WORK TO REDUCE INTERFERENCE AND DOWNTIME OF EXISTING SYSTEMS. NOTIFY OWNER'S REPRESENTATIVE OF ALL DOWNTIME PRIOR TO
- IN AREAS WHERE SPACE IS LIMITED AND MULTIPLE TRADES ARE INSTALLING SERVICES, COORDINATE INSTALLATION OF SERVICES. PREPARE INTERFERENCE DRAWINGS PRIOR TO CONSTRUCTION TO ENSURE INSTALLATION OF ALL SERVICES IS COORDINATED.
- PRIOR TO THE FINAL INSPECTION, CLEAN ALL ELECTRICAL EQUIPMENT. CLEAN ALL CONSTRUCTION DUST AND DIRT FROM INSTALLED EQUIPMENT AT THE END OF THE JOB. REPAIR ANY DAMAGE CAUSED BY THE ELECTRICAL TRADE TO EXISTING BUILDINGS OR EQUIPMENT, ETC TO THE CONSULTANTS SATISFACTION.
- UPON COMPLETION OF THE WORK, PROVIDE THE FINAL UNCONDITIONAL CERTIFICATE OF ACCEPTANCE FROM THE LOCAL ELECTRICAL SAFETY AUTHORITY INSPECTION
- PROVIDE A ONE YEAR GUARANTEE ON ALL MATERIALS, AND LABOUR FROM THE DATE OF ACCEPTANCE BY THE OWNER. COMPLETE ALL WARRANTY REGISTRATION DOCUMENTATION ON BEHALF OF THE BUILDING OWNER. SUBMIT COPIES OF COMPLETED DOCUMENTATION IN OPERATIONS AND MAINTENANCE MANUALS.
- ON MULTI-PHASE FEEDERS AND PANELS, ADJUST THE PHASE LOADING SO AS NOT TO EXCEED A PHASE IMBALANCE OF 10%, LINE TO LINE, UNDER NORMAL OPERATING CONDITIONS OF THE FEEDER OR PANEL.
- SUBMIT SHOP DRAWINGS IN ELECTRONIC PDF FORMAT FOR THE FOLLOWING EQUIPMENT: BREAKERS, FIRE ALARM DEVICES, EXIT AND EMERGENCY LIGHTING UNITS, ETC. THE SHOP DRAWINGS SHALL BEAR THE NAME OF THE MANUFACTURER, THE MANUFACTURER'S CATALOGUE NUMBER, AND THE CONSULTANT'S DESIGNATION, ALONG WITH ALL PERTINENT INFORMATION PERTAINING TO THAT SPECIFIC PIECE OF EQUIPMENT.
- ALL ELECTRICAL EQUIPMENT SHALL BE MOUNTED PLUMBED TRUE.
- DEVICE BOXES SHOWN BACK TO BACK SHALL BE OFFSET A MINIMUM OF 305mm (12") TO REDUCE SOUND TRANSMISSION BETWEEN ROOMS.

## AS-BUILT DRAWINGS:

- MAINTAIN AN ACCURATE RECORD OF DEVIATIONS AND CHANGES FROM CONTRACT DRAWINGS WITH RED LINE MARKINGS. TRANSFER AS-BUILT MARK-LIPS TO DIGITAL DRAWING FORMAT. THIS PROCESS SHOULD BE COMPLETED BEFORE THE FINAL INSPECTION BY THE CONSULTANT. SUBMIT TO THE CONSULTANT WITH THE O&M MANUALS AT COMPLETION OF THE PROJECT.
- FORMAT FILES TO MATCH EXACTLY THE LAYERING SYSTEM AND SYMBOLOGY OF THE CONSULTANT. BIND ALL EXTERNAL REFERENCES.
- 21.3. THIS PROJECT UTILIZED THE FOLLOWING DIGITAL FORMAT(S): AUTOCAD/PDF.
- WHERE THE WORD PROVIDE IS USED IN THESE SPECIFICATIONS OR ON THE DRAWINGS, IT HAS THE MEANING "PROVIDE AND INSTALL COMPLETE WITH ALL ASSOCIATED MOUNTING HARDWARE AND CONNECTIONS".

## CHANGES IN THE WORK

- CHANGES TO THE CONTRACT REQUIRING ADDITIONS TO OR DELETIONS FROM THE WORK OF THIS DIVISION SHALL BE CARRIED OUT UPON WRITTEN REQUEST OF THE CONSULTANT. EXTRAS TO THE CONTRACT OR CREDITS SHALL BE SUBMITTED WITH A COMPLETE COST BREAKDOWN AS FOLLOWS: MATERIALS, QUANTITIES AND UNIT PRICES FOR ALL EQUIPMENT REQUIRED OR DELETED. UNIT MAN HOURS TOTAL MATERIAL COST. TOTAL MAN HOURS. HOURLY RATE. (REFER TO SUPPLEMENTARY CONDITIONS AND GENERAL CONTRACT). TOTAL OVERHEAD AND PROFIT. (REFER TO SUPPLEMENTARY CONDITIONS AND GENERAL CONTRACT).
- ELECTRICAL PROJECT COMPLIANCE
- PROVIDE THE FOLLOWING DOCUMENTS TO THE CONSULTANT TO ISSUE THE LETTER OF GENERAL REVIEW:
- ESA INSPECTION REPORT A SIGNED VERIFICATION LETTER FROM THE ELECTRICAL CONTRACTOR CONFIRMING THE FOLLOWING: LIGHTING AND LIGHTING CONTROLS OPERATIONAL

#### **CONDUCTORS & RACEWAYS:**

- USE R90 COPPER CONDUCTORS CSA APPROVED FOR THE APPLICATION. CONDUCTORS IN WET LOCATION TO BE RW90. SIZE THE CONDUCTORS SO THAT THE MAXIMUM BRANCH CIRCUIT VOLTAGE DROP DOES NOT EXCEED 3%. MINIMUM CONDUCTOR SIZE IS #12 AWG UNLESS OTHERWISE INDICATED.
- DESIGN IS BASED ON COPPER CONDUCTORS. ALUMINUM CONDUCTORS ARE NOT
- ALL CONDUCTORS ARE TO BE INSTALLED IN RACEWAYS AS DESCRIBED BELOW:
- 3.1. PVC CONDUIT: IN CONCRETE SLAB, UNDERGROUND BURIED, BELOW SLAB ON GRADE OR EXTERIOR EXPOSED SURFACE RACEWAYS.

EMT RACEWAYS: INTERIOR SURFACE RACEWAYS, BRANCH CIRCUIT WIRING FROM

PANELS, CONCEALED IN ACCESSIBLE CEILINGS AND INTERIOR WALLS OR IN

- INTERIOR CONCRETE BLOCK CONSTRUCTION. ARMOURED CABLE (BX): FOR FINAL DROPS TO FIXTURES IN CEILING SPACES. (LENGTH NOT TO EXCEED 3M IN THIS APPLICATION) AND FOR EXISTING BLOCK
- SURFACE METAL RACEWAYS (SMR): FOR EXISTING CONSTRUCTION WHERE EXISTING WALLS AND FINISHES ARE TO REMAIN OR NEW SERVICES CANNOT BE FISHED IN EXISTING WALL
- OBTAIN PERMISSION FROM THE CONSULTANT PRIOR TO INSTALLATION. COLOUR AND SIZE OF RACEWAYS TO BE CONFIRMED WITH CONSULTANT FOR THE SPECIFIC APPLICATION.
- ALL CONDUIT AND WIRING IS TO BE CONCEALED IN ALL FINISHED AREAS.

# **DEVICES**:

- 1.1. SPECIFICATION GRADE RATED 15 AMP, 125 VAC, SINGLE POLE, SINGLE THROW.
- MANUFACTURERS: SMITH AND STONE, HARVEY HUBBEL, LEVITON, PASS AND

#### RECEPTACLES:

- SPEC GRADE, DUPLEX, RATED 15 AMP, 125 VAC, EEMAC 5-15R CONFIGURATION, U-GROUND.
- GROUND FAULT INTERRUPTING, CLASS A DUPLEX, RATED 15 AMP, 125 VAC, EEMAC 5-15R FIG.,TRIP RATED FOR 4-6 MA LEAKAGE CURRENT. C/W PUSH TO TEST AND RESET BUTTONS

#### COVER PLATES:

- 3.1. SMOOTHLINE BAKELITE, COLOUR TO MATCH SWITCHES AND RECEPTACLES.
- 3.2. BRUSHED STAINLESS STEEL, NUMBER 430, IN OFFICES AND KITCHENS
- COLOUR OF DEVICES: WHITE
- ALL DEVICES OF THE SAME TYPE, SIZE AND RATING ARE TO BE OF THE SAME MANUFACTURER THROUGHOUT THE PROJECT.

- PROVIDE FIXTURES COMPLETE WITH ALL ACCESSORIES MOUNTING HARDWARE, AND LAMPS AS SPECIFIED IN THE FIXTURE SCHEDULE OR AS APPROVED BY OWNERS AS AN EQUAL FIXTURE COMPLETE WITH MIN. 5 YEAR WARRANTY.
- PRODUCTS OF EQUAL QUALITY BY ALTERNATE MANUFACTURERS SUCH AS LITHONIA, SIGNIFY, COOPER, HUBBELL, AND CREE ARE ALSO ACCEPTABLE. PROVIDE PHOTOMETRIC CALCULATIONS ALONG WITH ALTERNATE FIXTURE SELECTIONS TO THE ENGINEER FOR REVIEW AT LEAST TWO FULL BUSINESS DAYS PRIOR TO TENDER
- FIXTURES WHICH ARE MARKED N.I.C. OR FIXTURES WITHOUT MARKINGS ARE TO BE PRICED FOR WIRING AND INSTALLATION ONLY AS PART OF THIS CONTRACT.
- LUMINAIRES TO BE SUPPORTED FROM THE STRUCTURE THROUGH THE USE OF APPROVED CHAINS TO MEET THE REQUIREMENTS OF THE OBC. SUPPORT FROM MECHANICAL OR ELECTRICAL SERVICES IS NOT PERMITTED.

## RENOVATIONS ON EXISTING BUILDING:

SPECIFICALLY NOTED OTHERWISE.

- RENOVATIONS SHALL BE MADE ON THE EXISTING BUILDING AS INDICATED ON THE DRAWINGS AND SPECIFIED HEREIN. REMOVE ALL EXISTING LUMINARIES, OUTLET BOXES, SWITCHES, RECEPTACLES, ETC, AS INDICATED ON DRAWINGS, ALL EQUIPMENT REMOVED AND NOT REUSED SHALL REMAIN THE PROPERTY OF THE OWNER UNLESS SPECIFICALLY NOTED OTHERWISE. ALL EQUIPMENT INSTALLED IN RENOVATED AREAS SHALL BE NEW. ELECTRICAL TRADE WILL BE RESPONSIBLE FOR ALL CUTTING AND PATCHING REQUIRED FOR ELECTRICAL INSTALLATION. ALL CONDUIT SHALL BE INSTALLED CONCEALED IN FINISHED AREAS UNLESS
- NEW CONDUCTORS SHALL BE INSTALLED TO THE NEAREST OUTLET AS REQUIRED FOR EQUIPMENT THAT IS RELOCATED. INSTALLATION OF JUNCTION BOXES FOR SPLICING PURPOSES SHALL NOT BE PERMITTED UNLESS SPECIFICALLY CALLED FOR.
- PROVIDE ALL CONDUCTORS REQUIRED TO RECONNECT EXISTING CIRCUITS WHERE REQUIRED THAT MAY BE DISRUPTED DUE TO RENOVATIONS ON THE EXISTING FLOOR.
- PROVIDE NEW BREAKERS WHERE REQUIRED IN EXISTING PANELS TO PICK-UP ADDITIONAL CIRCUITS INDICATED ON THE DRAWINGS.
- ALL EXISTING LUMINARIES THAT ARE RELOCATED SHALL BE REMOVED, CHECKED. SERVICED, CLEANED, AND RE-LAMPED PRIOR TO RE-INSTALLATION, ALL UNITS NOT REUSED SHALL BE TURNED OVER TO THE OWNER, COMPLETE WITH LAMPS.
- COORDINATE WITH MECHANICAL DRAWINGS AND SAFELY DISCONNECT AND REMOVE ALL MOTOR/MECHANICAL EQUIPMENT BEING DEMOLISHED. REMOVE UNUSED WIRING/CONNECTION BACK TO SOURCE PANEL. EXTEND WIRING/CONNECTION OF ALL MOTOR/MECHANICAL EQUIPMENT BEING RELOCATED. PROVIDE PROPER JUNCTION BOX AT EACH POINT OF EXTENSION.

LIGHTING FIXTURE SCHEDULE				
FIXTURE TAG DESCRIPTION AND MODEL SERIES		INPUT	LIGHT SOURCE	MOUNTING
AA	UNDER COUNTER FLEXIBLE LED STRIP LIGHT, HIGH OUTPUT, WET LOCATION SUITABLE. HARDWIRE POWER CONNECTOR. CONFIRM LENGTH WITH OWNER'S REPRESENTATIVE PRIOR TO ORDERING.  GM LIGHTING: V120-HO SERIES	120V 4W / FT	LED 305L / FT 2700K	SURFACE UNDER CABINET

PROVIDE ALL NECESSARY MOUNTING HARDWARE FOR A COMPLETE INSTALLATION. COORDINATE WITH ARCHITECTURAL PLANS TO CONFIRM CABINET MATERIAL AND MOUNTING TYPE.

	COMMUNICATION LEGEND		
SYMBOL	DESCRIPTION		
EX	EXISTING TO REMAIN		
<b>\$</b>	CEILING OR PENDANT LIGHT FIXTURE		
\$ <sub>P</sub>	PILOT LIGHT SWITCH		
Ф	DUPLEX RECEPTACLE		
Φ	DUPLEX RECEPTACLE - OVER COUNTER		
•	GFI RECEPTACLE - OVER COUNTER		
_	ELECTRICAL PANEL		
M	ELECTRICAL METER		
마	DISCONNECT		

#### GENERAL NOTES:

DRAWING NOTES (INDICATED WITH HEXAGONS):

JESIGN INTENT ONLY

OWNER'S REPRESENTATIVE

DETAIL #1 ON THIS DRAWING.

ELECTRICAL ROOM AS INDICATED.

CABINET. REFER TO DETAIL #1 ON THIS DRAWING.

PROVIDE POWER TO NEW LIGHTING AND DEVICES FROM EXISTING PANEL "A". REUSE

TO MEET THE DESIGN INTENT WHERE REQUIRED. CIRCUITING SHOWN IS FOR THE

CONFIRM PANEL "A" LOADS BEFORE CONNECTING NEW KITCHEN RECEPTACLES. IF

REQUIRED, UPGRADE THE POWER FEEDER OR PROVIDE AN ALTERNATIVE POWER

BY OWNER. COORDINATE EXACT MOUNTING HEIGHT AND LOCATION ON SITE WITH

UNDER COUNTER. COORDINATE EXACT LENGTH AND MOUNTING LOCATION ON SITE

WITH OWNER'S REPRESENTATIVE. IF NECESSARY, LOCATE LIGHT DRIVER DEVICE IN

3. INSTALL AND PROVIDE POWER CONNECTION FOR TAPE LIGHT SURFACE MOUNTED

4. GFI RECEPTACLES MOUNTED OVER COUNTER BETWEEN BASE CABINET AND UPPER

5. RECEPTACLE FOR MICROWAVE MOUNTED HIGH IN UPPER CABINET SPACE. REFER TO

DETAIL #1 - NORTH ELEVATION


SCALE: 3/4" = 1'-0"

SOURCE FROM THE NEAREST PANEL WITH AVAILABLE CAPACITY.

EXISTING CIRCUITS WHERE POSSIBLE. PROVIDE NEW CIRCUITS IN EXISTING PANEL "A"

- EXISTING ELECTRICAL DEVICES ARE SHOWN FOR THE DESIGN INTENT OF THIS PROJECT'S SCOPE OF WORK ONLY. NOT ALL EXISTING ELECTRICAL DEVICES ARE SHOWN. CONTRACTOR TO CONFIRM ON SITE. REPORT ANY DISCREPANCIES TO CONSULTANT FOR REVIEW AND APPROVAL PRIOR TO ANY WORK ACTIVITY.
- PROTECT ALL INTERIOR AND EXTERIOR FINISHES, CEILINGS, WALLS, FLOORS, ETC FROM DAMAGE DUE TO THE WORK OF THIS DIVISION.
- REPAIR ANY DAMAGE CAUSED BY THE ELECTRICAL TRADE TO EXISTING BUILDINGS OR EQUIPMENT, ETC., TO THE CONSULTANT SATISFACTION. UPON COMPLETION OF THE WORK, CLEAN ALL EQUIPMENT AND REMOVE FROM THE SITE ALL ELECTRICAL DEBRIS.
- ELECTRICAL EQUIPMENT TO BE REMOVED MUST BE ISOLATED AND DISCONNECTED AT THE SOURCE PRIOR TO REMOVAL OPERATIONS. DURING ISOLATION AND DISCONNECTION PROCEDURES DANGER TAGS MUST BE USED TO IDENTIFY ANY FEEDERS OR EQUIPMENT REMAINING ENERGIZED TO ACCOMMODATE NEW
- REMOVE ALL UNUSED, ABANDONED OR REDUNDANT WIRING AND CONDUIT BACK TO
- UNLESS OTHERWISE NOTED IN SPEC OR ON DRAWINGS, ALL EXISTING ELECTRICAL INSTALLATIONS (IE. SWITCHES, FIXTURES, OUTLETS, FIRE ALARM, SECURITY, COMMUNICATION ETC.) IN NON RENOVATED AREAS TO REMAIN AS PRESENTLY INSTALLED. MODIFY/EXTEND EXISTING CONTROL CIRCUITS AS REQUIRED TO MAINTAIN
- PROVIDE LEGIBLE SIGNS AND BARRIERS ON OR AROUND ALL LIVE PANELS AND EQUIPMENT DURING CONSTRUCTION TO PREVENT INJURY OR SHOCK.
- COORDINATE WITH FACILITY MAINTENANCE DEPARTMENT FOR DISPOSAL OF REMOVED. DEVICES. DISPOSE OF ALL UNWANTED DEVICES AS REQUIRED AS PER FACILITY STANDARDS.

- ELECTRICAL EQUIPMENT BEING REMOVED AND NOT BEING REUSED WILL REMAIN THE PROPERTY OF THE OWNER. EQUIPMENT THE OWNER DOES NOT WANT WILL BE DISPOSED OF BY THE CONTRACTOR. CONTRACTOR TO ENSURE ALL CONSTRUCTION WASTE, GARBAGE AND DEBRIS IS REMOVED FROM SITE AND PROPERLY DISPOSED.
- TRACE EXISTING CIRCUITS ON SITE TO CONFIRM EXTENT OF CIRCUITS.
- FIXTURES AND DEVICES SHOWN ON THE PROPOSED LAYOUT DRAWINGS ARE NEW UNLESS OTHERWISE SPECIFIED.
- PRIOR TO INSTALLATION OF DEVICES WITHIN WALLS, VERIFY THAT NO INTERFERENCES EXIST. CONFIRM ON SITE WITH OWNER AND DESIGNER FOR EXACT DEVICE LOCATIONS AND ELEVATIONS.
- EXISTING RACEWAYS AND/OR WIRING IN VERY GOOD CONDITION MAY BE REUSED FOR NEW EQUIPMENT IF SUITABLE, CONFIRM ON SITE. SUBJECT TO CODE COMPLIANCE. REMOVE ALL REDUNDANT RACEWAYS
- PROVIDE NEW BREAKERS IN EXISTING LIGHTING PANELS TO FEED NEW LIGHT FIXTURES. ALLOW FOR A MAXIMUM 70% LOAD PER LIGHTING CIRCUIT.
- PROVIDE UPDATED, TYPE-WRITTEN PANEL DIRECTORY AT PANEL DOORS, COORDINATE WITH OWNER'S REPRESENTATIVE FOR EXACT LOCATION OF ELECTRICAL AND LIGHTING
- CONFIRM WITH OWNER'S REPRESENTATIVE AND COORDINATE EXACT POWER REQUIREMENT WITH EQUIPMENT RATINGS. SIZE BREAKER AND FEEDERS ACCORDINGLY IN COMPLIANCE WITH LATEST O.E.S.C.
- CONFIRM FIXTURE SELECTION AND REQUIREMENTS WITH THE OWNER'S REPRESENTATIVE PRIOR TO ORDERING.
- ALL ELECTRICAL EQUIPMENT TO BE INSTALLED IN ACCORDANCE WITH MANUFACTURER RECOMMENDATIONS AND IN COMPLIANCE WITH THE LATEST O.E.S.C.

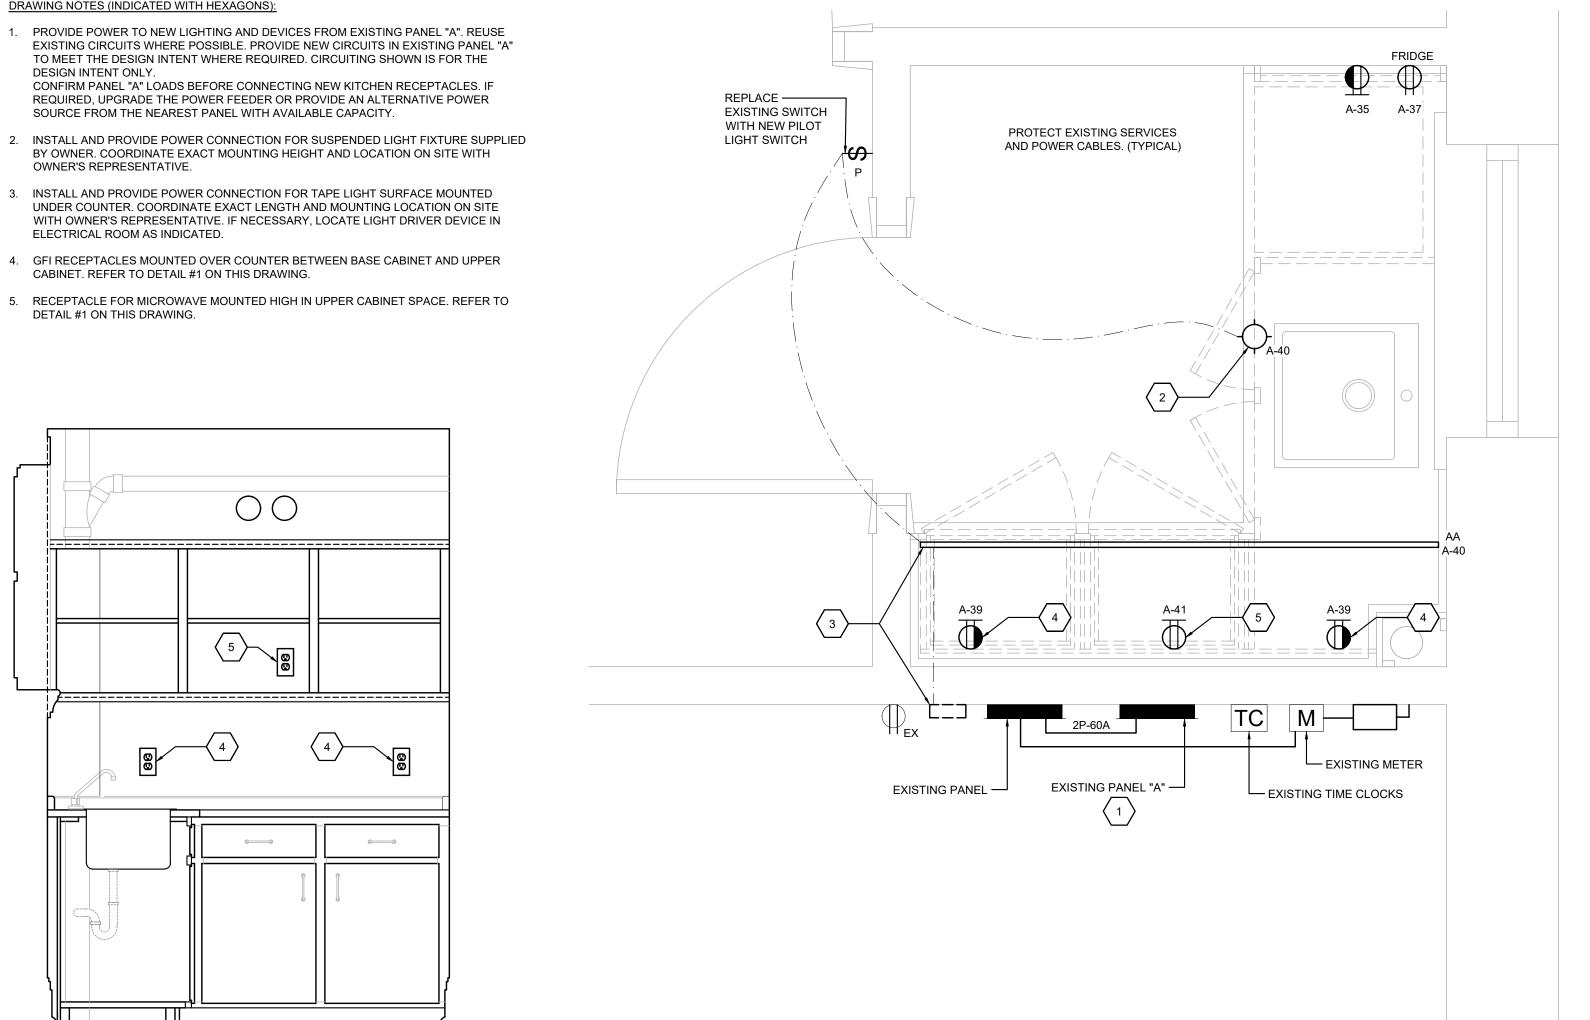



PARTIAL BASEMENT FLOOR PLAN - ELECTRICAL LAYOUT




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REVIEWED

PROJECT

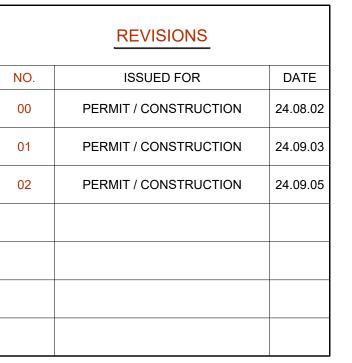IC

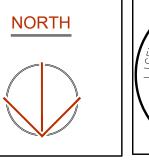CHECKED

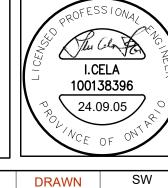WHITEHERN HOUSE

KITCHENETTE DESIGN

ADDRESS

41 JACKSON STREET. HAMILTON, ON

PROJECT NO.

CE-5977

DRAWING TITLE

FLOOR PLAN, LEGEND, **DETAILS & SPECIFICATIONS -ELECTRICAL** 

DRAWING NUMBER

**E1** OF 1