

<u>GRIL</u>	LE SCHEDULE	(PHA	ASE 1		CAPACITY INDICATED ON SCHEDULE REFER TO SPECIFICATION FOR CONSTRUCTION STANDARDS, ACCESSORIES AND ADDITIONAL INFORMATION.
Item	Туре	Equalizing Grid	Volume Damper	Acceptable Manufacturer	Description
D1	SQUARE CEILING DIFFUSER	NO	NONE	KRUEGER 1400A	4-CONE, FULLY ADJUSTABLE, 24x24, STEEL CEILING DIFFUSER W/ROUND NECK. SUITABLE FOR LAY-IN T-BAR CEILING, OR DRYWALL CEILING WHEN C/W FRAME.
	CEILING RETURN GRILLE (NON-DUCTED)	NO	NONE	KRUEGER EG-5	1/2x1/2x1/2 ALUMINUM EGGCRATE CORE, C/W CHANNEL BORDER FOR LAY-IN T-BAR CEILING.
	CEILING RETURN GRILLE (DUCTED)	NO	NONE	KRUEGER S580	FIXED BLADE AT 45°, 1/2" SPACING, EXTRUDED ALUMINUM AIRFOIL BLADES PARALLEL TO LONG DIMENSION, C/W 1 1/4" FLAT BORDER & SCREWED FASTENING FOR SURFACE MOUNTING.
R3	SIDEWALL RETURN	NO	NONE	KRUEGER S85	FIXED BLADE AT 45°, 1/2" SPACING, EXTRUDED ALUMINUM AIRFOIL BLADES PARALLEL TO LONG DIMENSION, C/W 1 1/4" FLAT BORDER & SCREWED FASTENING FOR SURFACE MOUNTING.

1. ACCEPTABLE MANUFACTURERS: EH PRICE, NAILOR, TITUS, KRUEGER, CARNES, METALAIRE, TUTTLE & BAILEY

2. GRILLE COLOURS ARE SELECTED BY ARCHITECT FROM STANDARD COLOUR CHART, UNLESS OTHERWISE NOTED. 3. PAINT INTERIOR OF DUCTWORK BEHIND GRILLE MATT BLACK (WHERE VISIBLE THRU GRILLE).

<u>MECHA</u>	NICAL LEGEND				
Item	Description	Item	Description	Item	Description
	CUT EXISTING & CONNECT NEW PIPING	— —HWR— —	HEATING WATER RETURN PIPING	TCV	TEMPERATURE CONTROL VALVE
—	FLOW DIRECTION	——G——	NATURAL GAS PIPING	▼ FE	WALL MOUNTED FIRE EXTINGUISHER
	DOMESTIC COLD WATER PIPING	——НРБ——	HIGH PRESSURE NATURAL GAS PIPING	☐ FB	FIRE BLANKET
	DOMESTIC HOT WATER PIPING	FD % →	FLOOR DRAIN	o ^{co}	FLOOR CLEANOUT
- NP - ·	NON-POTABLE DOMESTIC COLD WATER PIPING	FD & —	FLOOR DRAIN WITH BACKWATER VALVE	——I co	LINE CLEANOUT
	NON-POTABLE DOMESTIC HOT WATER PIPING	- 79-P-	TRAP PRIMER	СФ	THERMOSTAT (WITH OR WITHOUT GUARD)
	DOMESTIC HOT WATER RECIRC. PIPING		TEE CONNECTION	GФ	HUMIDISTAT (WITH OR WITHOUT GUARD)
——··-т—	DOMESTIC TEMPERED WATER PIPING	—	PIPE DOWN	_C	CARBON DIOXIDE (CO2) SENSOR (WITH OR WITHOUT GUARD)
——·—н—	DOMESTIC HARD COLD WATER PIPING	•—	PIPE UP)))))	TURNING VANES
s-	DOMESTIC SOFT COLD WATER PIPING		CHECK VALVE		SUPPLY AIR DUCT
EX-SAN-	EXISTING SANITARY PIPING ABOVE FLOOR	~7	BACKFLOW PREVENTOR		RETURN/EXHAUST AIR DUCT
EX-SAN-	EXISTING SANITARY PIPING BELOW FLOOR	─ 1 © 1 Z 1 © 1	DOUBLE CHECK VALVE ASSEMBLY (DCVA) BACKFLOW PREVENTOR		ACOUSTIC DUCT LINING
— —SAN — —	SANITARY PIPING ABOVE FLOOR		UNION	— BD	BALANCING DAMPER
——SAN——	SANITARY PIPING BELOW FLOOR		STRAINER	M	MOTORIZED DAMPER (OPPOSED BLADE)
- PD-SAN	PUMPED SANITARY PIPING	—— I	SCREWED OR WELDED PIPE CAP	— FD	FIRE DAMPER
—— AW ——	ACID WASTE	NO	NORMALLY OPEN		FLEXIBLE ROUND DUCT
- — AV — –	ACID VENT PIPING	NC	NORMALLY CLOSED		RIGID ROUND DUCT
-EX-STM· —	EXISTING STORM PIPING ABOVE FLOOR	—— 	PLUG VALVE	——AL ——	ALUMINUM DUCT
-EX-STM· ——	EXISTING STORM PIPING BELOW FLOOR	——IдI——	BALL VALVE	Type Size Cap.	DIFFUSER/GRILLE SIZE (imp), TYPE & CAPACITY (cfm)
—STM-·—	STORM PIPING ABOVE FLOOR	——іі——	BUTTERFLY VALVE	Size 1 Type Size 2	HYDRONIC HEATING SIZE,
—STM-·—	STORM PIPING BELOW FLOOR	——X ——	GATE VALVE	Capacity	TYPE & CAPACITY
——CD——	CONDENSATE PIPING		MOTORIZED VALVE ACTUATOR	RIC	RETURN IN CABINET
	VENT PIPING		CONTROL VALVE ACTUATOR	AFF	ABOVE FINISHED FLOOR
——F——	STANDPIPE PIPING		SOLENOID VALVE	AFR	ABOVE FINISHED ROOF
——SP——	SPRINKLER PIPING	≮ G——	RISER VALVE	CTE	CONNECT TO EXISTING
——DSP——	DRY SPRINKLER PIPING	BV BV	BALANCING VALVE	PD	PUMPED
——нws——	HEATING WATER SUPPLY PIPING	— ⋈ S	SUPERVISING VALVE	— ЕХ —	EXISTING DUCT (SIZE AS INDICATED)

GENERAL NOTES

- ALL DRAWINGS ARE TO BE READ IN CONJUNCTION WITH THE PREPARED SPECIFICATION.
- REFER TO SPECIFICATIONS FOR DETAILS REGARDING REQUIRED SHOP DRAWINGS SUBMISSIONS, INDEPENDENT SITE TESTING, AND SITE WORK NOTIFICATIONS.
- UPON COMPLETION OF THE PROJECT OR UPON COMPLETION OF EACH INDIVIDUAL PHASE OF THE PROJECT THE CONTRACTORS SHALL PROVIDE THE FOLLOWING CERTIFICATES BEFORE CONFORMANCE LETTERS ARE ISSUED BY THE CONSULTANT:

 POTABLE WATER TEST (SEE SPEC 22 11 16 PART 3)
- BACKFLOW TEST CERTIFICATE(S) FOR ALL TESTABLE DEVICES
 COPY OF MANDATORY TSSA/CSA-B149 GAS PRESSURE TEST TAG
- LETTER FROM CONTRACTOR VERIFYING THAT ALL REFRIGERATION LEAK DETECTION SYSTEMS AND THEIR INTERLOCKS TO
- DOWNSTREAM DEVICES HAVE BEEN INSTALLED AND TESTED. - TSSA CERTIFICATE OF AUTHORIZATION FOR SPLIT AIR CONDITIONING SYSTEMS (EXCEEDING 5 TONS)
- ALL CERTIFICATES ARE TO BE SUBMITTED TOGETHER IN A SINGLE PACKAGE.

	CUSTO	M INDOC	<u>)r air i</u>	<u>IANDLIN</u>		SCHEDUL	E (PHA	ASE 2	.)																		*ESP I	S EXTERNAL TO THE CABINET
	Item	Туре	Service	Capacity Si		r Fan Data ESP Voltage	MCA MOCE	Capacity Si	Exhaust Air Size Drive ESF	r Fan Data P Voltage Med	dium Coil	Sens.Cap. Tot		OOLING Ent LVG	Face Vel.	PD. Air M	HEA edium Capacity	ATING EAT_db La	AT_db Flow (apr	n) Type	Model		Cooling Capacity (MBH		Manufacturer	Model	Weight (lbs)	Remarks
╁	IND 5 IND	OOR BUILT UP AIR	CLASSROOM	15 000 2	9 VARIABLE	in wc	440 405	cfm h	hp billet in w	WC 5	туре		1	i. db/wb db/w	ipiii d	ın.	МВП	Г	•F 1.0 (9P)	SEGMENTED	SG AMERICA		@ 88° db/75° wb			AIDDAIA	(dpprox.)	C/W SEGMENTED ENERGY RECOVERY WHEEL, SUPPLY VFD, DIRECT DRIVE RETURN FAN ECM MOTORS.
\perp	HAI	IDLING UNIT	ADDITION	15,000 10	HP FREQUENCY DRIVE	1.25 208/3/60	118 125	7	.5 DIRECT DRIVE 1.0	208/3/60 R4	10A DX	453	504 8/8	80/66 53/5	01 495	0.95 W	AIER /89	40 1	160 82	WHEEL	HPR-1500T20	4/1	197	0.66 HA	AAKON	AIRPAK	13500±	VARIABLE SPEED COMPRESSORS, ERW ECONOMIZER BYPASS (FREE COOLING), 200mm HIGH BASE. UNIT SHALL HAVE A MINIMUM OF 2 REFRIGERATION CIRCUITS. MINIMUM SCCR RATING FOR HVAC-5
	GENERAL NOT - ACCEPTA	'ES: ABLE MANUFACTUF	RERS: HAAKON,	DAIKIN, AAON,	ENVENT, ENGINEE	RED AIR			STANT FASTENERS.					- 2" (50mn	n) MERV 8	FILTERS (OUTDOOR &	EXHAUST AI	IRSTREAMS).		_	CONTROLS LIT	E PACKAGE (ALI	L UNIT CON	NTROLS SHALL BE I	PROVIDED BY THE		SHALL BE 14KAIC.
		IPPED IN SECTION CONSTRUCTION.			N TO SITE DURING I ALLOWANCES.	G		UNDERFLOC ACCESS D	OR LINER FACTOR DOORS.	PAINTED TO MATO	CH UNIT CASI	NG FINISH.		- LOW LEAK						ft2 @ 1.0"		CONTROLS CO	NTRACTOR).		COIL, HOT GAS REH			
	DOUBLE				FOAM INSULATION	&			NON FUSED DISCON / 13 FILTERS (SUP						D RELIEF D	AMPER, SI	PRING RETURI	N OUTDOOR	AIR DAMPER	R (DAMPERS	_	SEGMENTED U	•	F AIR SOUR	RCE HEAT PUMP SY			

INDO	DOR	: VF	RF BR/	ANCH SE	ELECTOR	вох	SCHED	<u>JLE</u>	
Item	MCA	моср	Voltage	Manufacturer & model	Remarks				
BS-1A	0.4	15	208/1/60	DAIKIN BSF4Q54TVJ					
BS-1B	0.4	15	208/1/60	DAIKIN BSF4Q54TVJ					
BS-1C	0.4	15	208/1/60	DAIKIN BSF4Q54TVJ					
BS-2A	0.4	15	208/1/60	DAIKIN BSF4Q54TVJ					
BS-2B	0.4	15	208/1/60	DAIKIN BSF4Q54TVJ					
BS-2C	0.4	15	208/1/60	DAIKIN BSF4Q54TVJ					

<u>AIR</u>		Cooling Cap	DENSII acity (BTU/h)		Piping	Connectio		<u>ULE</u>	ectrical		
Item	Туре	Total Cooling	Heating Cooling	Refrig.	Liquid	LP Gas	` ′	Voltage	MCA	МОСР	Manufacturer & Model
CU-3A1	OUTDOOR ROOF MOUNTED	147.0	166.0	R410A	3/4	1-3/8	1-1/8	208/3/60	61.9	70	DAIKIN REYQ33XBTJA
CU-3A2	OUTDOOR ROOF MOUNTED	147.0	166.0	R410A	3/4	1-3/8	1-1/8	208/3/60	61.9	70	DAIKIN REYQ33XBTJA
CU-3B1	OUTDOOR ROOF MOUNTED	147.0	166.0	R410A	3/4	1-3/8	1-1/8	208/3/60	61.9	70	DAIKIN REYQ33XBTJA
CU-3B2	OUTDOOR ROOF MOUNTED	147.0	166.0	R410A	3/4	1-3/8	1-1/8	208/3/60	61.9	70	DAIKIN REYQ33XBTJA

Item	Service	Design Capacity(cfm)	Size	Item	Service	Design Capacity(cfm)	Size
BPD-5.0A	HVAC-5		900x300	WT-5.14	CHEMISTRY LAB A212	600	350x200
BPD-5.0B	HVAC-5		900x300	WT-5.15	CHEMISTRY LAB A210	600	350x20
				WT-5.16	CHEMISTRY LAB A210	600	350x20
WT-5.1	CLASSROOM A215 & SEWING/ FASHION ARTS A217	1600	400x350	WT-5.17	PREP ROOM A208	450	250x22
WT-5.2	BUSINESS A213	600	350x200	WT-5.18	BIOLOGY A206	600	350x20
WT-5.3	BUSINESS A213	600	350x200	WT-5.19	BIOLOGY A206	600	350×20
WT-5.4	BIOLOGY LAB A211	600	350x200	WT-5.20	PREP ROOM A204	450	250x22
WT-5.5	BIOLOGY LAB A211	600	350x200	WT-5.21	PHYSICS A202	300	225x20
WT-5.6	COMPUTERS A209	600	350x200	WT-5.22	PHYSICS A202	300	225x20
WT-5.7	COMPUTERS A209	600	350x200	WT-5.23	WORKROOM A118	100	250×10
WT-5.8	DEPT HEAD A207	150	175x150	WT-5.24	TECH OFFICE A118A	150	250×10
WT-5.9	DEPT HEAD A207	150	175x150	WT-5.25	STORAGE A114C	150	250×10
WT-5.10	ART & MARKETING A205	1000	400x300	WT-5.26	EDIT A114B	150	250×10
WT-5.11	DARK ROOM N200	500	300x200	WT-5.27	STORAGE A114A	150	250×10
WT-5.12	ART A216 & ART A218	2000	500x350				
WT-5.13	CHEMISTRY LAB A212	600	350×200				


PUM	IP SCHEDU	<u>JLE</u>						CAPACITY INDICATED ON SCHEDULE REFER TO SPECIFICATION FOR CONSTRUCTION STANDARDS, ACCESSORIES AND ADDITIONAL INFORMATION.
ltem	Туре	Capacity USgpm	Head ft	Size hp	Speed rpm	Manufacturer & Model	Remarks	
P-10	CIRCULATION PUMP	82	10	0.5	1800	BELL & GOSSETT e-90 2AAB	208/3/60. ACCEPTABLE ALTERNATIVES: ARMSTRONG, MYERS. TACO, HYDROMATIC	


	Tuno	Capacity	ESP	Fan Speed		Motor	Acceptable	Description
Item	Туре	cfm	in wc	rpm	hp	Voltage	Manufacturer	Description
EF-5	ROOF UPBLAST EXHAUST FAN (CHEMISTRY)	1200	0.375	1375	1/4	120/1/60	PENN BARRY 12BH	SPUN ALUMINUM MOTOR COVER & FAN SHROUD, UPBLAST, W/BELT DRIVE CENTRIFUGAL BACKWARD INCLINED FAN, GALV BIRD SCREEN, 24" HIGH INSULATED ROOF CURB, & BACKDRAFT DAMPER
EF-6	ROOF UPBLAST EXHAUST FAN (BIOLOGY)	1200	0.375	1375	1/4	120/1/60	PENN BARRY 12BH	SPUN ALUMINUM MOTOR COVER & FAN SHROUD, UPBLAST, W/BELT DRIVE CENTRIFUGAL BACKWARD INCLINED FAN, GALV BIRD SCREEN, 24" HIGH INSULATED ROOF CURB, & BACKDRAFT DAMPER
EF-7	ROOF UPBLAST EXHAUST FAN (FUME HOOD)	800	1.0	3135	3/4	208/3/60	PENN BARRY VPLUME 090-6	CONNECT TO FUMEHOOD. SPUN ALUMINUM MOTOR COVER & FAN SHROUD, UPBLAST, W/BELT DRIVE FAN, GALV BIRD SCREEN, 24" HIGH INSULATED ROOF CURB, & BACKDRAFT DAMPER
EF-8	INLINE DUCT MOUNTED EXHAUST	450	0.25	1550	Fhp	120/1/60	PENN BARRY Z10H	C/W VIBRATION ISOLATION HANGERS. <u>REVERSE-ACTING THERMOSTAT BY ELECTRICAL DIVISION</u>

<u>ACII</u>	O NEU	<u>TRALI</u>	<u>ZING</u>	TANI	K SCHE	DULE (PHASE	<u>(1)</u>
ltem	Туре	Empty Capacity gal.	Actual Capacity gal.	Limestone Charge Ibs		Manufacturer	Model	Remarks
NT-1	MOUNTED ON FLOOR	68	30	900	30"ø x 42"	SMS	AN-170	MOUNT FLUSH WITH FLOOR C/W FRAME RING, TRUSS HEAD BOLTS, HOT SUNK SECURING NUTS, 3/32" THICK NON-SKID STILL TOP & EXTENSION C/W MONITOR PANEL.
SI-1	MOUNTED IN MILLWORK	N/A	N/A	N/A	8.5"ø x 12.5"	SMS	SI-MQ	INSTALL IN MILLWORK BELOW SINK. FOR LOCATIONS & QUANTITIES, REFER TO PLANS.

The contractor shall verify all dimensions and report all errors and discrepancies to the Consultant before commencement of the work. The drawings show general arrangement of services. Follow as closely as actual building construction will permit. Obtain approval for relocation of service from Consultant before commencement of the work. The drawings do not indicate all offsets fitting and accessories which may be required. Provide the same to meet the required conditions. Drawings and specifications, etc., prepared and issued by the consultant are the property of the consultant and must be returned at the completion of the project. These documents are not to be duplicated or copied without the consent of the Consultant. Do not scale this drawing. © 2025 DEI Consulting Engineers.

No.	revisions	DATE
1	ISSUED FOR 75% REVIEW	2025.01.3
2	ISSUED FOR PERMIT & TENDER	2025.03.0
3	ISSUED FOR ADDENDUM 1	2025.03.20
4	ISSUED FOR CONSTRUCTION	2025.05.14

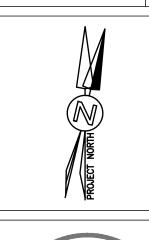

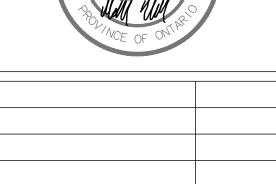


M.B. WHITE







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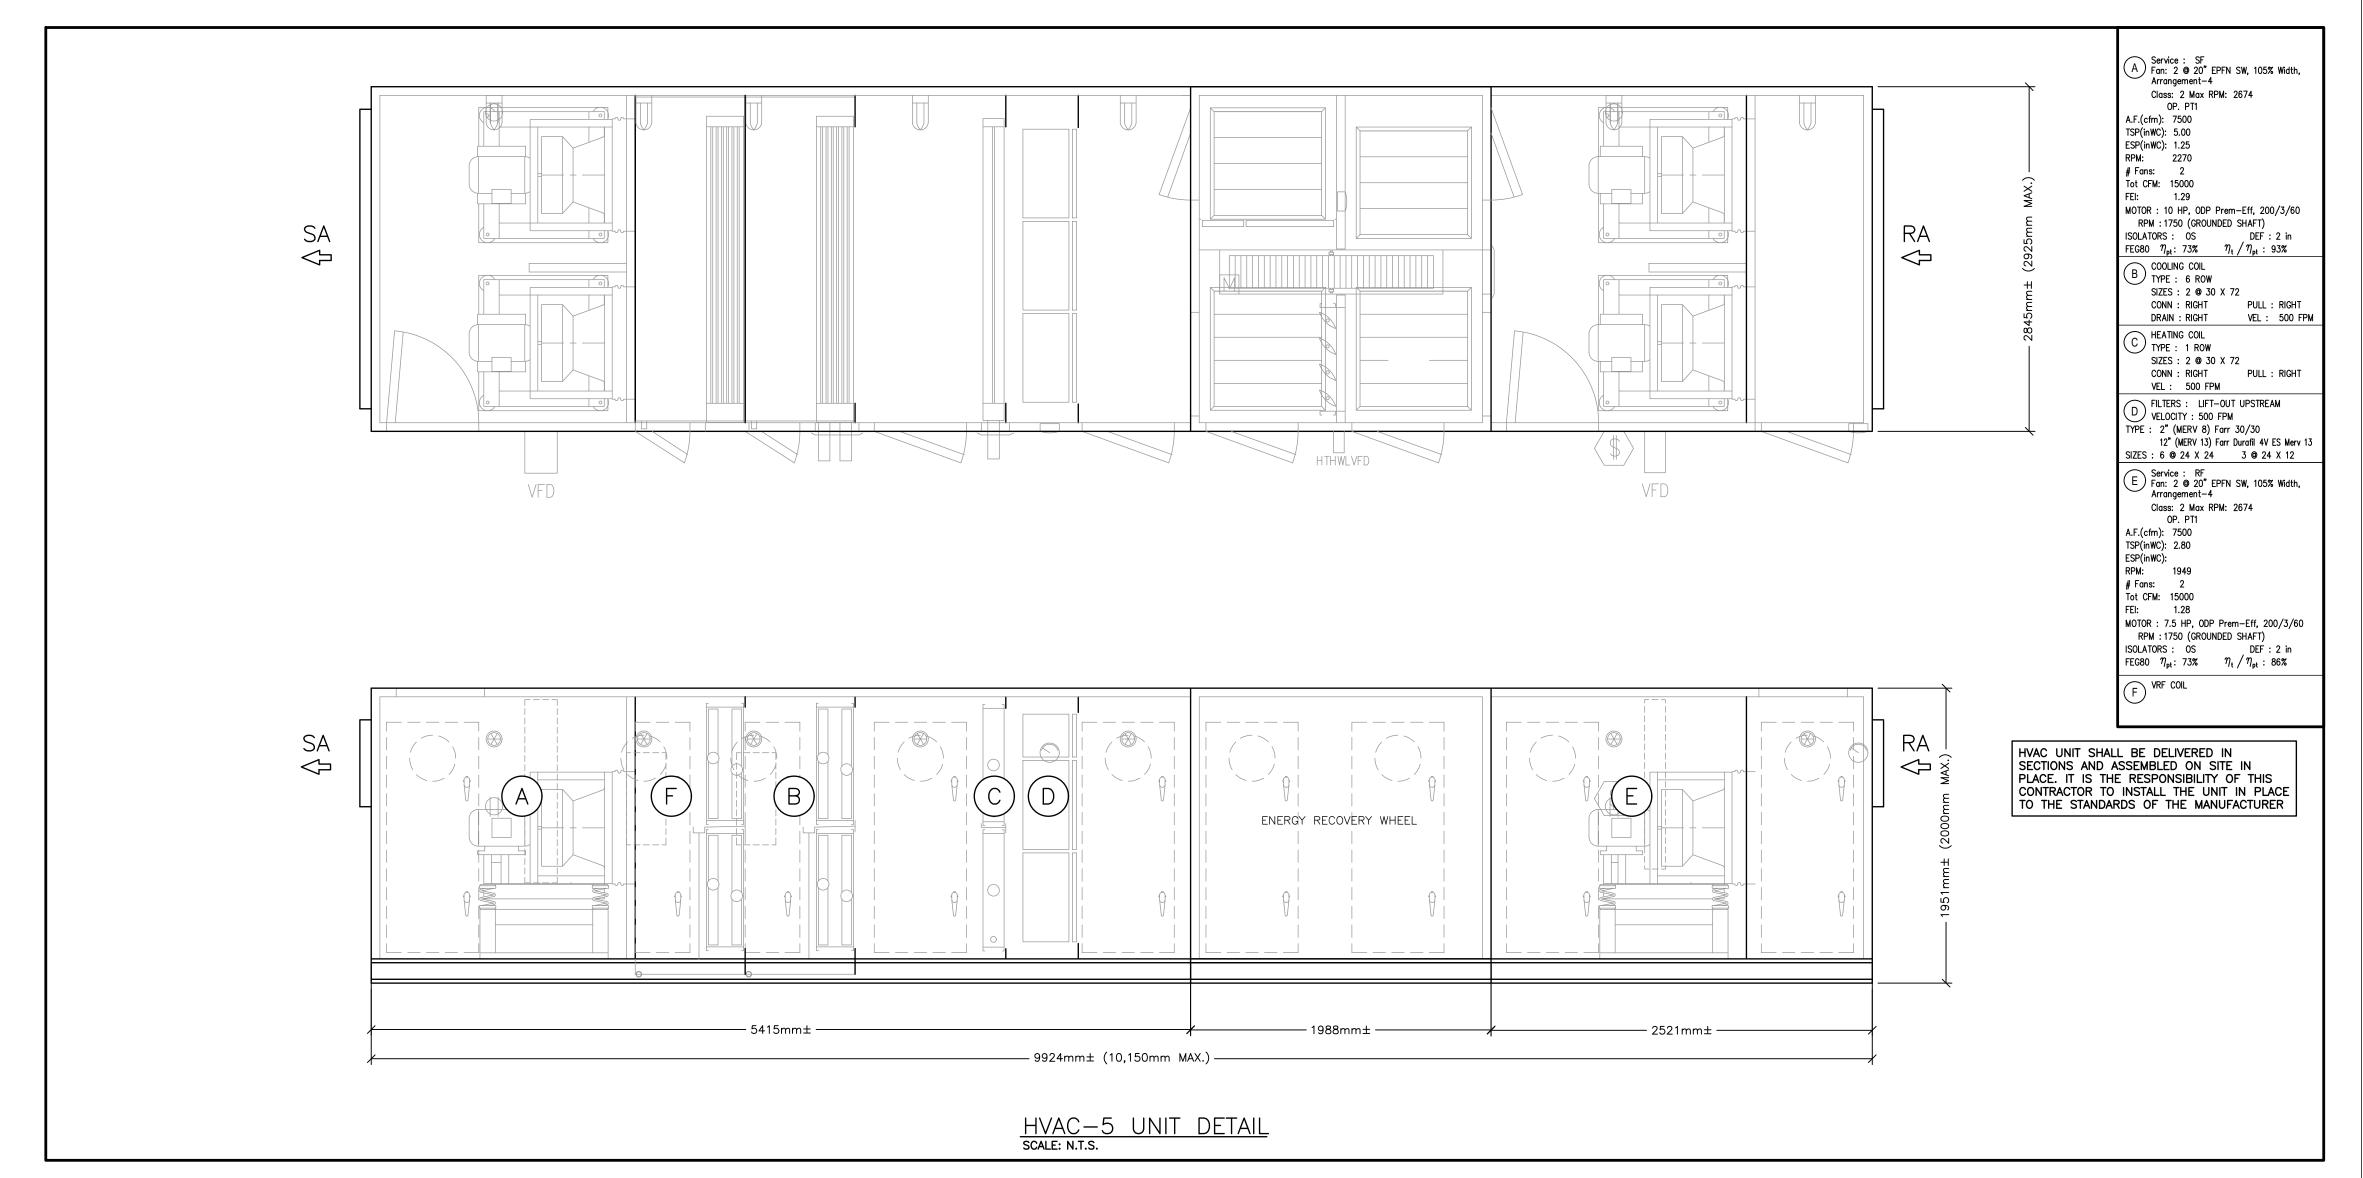
GLENVIEW PARK SECONDARY SCHOOL 55 McKay Street Cambridge, Ontario

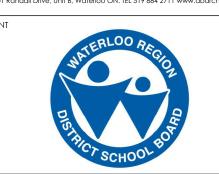KEY PLAN, LEGEND & SCHEDULES

DRAWING NUMBER **AS NOTED** 24x36

M1.1PROJECT NUMBER

PLUI	MBING FIXTU	RE SCH	HEDUI	LE	(PHASE 1)					
	Tuna	Connec	ction Size	s		Fixture		Trim		Accessories
Item	Туре	HW CW TV	W Drain	Vent	Acceptable Manufacturer	Fixture Description	Acceptable Manufacturer	Trim Description	Acceptable Manufacturer	Accessory Description
S-1	STAINLESS STEEL SCIENCE SINK (STUDENT)	15	40	32	KINDRED LBS6407/316-1/3 NOVANNI 1013/316	SINK: SINGLE COMPARTMENT, LEDGE-BACK. FROM 1.0 mm (20 GAUGE) THICK TYPE 316 POLISHED STAINLESS STEEL, SELF-RIMMING, UNDERCOATED, CLAMPS. OVERALL SIZES: 410 mm X 520 mm X 175 mm (18 1/8" X 20 5/8" X 7").	DELTA W660-10 ZURN Z825B1 MOEN COMMERCIAL 8103	FAUCET: CHROME PLATED BRASS, LABORATORY TYPE WITH GOOSENECK SWING SPOUT WITH SERRATED NOZZLE, ANGLE VACUUM BREAKER, AERATOR, INDEXED HOODED LEVER HANDLE, ACCESSORIES TO LIMIT MAXIMUM FLOW RATE TO 3.80 I/min (1.1 gpm) AT 413 kPa (60 psi).		
	BARRIER FREE STAINLESS STEEL SCIENCE SINGLE SINK (STUDENT)	15	40	32	KINDRED LBS6407/316-1/3 NOVANNI 1013/316	SINK: SINGLE COMPARTMENT, LEDGE-BACK. FROM 1.0 mm (20 GAUGE) THICK TYPE 316 POLISHED STAINLESS STEEL, SELF-RIMMING, UNDERCOATED, CLAMPS. OVERALL SIZES: 410 mm X 520 mm X 175 mm (18 1/8" X 20 5/8" X 7").	DELTA W660-10 ZURN Z825B1 MOEN COMMERCIAL 8103	FAUCET: CHROME PLATED BRASS, LABORATORY TYPE WITH GOOSENECK SWING SPOUT WITH SERRATED NOZZLE, ANGLE VACUUM BREAKER, AERATOR, INDEXED HOODED LEVER HANDLE, ACCESSORIES TO LIMIT MAXIMUM FLOW RATE TO 3.80 I/min (1.1 gpm) AT 413 kPa (60 psi).		INSULATION: INSULATE WASTE AND SUPPLIES WITH UL LISTED PREFORMED INSULATION SYSTEM COMPLETE WITH SEAMLESS JACKET. WASTE FITTING: INTEGRAL STAINLESS STEEL BASKET STRAINER/STOPPER, TAILPIECE, CAST BRASS P-TRAP WITH CLEANOUT.
S-3	STAINLESS STEEL SCIENCE SINK (TEACHER)	15 15	40	32	KINDRED LBS6807/316-1/3 NOVANNI 1017/316	SINK: SINGLE COMPARTMENT, LEDGE-BACK. FROM 1.0 mm (20 GAUGE) THICK TYPE 316 POLISHED STAINLESS STEEL, SELF-RIMMING, UNDERCOATED, CLAMPS. OVERALL SIZES: 510 mm X 520 mm X 175 mm (20" X 20 1/2" X 7").	DELTA W6720 ZURN Z826B1-6F MOEN COMMERCIAL 8113	FAUCET: CHROME PLATED BRASS, LABORATORY TYPE WITH GOOSENECK SWING SPOUT WITH SERRATED NOZZLE, VACUUM BREAKER, AERATOR, INDEXED HOODED LEVER HANDLES, ACCESSORIES TO LIMIT MAXIMUM FLOW RATE TO 8.35 I/min (2.2 gpm) AT 413 kPa (60 psi).		
EW-1	EYE WASH	15 15	32	32	HAWS 7260BT-7270BT BRADLEY S19-220 GUARDIAN G1750P-TMV	250 MM (10") DIAMETER IMPACT RESISTANT BOWL CHROME PLATED BRASS SPRAY HEADS COMPLETE WITH COVERS, AND WALL MOUNTING BRACKET. TEPID WATER MIXING VALVE MEETING REQUIREMENTS OF ANSI STANDARD Z358.1-2004. MIXING VALVE IS TO PROVIDE WATER TEMPERATURE BETWEEN 15.5°C (60°) AND 38°C (100°F). 15 MM (1/2") CHROME PLATED BRASS STAY OPEN BALL VALVE COMPLETE WITH PUSH HANDLE.			HAWS TWBS.EWE BRADLEY S19-2000 GUARDIAN G3600	TEMPERING VALVE TO BLEND HOT AND COLD WATER TO DELIVER TEPID WATER. AS REQUIRED BY ANSI Z358.1
G-1	GAS TURRET (DOUBLE) STUDENT				DELTA W6225 ZURN	COUNTER MOUNTED DOUBLE BALL VALVE HOSE COCK 180° PATTERN. VANDAL RESISTANT HANDLE, INDEX BUTTON, O—RING SEAL, SERRATED HOSE, TAILPIECE WITH COUPLING NUT.				
G-2	GAS TURRET (DOUBLE) (TEACHER)				DELTA W6220 ZURN	COUNTER MOUNTED DOUBLE BALL VALVE HOSE COCK 90° PATTERN. VANDAL RESISTANT HANDLE, INDEX BUTTON, O-RING SEAL, SERRATED HOSE, TAILPIECE WITH COUPLING NUT.				
FD-1	ELEVATOR SUMP DRAIN		NOTED		ZURN Z-629 WATTS DRAINAGE MIFAB CONTOUR C2900NB	GENERAL DUTY VERTICAL WALL DRAIN, CAST IRON BODY, CLAMPING COLLAR, NICKEL-BRONZE STRAINER. C/W INTEGRAL BACKWATER VALVE				





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No.	REVISIONS	DATE
1	ISSUED FOR 75% REVIEW	2025.01.31
2	ISSUED FOR PERMIT & TENDER	2025.03.05
3	ISSUED FOR ADDENDUM 1	2025.03.20
4	ISSUED FOR CONSTRUCTION	2025.05.14





CHRONOLOGY	DATE

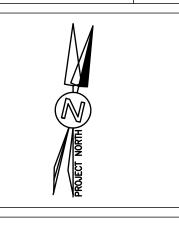

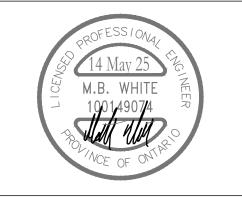

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PROJECT NAME

GLENVIEW PARK
SECONDARY SCHOOL
55 McKay Street Cambridge, Ontario

DRAWING TITLE

SCHEDULES


SCALE DRAWING NUMBER
AS NOTED

SHEET SIZE

24x36

PROJECT NUMBER

M1.2

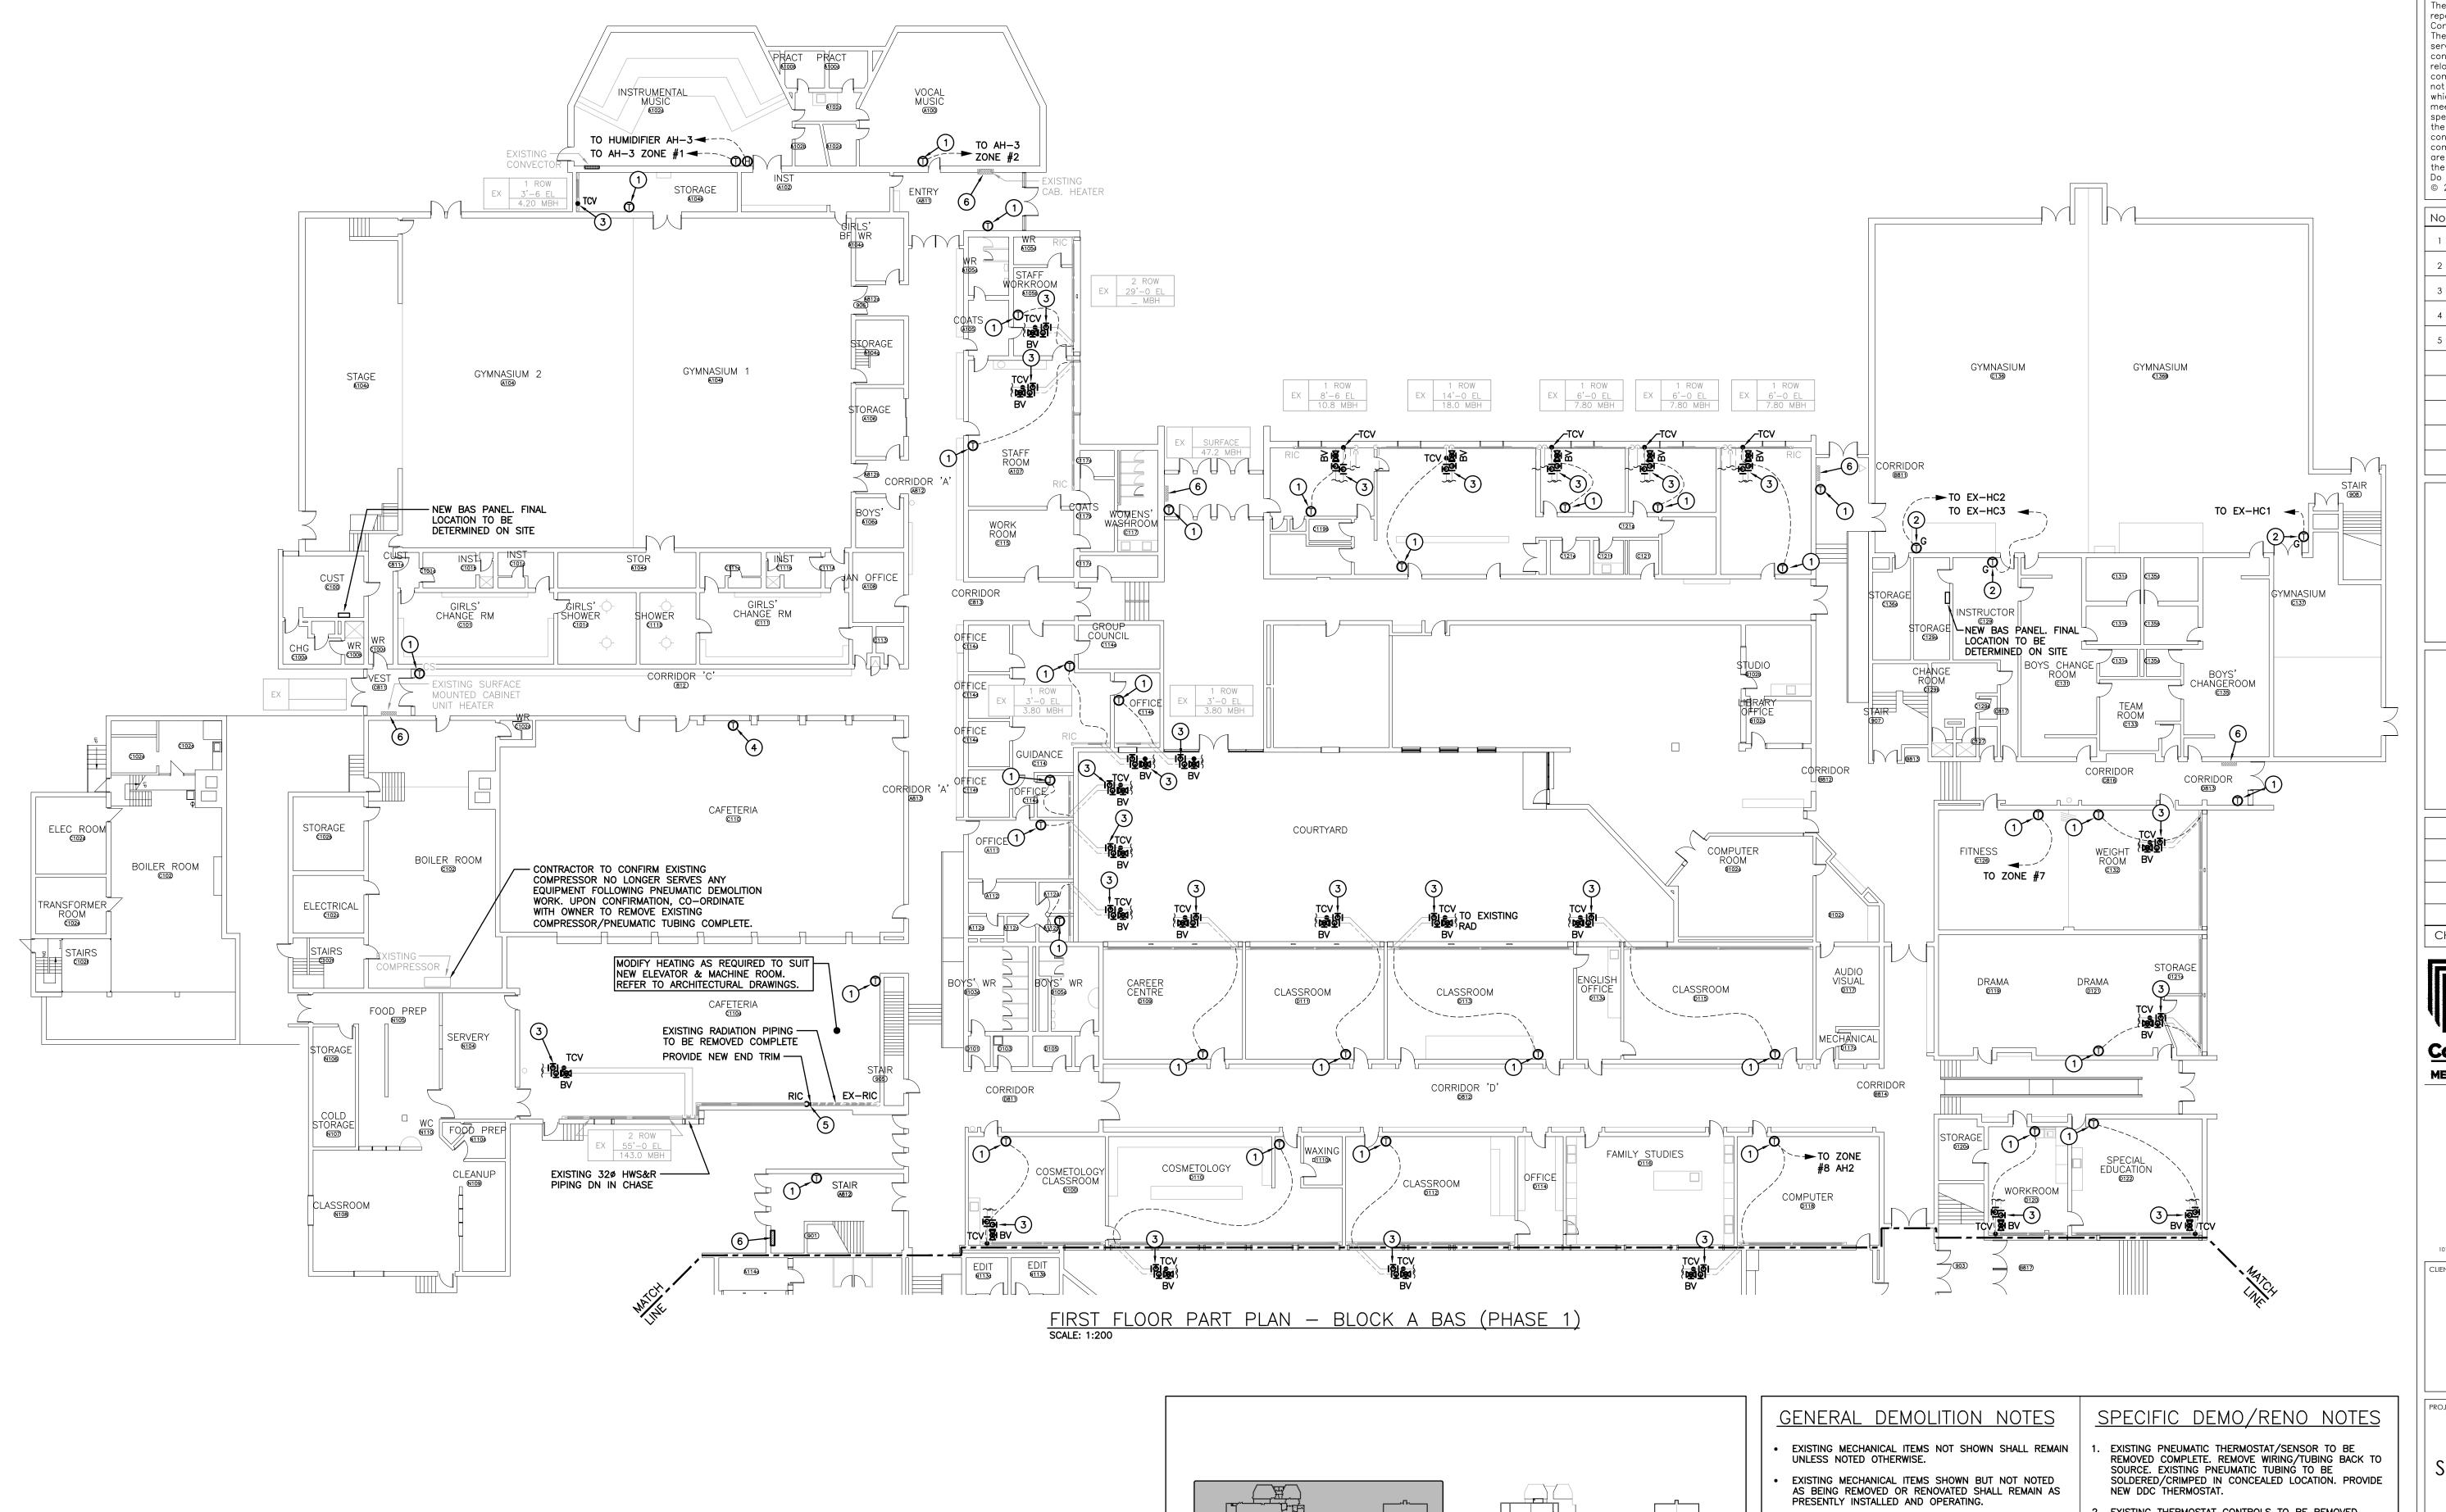


ALL EXISTING PNEUMATIC PIPING/TUBING SHOWN OR OTHERWISE SHALL BE REMOVED COMPLETE WHERE ACCESSIBLE

IDENTIFIED PRICE WORK

WITH CEILINGS OR EXPOSED.

ALL WORK SHOWN TO REPLACE THE EXISTING PNEUMATIC CONTROLS WITH DDC CONTROLS IS AN IDENTIFIED PRICE.

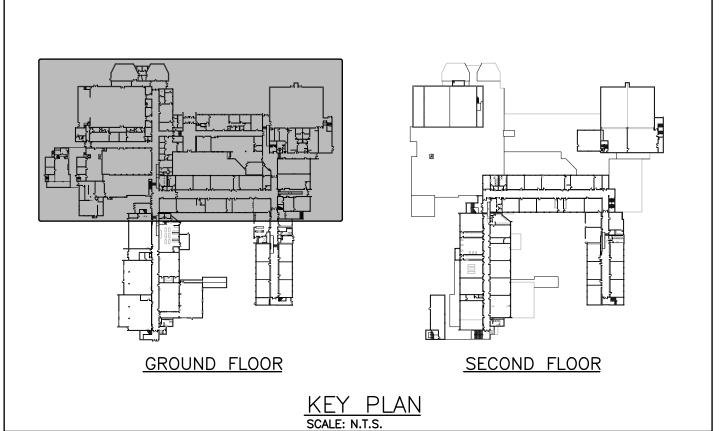


- THIS CONTRACTOR SHALL BE RESPONSIBLE FOR VERIFYING ON SITE ALL LOCATIONS AND SIZES OF ALL SERVICES & EQUIPMENT PRIOR TO THE COMMENCEMENT
- ALL OPENINGS THAT RESULT FROM THE REMOVAL OF
- EQUIPMENT OR SERVICES SHALL BE NEATLY PATCHED WITH SUITABLE NEW MATERIALS TO SUIT EXISTING
- REMOVAL OF EXISTING PIPING, OR DUCT SYSTEMS INCLUDES REMOVAL OF ALL HANGERS, INSULATION, FITTINGS, ETC.
- MAINTAIN INTEGRITY OF EXISTING SYSTEMS THAT ARE TO REMAIN OR BE MODIFIED.
- INSTALL NEW SYSTEM OR SERVICES WHERE REQUIRED TO MAINTAIN SYSTEM OPERATION PRIOR TO DEMOLITION OF EXISTING SERVICES.
- THIS CONTRACTOR IS TO REMOVE & REPLACE CEILINGS AS REQUIRED FOR REMOVAL/REPLACEMENT OF
- EXISTING THERMOSTAT CONTROLS TO BE REMOVED COMPLETE & REPLACED WITH NEW DDC CONTROLS (PLATE SENSOR) TO CONTROL NEW TCV IN MECH ROOM. NEW TCV TO BE SUPPLIED BY BAS CONTRACTOR AND INSTALLED BY MECHANICAL
- . EXISTING TCV, ISOLATION, & BALANCING VALVES TO BE REMOVED AND REPLACED WITH NEW. SIZE TO MATCH
- EXISTING PNEUMATIC CONTROL VALVE(S) TO BE REMOVED FROM BOOSTER COIL(S) & REPLACED W/
 NEW DDC CONTROL VALVE(S). NEW TCV(S) TO BE SUPPLIED BY BAS CONTRACTOR AND INSTALLED BY MECHANICAL CONTRACTOR.
- 5. EXISTING RADIATION CABINET, PIPING & WALLFIN TO BE CUT & REMOVED BEYOND COMPLETE. PROVIDE NEW END TRIM TO MATCH EXISTING CABINET HEIGHT.
- EXISTING STANDALONE CONTROL TO BE REMOVED COMPLETE. INTEGRATE EXISTING INTO NEW DDC BAS


The contractor shall verify all dimensions and report all errors and discrepancies to the Consultant before commencement of the work. The drawings show general arrangement of services. Follow as closely as actual building construction will permit. Obtain approval for relocation of service from Consultant before commencement of the work. The drawings do not indicate all offsets fitting and accessories which may be required. Provide the same to meet the required conditions. Drawings and specifications, etc., prepared and issued by the consultant are the property of the consultant and must be returned at the consultant and must be returned at the completion of the project. These documents are not to be duplicated or copied without the consent of the Consultant.


Do not scale this drawing.

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No.	REVISIONS	DATE
110.	REVISIONS	DATE
1	ISSUED FOR 75% REVIEW	2025.01.31
2	ISSUED FOR PERMIT & TENDER	2025.03.05
3	ISSUED FOR ADDENDUM 1	2025.03.20
4	ISSUED FOR ADDENDUM 2	2025.03.24
5	ISSUED FOR CONSTRUCTION	2025.05.14



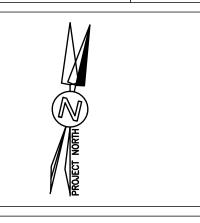

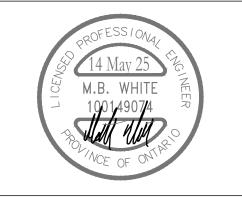

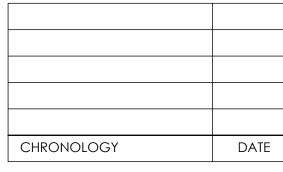



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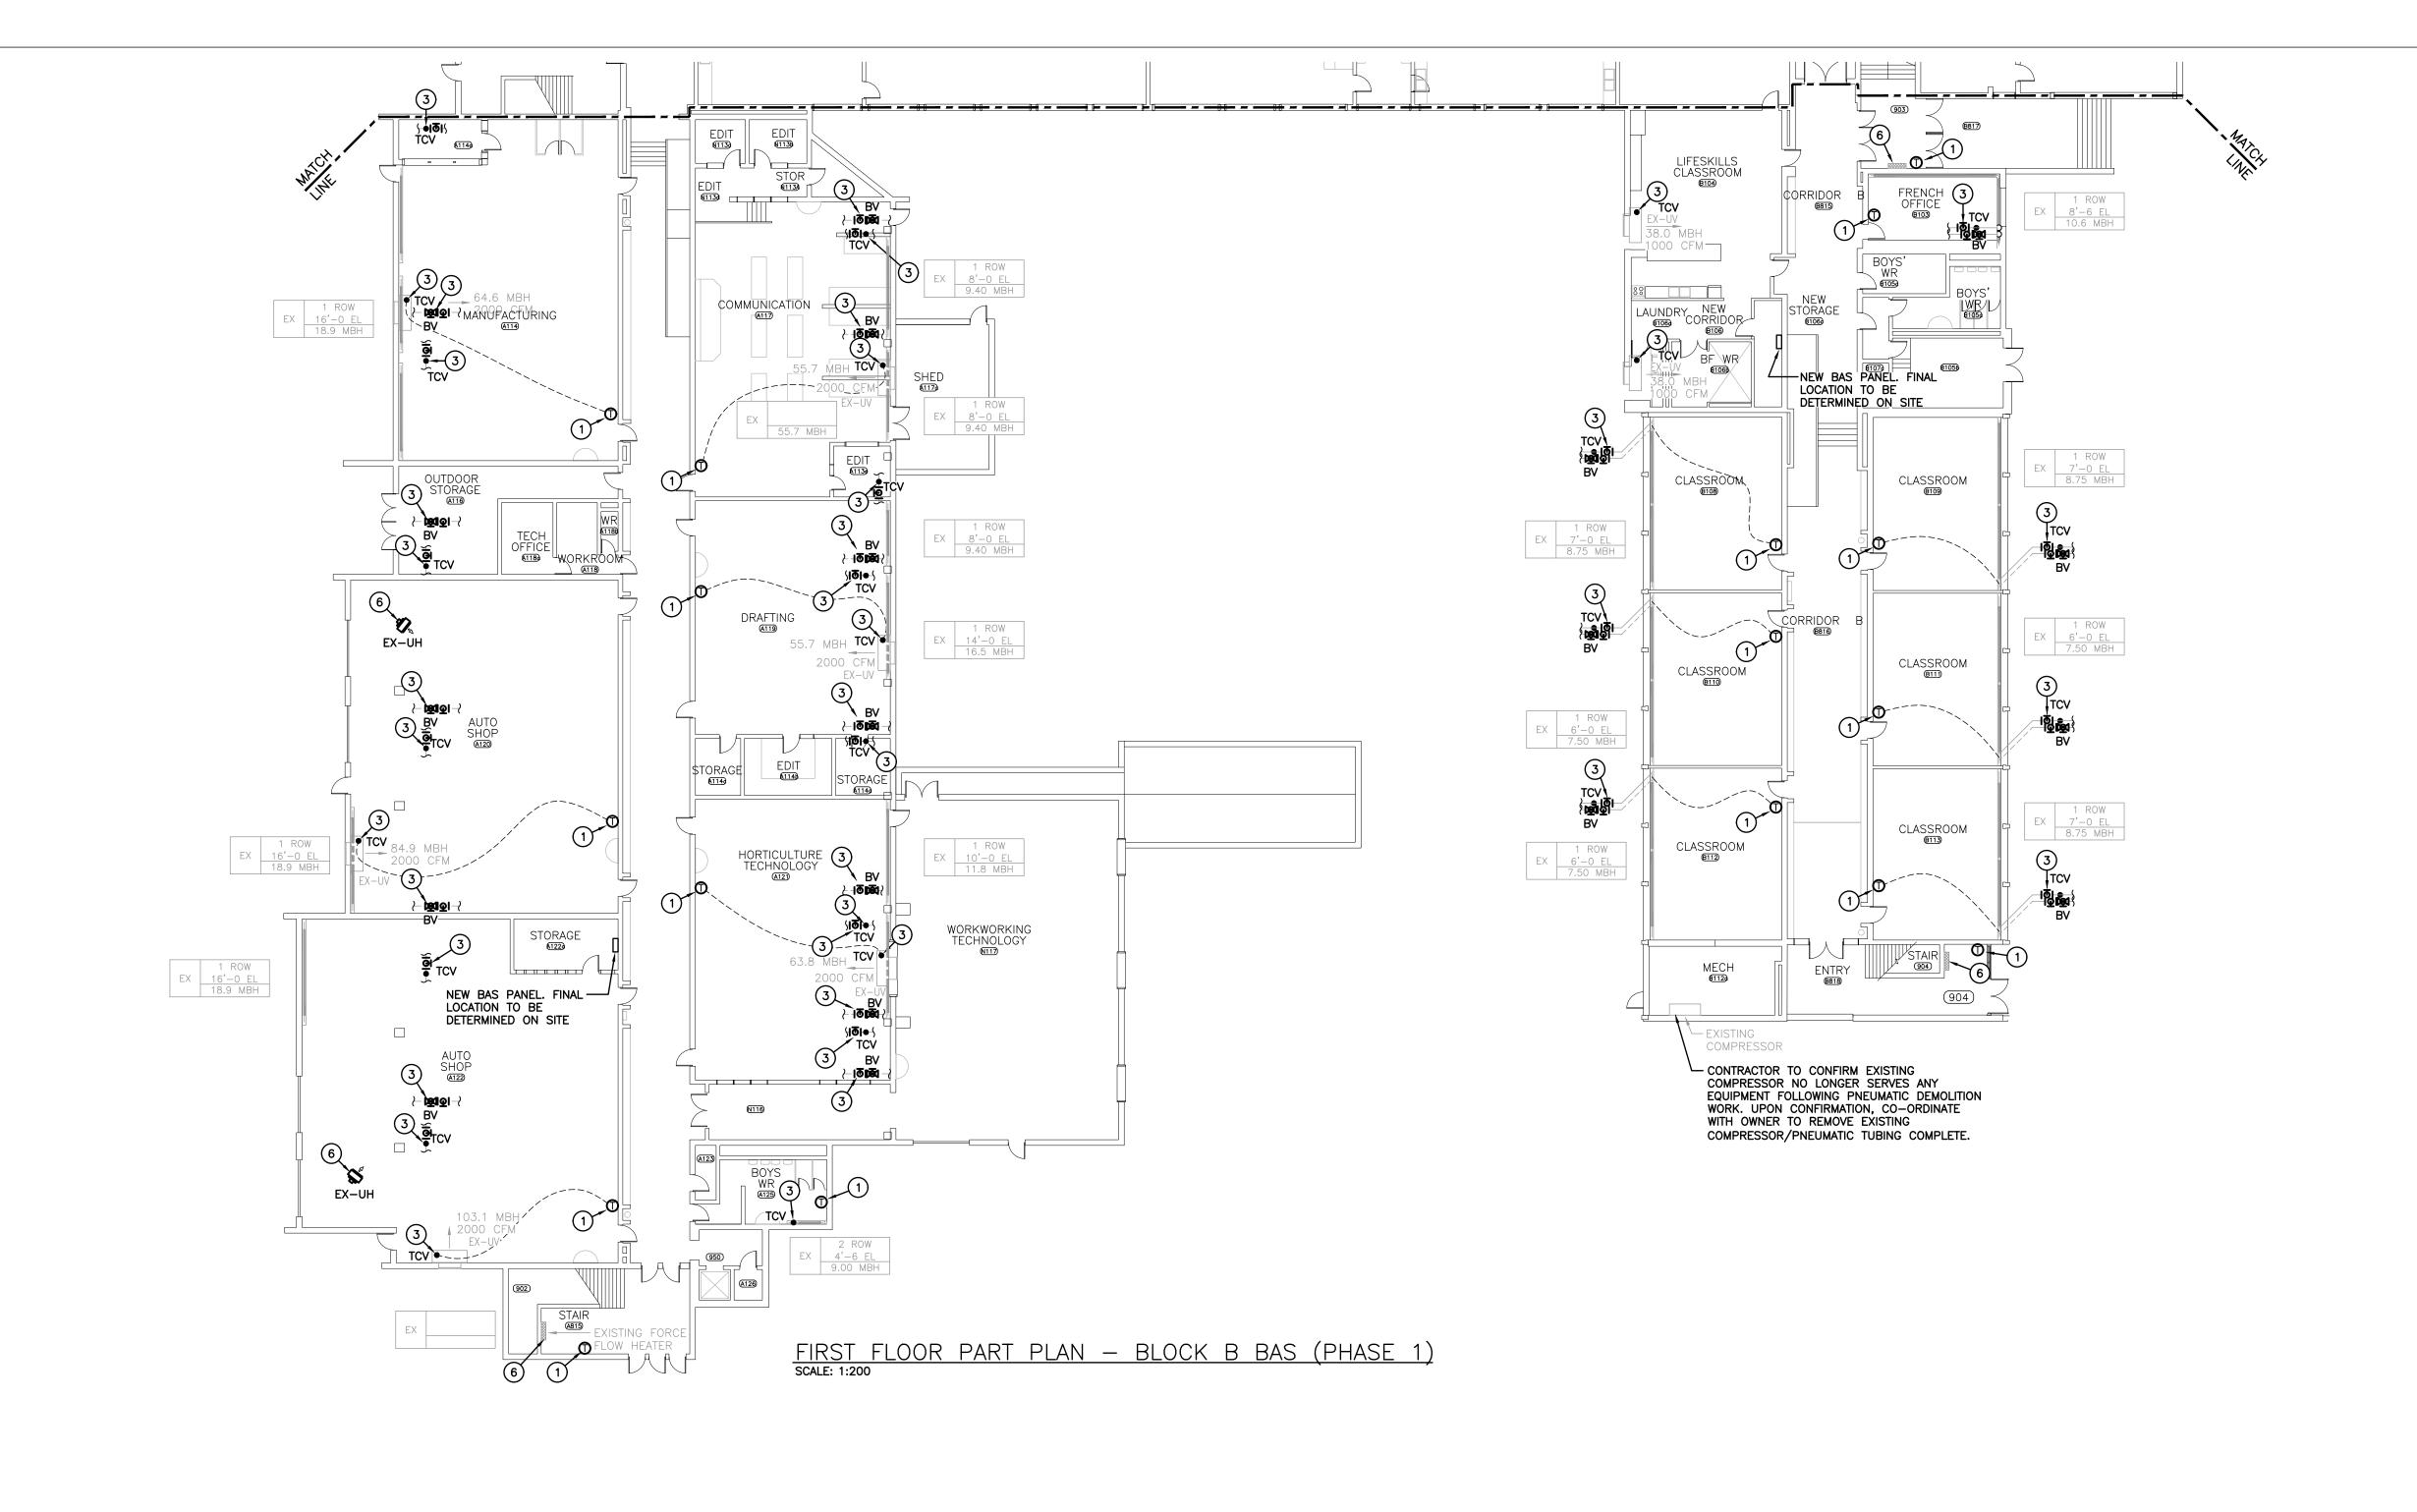
DRAWING TITLE

FIRST FLOOR PART PLAN - BLOCK A BAS (PHASE 1)

DRAWING NUMBER AS NOTED

24x36

M2.1PROJECT NUMBER





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No.	REVISIONS	DATE
1	ISSUED FOR 75% REVIEW	2025.01.31
2	ISSUED FOR PERMIT & TENDER	2025.03.05
3	ISSUED FOR ADDENDUM 1	2025.03.20
4	ISSUED FOR ADDENDUM 2	2025.03.24
5	ISSUED FOR CONSTRUCTION	2025.05.14
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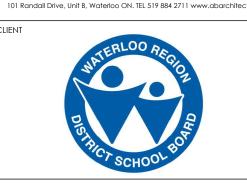
CHRONOLOGY	DATE



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GLENVIEW PARK SECONDARY SCHOOL 55 McKay Street Cambridge, Ontario

DRAWING TITLE

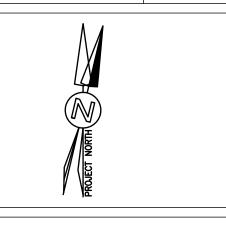FIRST FLOOR PART PLAN - BLOCK B BAS (PHASE 1)

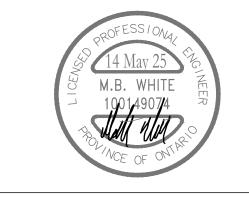AS NOTED

PROJECT NUMBER

DRAWING NUMBER

24x36

EXISTING MECHANICAL ITEMS NOT SHOWN SHALL REMAIN UNLESS NOTED OTHERWISE.

EXISTING MECHANICAL ITEMS SHOWN BUT NOT NOTED AS BEING REMOVED OR RENOVATED SHALL REMAIN AS PRESENTLY INSTALLED AND OPERATING.

THIS CONTRACTOR SHALL BE RESPONSIBLE FOR VERIFYING ON SITE ALL LOCATIONS AND SIZES OF ALL SERVICES & EQUIPMENT PRIOR TO THE COMMENCEMENT

ALL OPENINGS THAT RESULT FROM THE REMOVAL OF EQUIPMENT OR SERVICES SHALL BE NEATLY PATCHED WITH SUITABLE NEW MATERIALS TO SUIT EXISTING

REMOVAL OF EXISTING PIPING, OR DUCT SYSTEMS INCLUDES REMOVAL OF ALL HANGERS, INSULATION, FITTINGS, ETC.

REMAIN OR BE MODIFIED.

INSTALL NEW SYSTEM OR SERVICES WHERE REQUIRED TO MAINTAIN SYSTEM OPERATION PRIOR TO DEMOLITION OF EXISTING SERVICES.

THIS CONTRACTOR IS TO REMOVE & REPLACE CEILINGS AS REQUIRED FOR REMOVAL/REPLACEMENT OF

GENERAL DEMOLITION NOTES

MAINTAIN INTEGRITY OF EXISTING SYSTEMS THAT ARE TO

CUT & REMOVED BEYOND COMPLETE. PROVIDE NEW END TRIM TO MATCH EXISTING CABINET HEIGHT. . EXISTING STANDALONE CONTROL TO BE REMOVED COMPLETE. INTEGRATE EXISTING INTO NEW DDC BAS

MECHANICAL CONTRACTOR.

NEW DDC THERMOSTAT.

SPECIFIC DEMO/RENO NOTES

EXISTING PNEUMATIC THERMOSTAT/SENSOR TO BE REMOVED COMPLETE. REMOVE WIRING/TUBING BACK TO

EXISTING THERMOSTAT CONTROLS TO BE REMOVED

COMPLETE & REPLACED WITH NEW DDC CONTROLS

(PLATE SENSOR) TO CONTROL NEW TCV IN MECH ROOM. NEW TCV TO BE SUPPLIED BY BAS

. EXISTING TCV, ISOLATION, & BALANCING VALVES TO BE REMOVED AND REPLACED WITH NEW. SIZE TO MATCH

REMOVED FROM BOOSTER COIL(S) & REPLACED W/ NEW DDC CONTROL VALVE(S). NEW TCV(S) TO BE

SUPPLIED BY BAS CONTRACTOR AND INSTALLED BY

5. EXISTING RADIATION CABINET, PIPING & WALLFIN TO BE

CONTRACTOR AND INSTALLED BY MECHANICAL

. EXISTING PNEUMATIC CONTROL VALVE(S) TO BE

SOLDERED/CRIMPED IN CONCEALED LOCATION. PROVIDE

SOURCE. EXISTING PNEUMATIC TUBING TO BE

WITH CEILINGS OR EXPOSED. IDENTIFIED PRICE WORK

ALL WORK SHOWN TO REPLACE THE


EXISTING PNEUMATIC CONTROLS WITH


DDC CONTROLS IS AN IDENTIFIED PRICE.

ALL EXISTING PNEUMATIC PIPING/TUBING

REMOVED COMPLETE WHERE ACCESSIBLE

SHOWN OR OTHERWISE SHALL BE

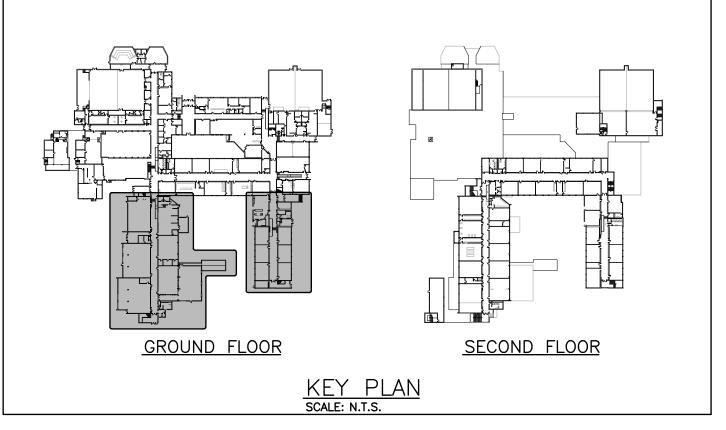

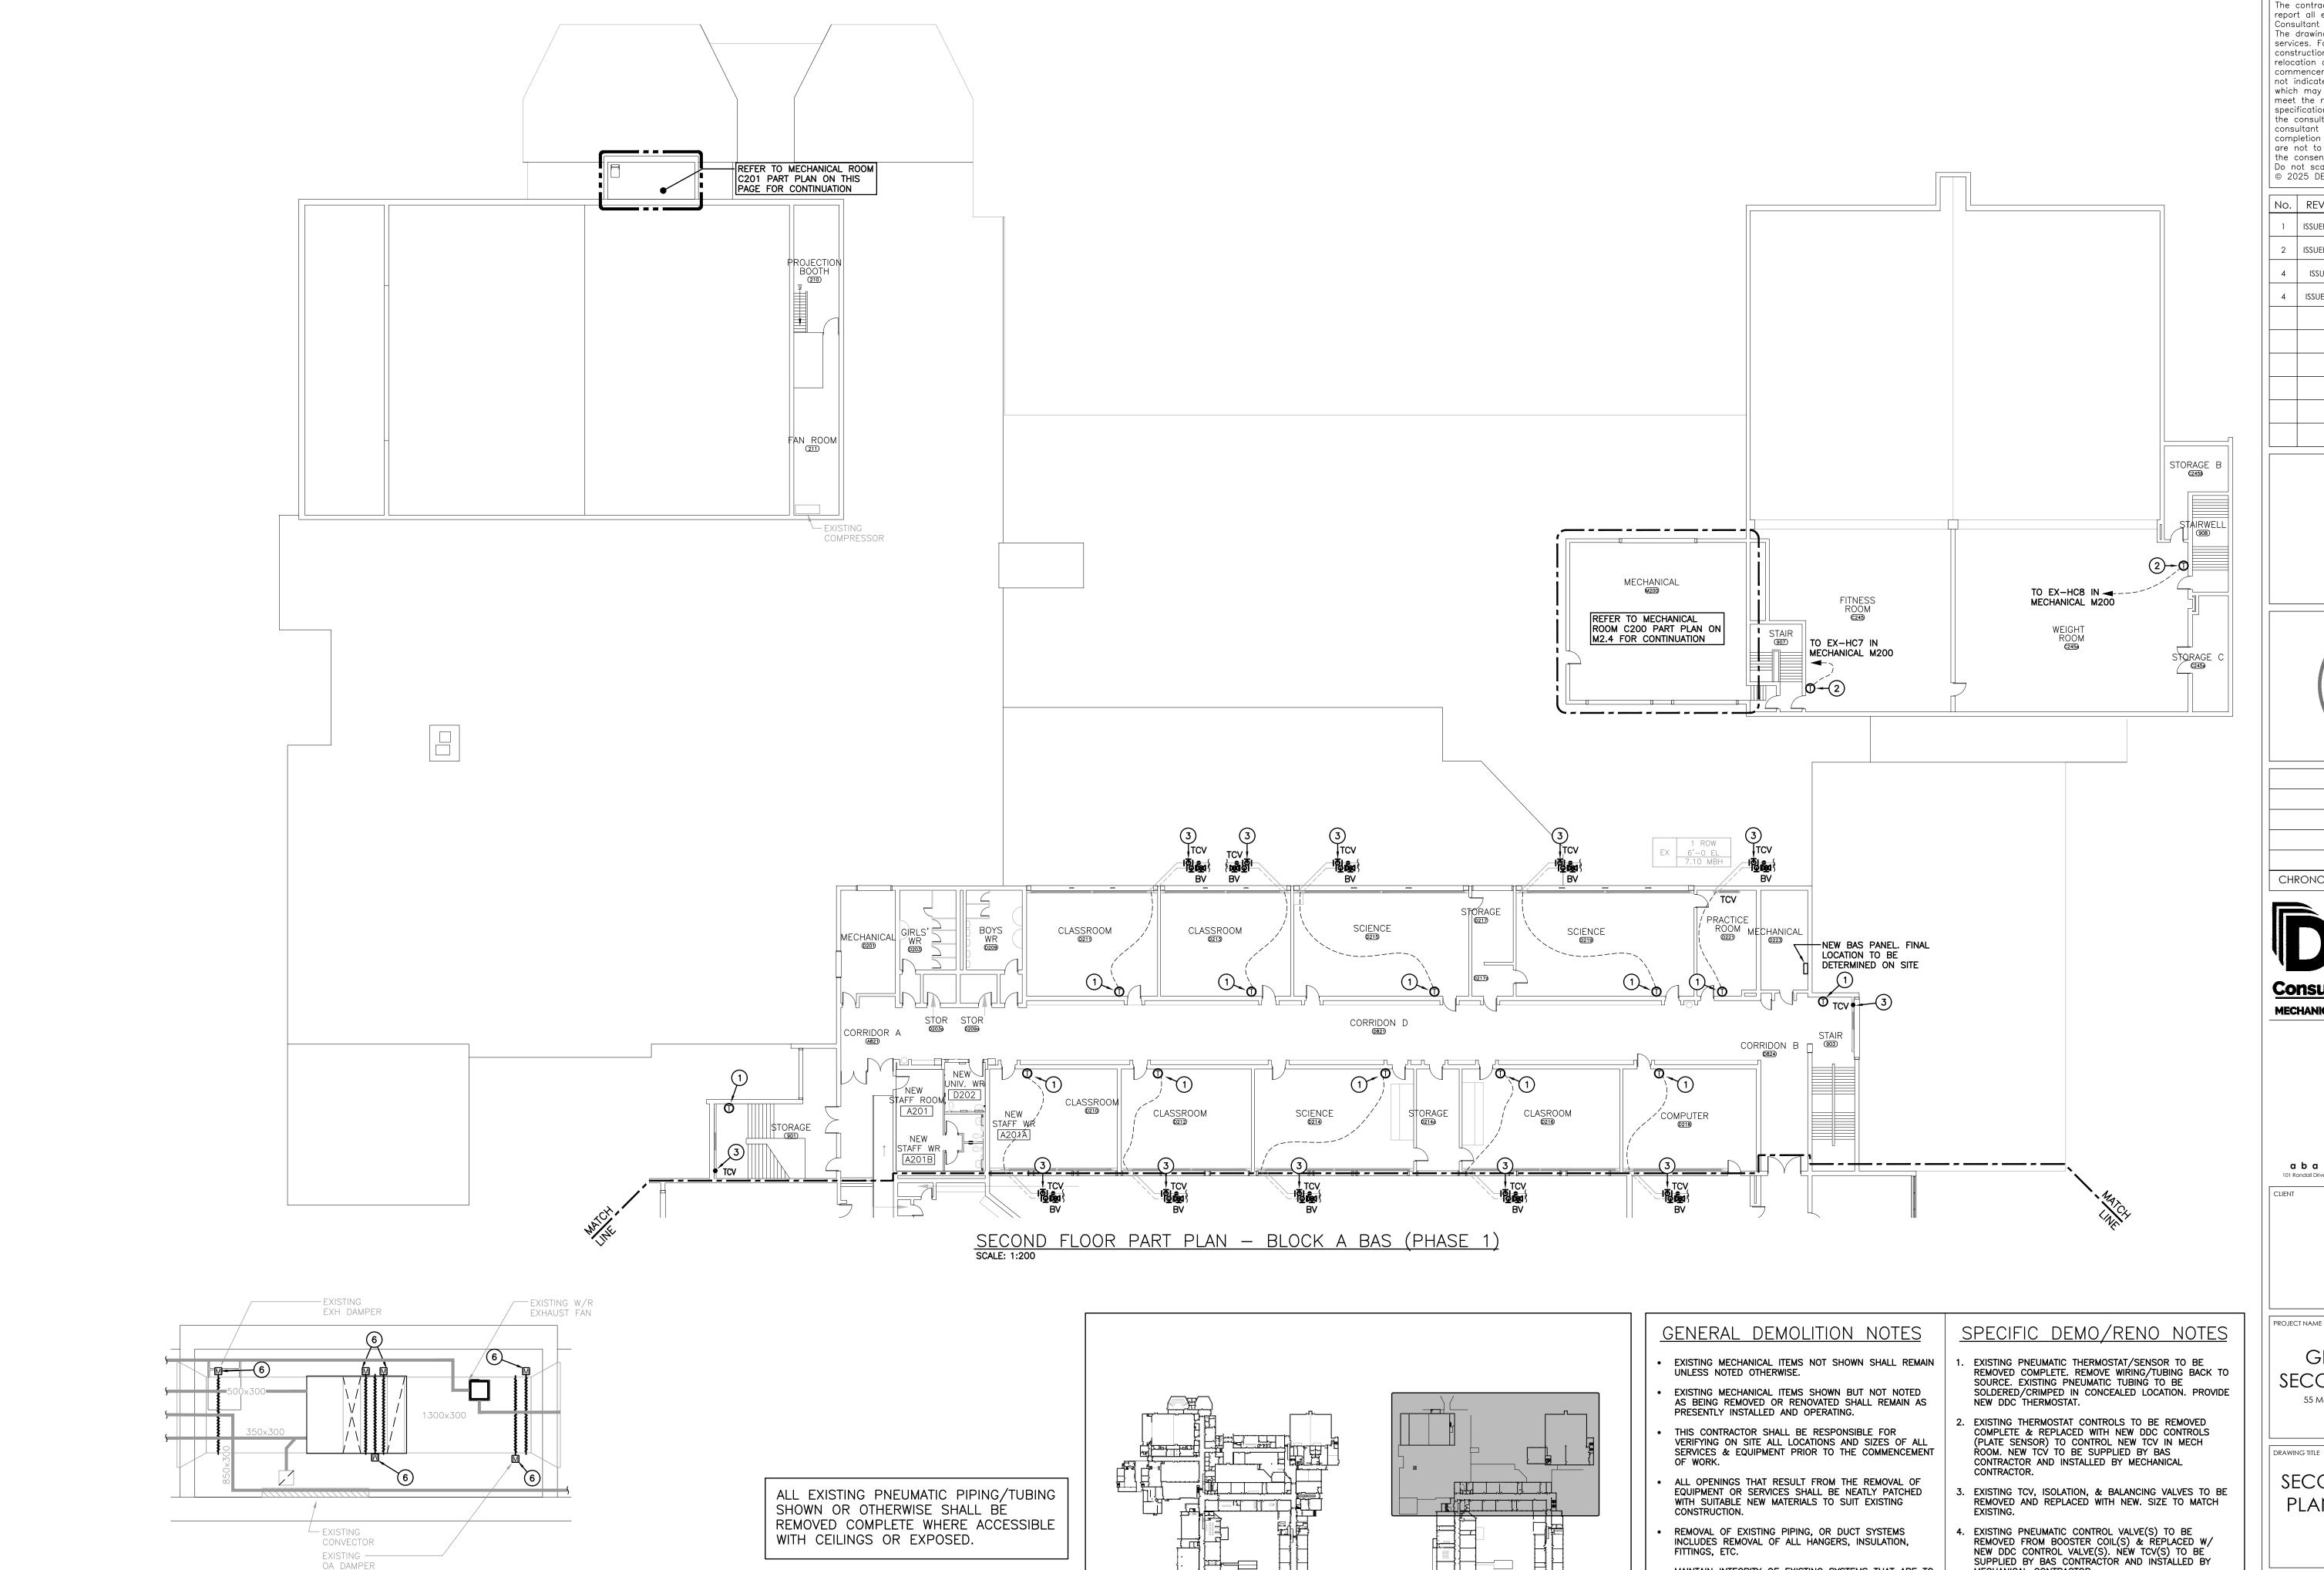

GROUND FLOOR

KEY PLAN SCALE: N.T.S.

SECOND FLOOR

IDENTIFIED PRICE WORK

ALL WORK SHOWN TO REPLACE THE

EXISTING PNEUMATIC CONTROLS WITH


DDC CONTROLS IS AN IDENTIFIED PRICE.


MECHANICAL ROOM C201 PART PLAN (PHASE 1)
SCALE: 1:50

The contractor shall verify all dimensions and report all errors and discrepancies to the Consultant before commencement of the work. The drawings show general arrangement of services. Follow as closely as actual building construction will permit. Obtain approval for relocation of service from Consultant before commencement of the work. The drawings do not indicate all offsets fitting and accessories which may be required. Provide the same to meet the required conditions. Drawings and specifications, etc., prepared and issued by the consultant are the property of the consultant and must be returned at the constitute that must be returned at the completion of the project. These documents are not to be duplicated or copied without the consent of the Consultant.

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No.	REVISIONS	DATE
1	ISSUED FOR 75% REVIEW	2025.01.31
2	ISSUED FOR PERMIT & TENDER	2025.03.05
4	ISSUED FOR ADDENDUM 2	2025.03.24
4	ISSUED FOR CONSTRUCTION	2025.05.14




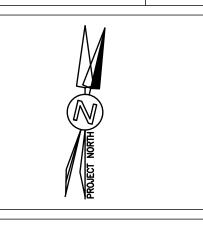

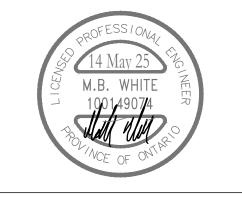
CHRONOLOGY	DATE



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GLENVIEW PARK SECONDARY SCHOOL 55 McKay Street Cambridge, Ontario

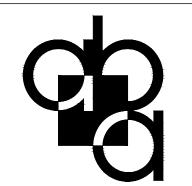PROJECT NUMBER

SECOND FLOOR PART PLAN - BLOCK A BAS (PHASE 1)

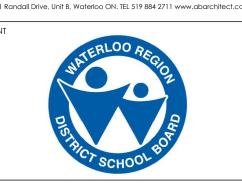DRAWING NUMBER **AS NOTED**

M2.324x36

- MAINTAIN INTEGRITY OF EXISTING SYSTEMS THAT ARE TO
- REMAIN OR BE MODIFIED. INSTALL NEW SYSTEM OR SERVICES WHERE REQUIRED TO MAINTAIN SYSTEM OPERATION PRIOR TO DEMOLITION

MECHANICAL CONTRACTOR.


5. EXISTING RADIATION CABINET, PIPING & WALLFIN TO BE

CUT & REMOVED BEYOND COMPLETE. PROVIDE NEW END TRIM TO MATCH EXISTING CABINET HEIGHT.

. EXISTING PNEUMATIC MOTORIZED DAMPER ACTUATOR TO

BE REMOVED COMPLETE. PROVIDE NEW DDC ACTUATOR.

OF EXISTING SERVICES. THIS CONTRACTOR IS TO REMOVE & REPLACE CEILINGS AS REQUIRED FOR REMOVAL/REPLACEMENT OF

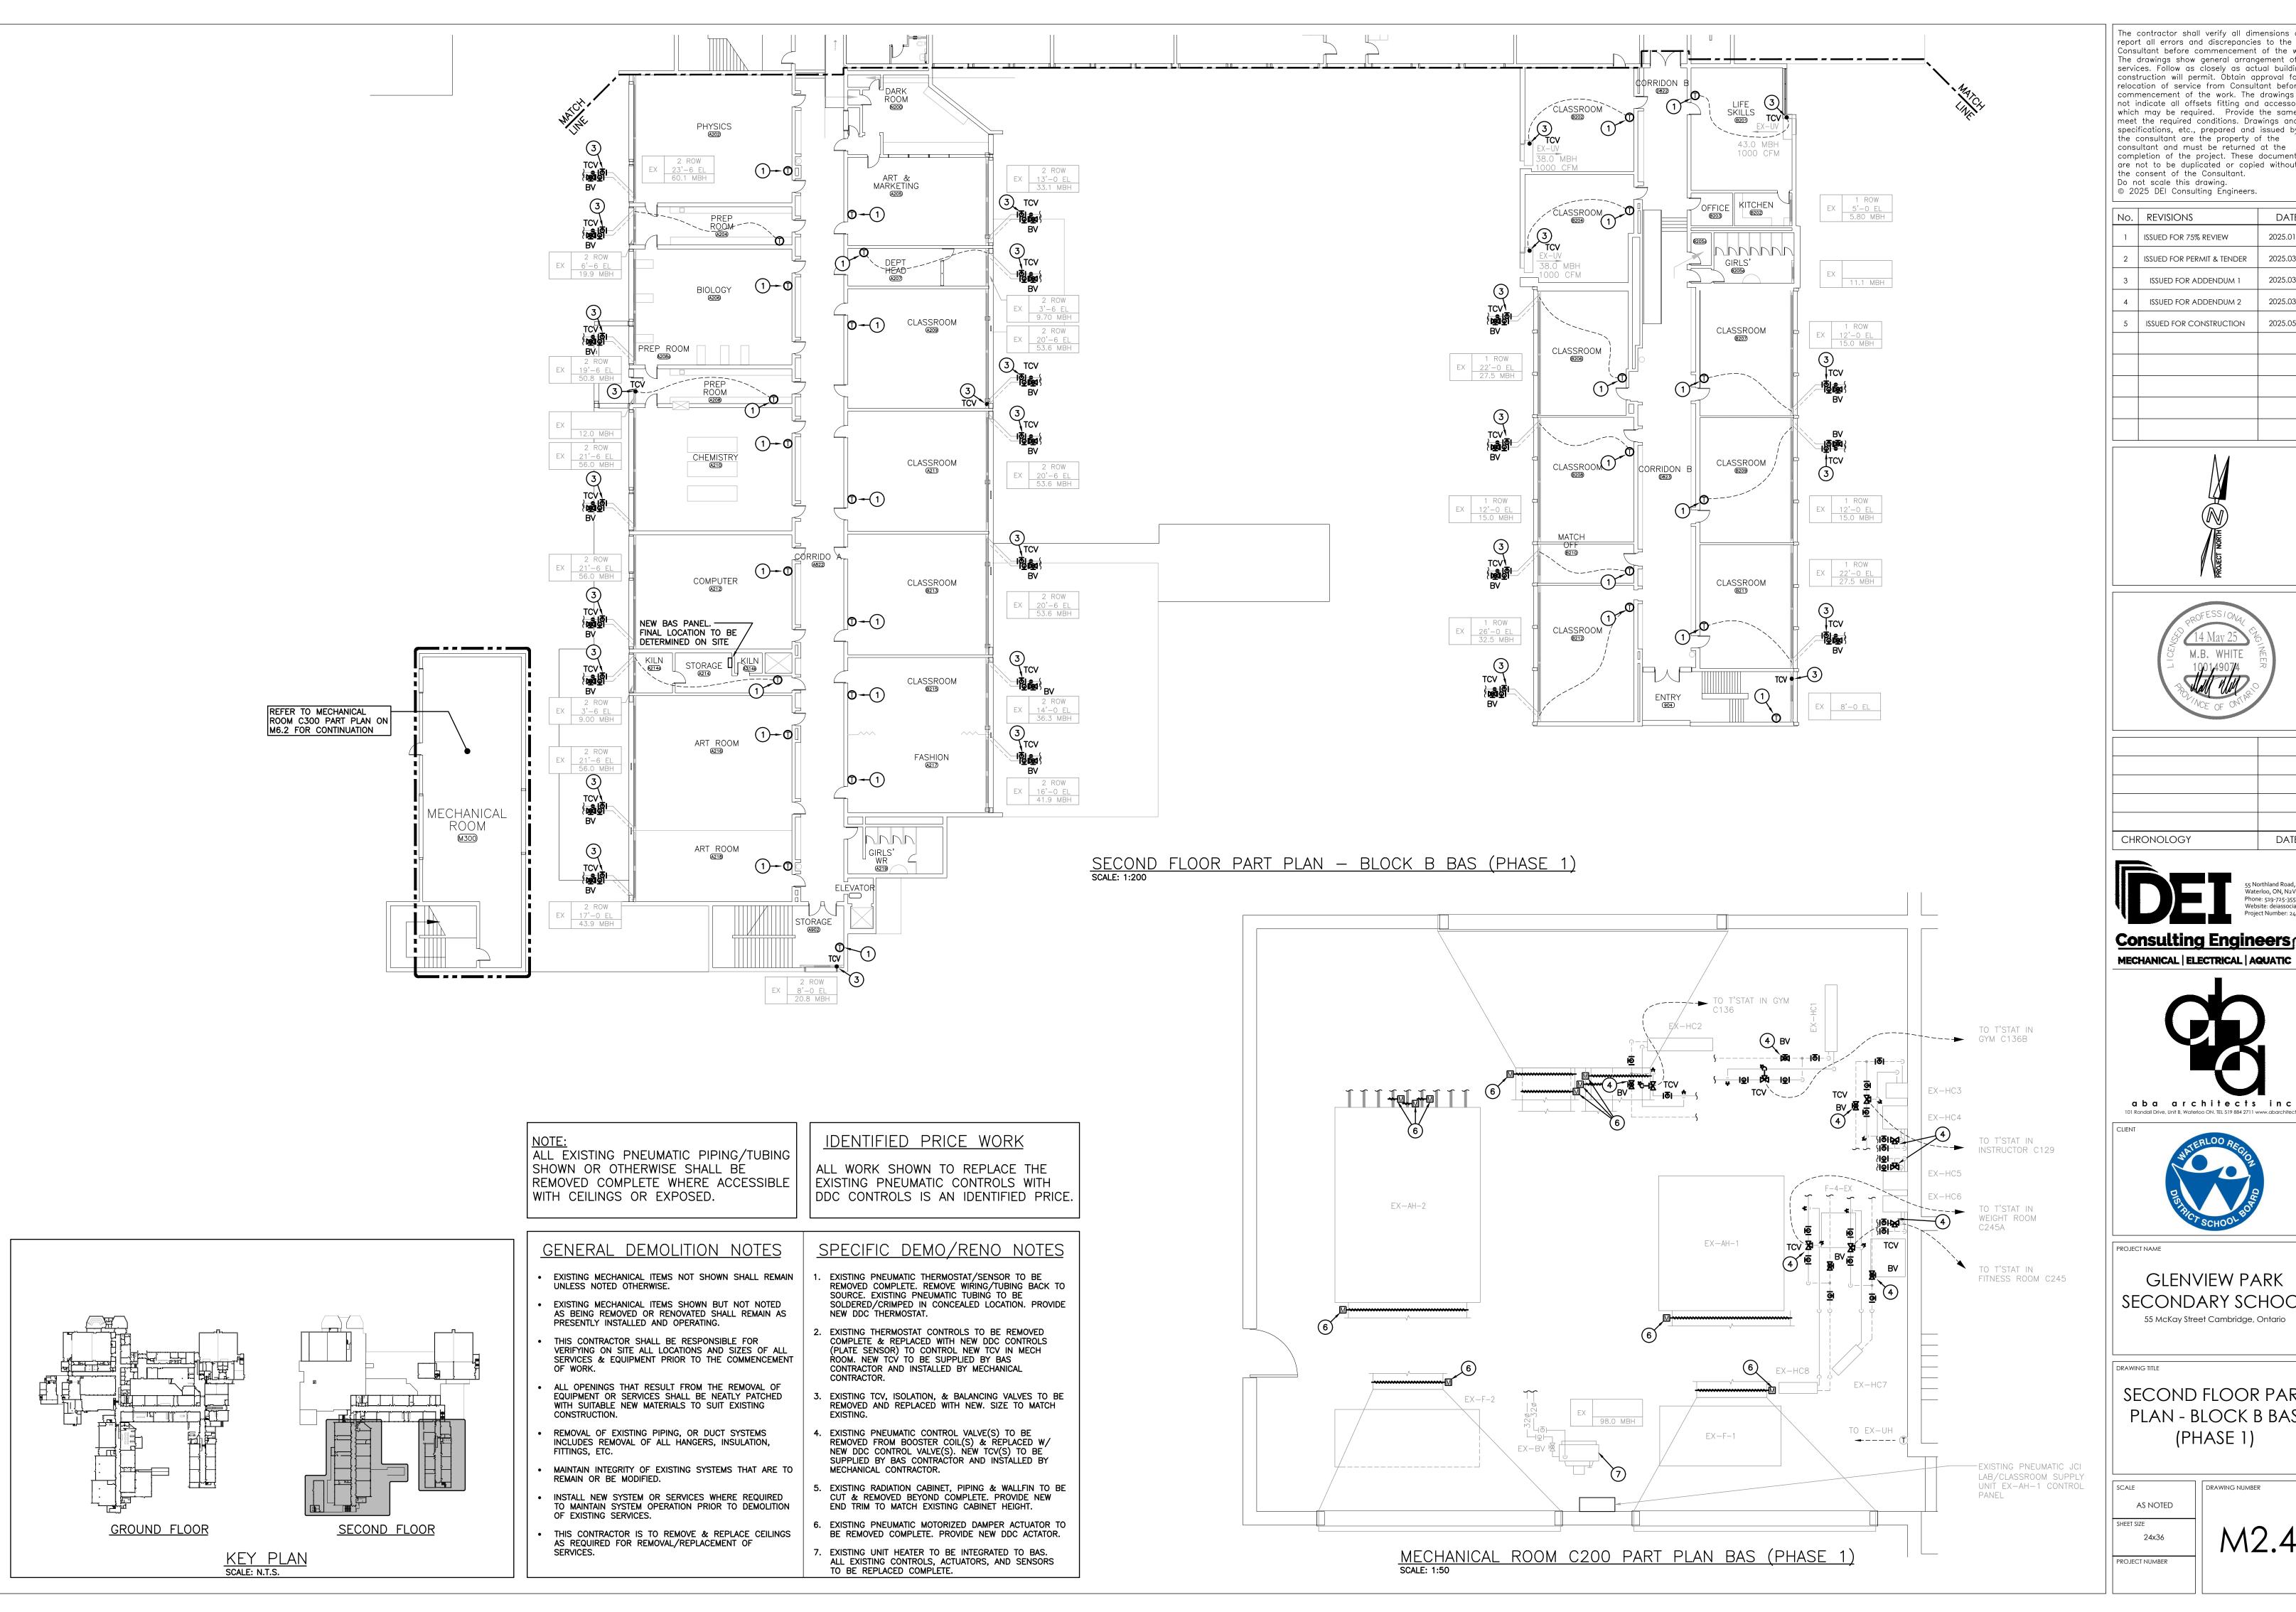



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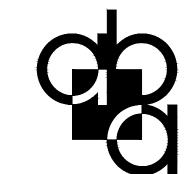
No.	revisions	DATE
1	ISSUED FOR 75% REVIEW	2025.01.3
2	ISSUED FOR PERMIT & TENDER	2025.03.0
3	ISSUED FOR ADDENDUM 1	2025.03.20
4	ISSUED FOR ADDENDUM 2	2025.03.24
5	issued for construction	2025.05.14





CHRONOLOGY	DATE

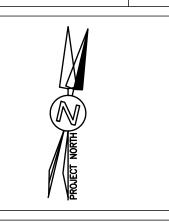

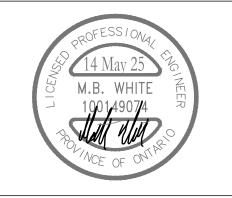

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PROJECT NAME


GLENVIEW PARK SECONDARY SCHOOL 55 McKay Street Cambridge, Ontario

DRAWING TITLE

SECOND FLOOR PART PLAN - BLOCK B BAS (PHASE 1)

AS NOTED M2.424x36

DRAWING NUMBER

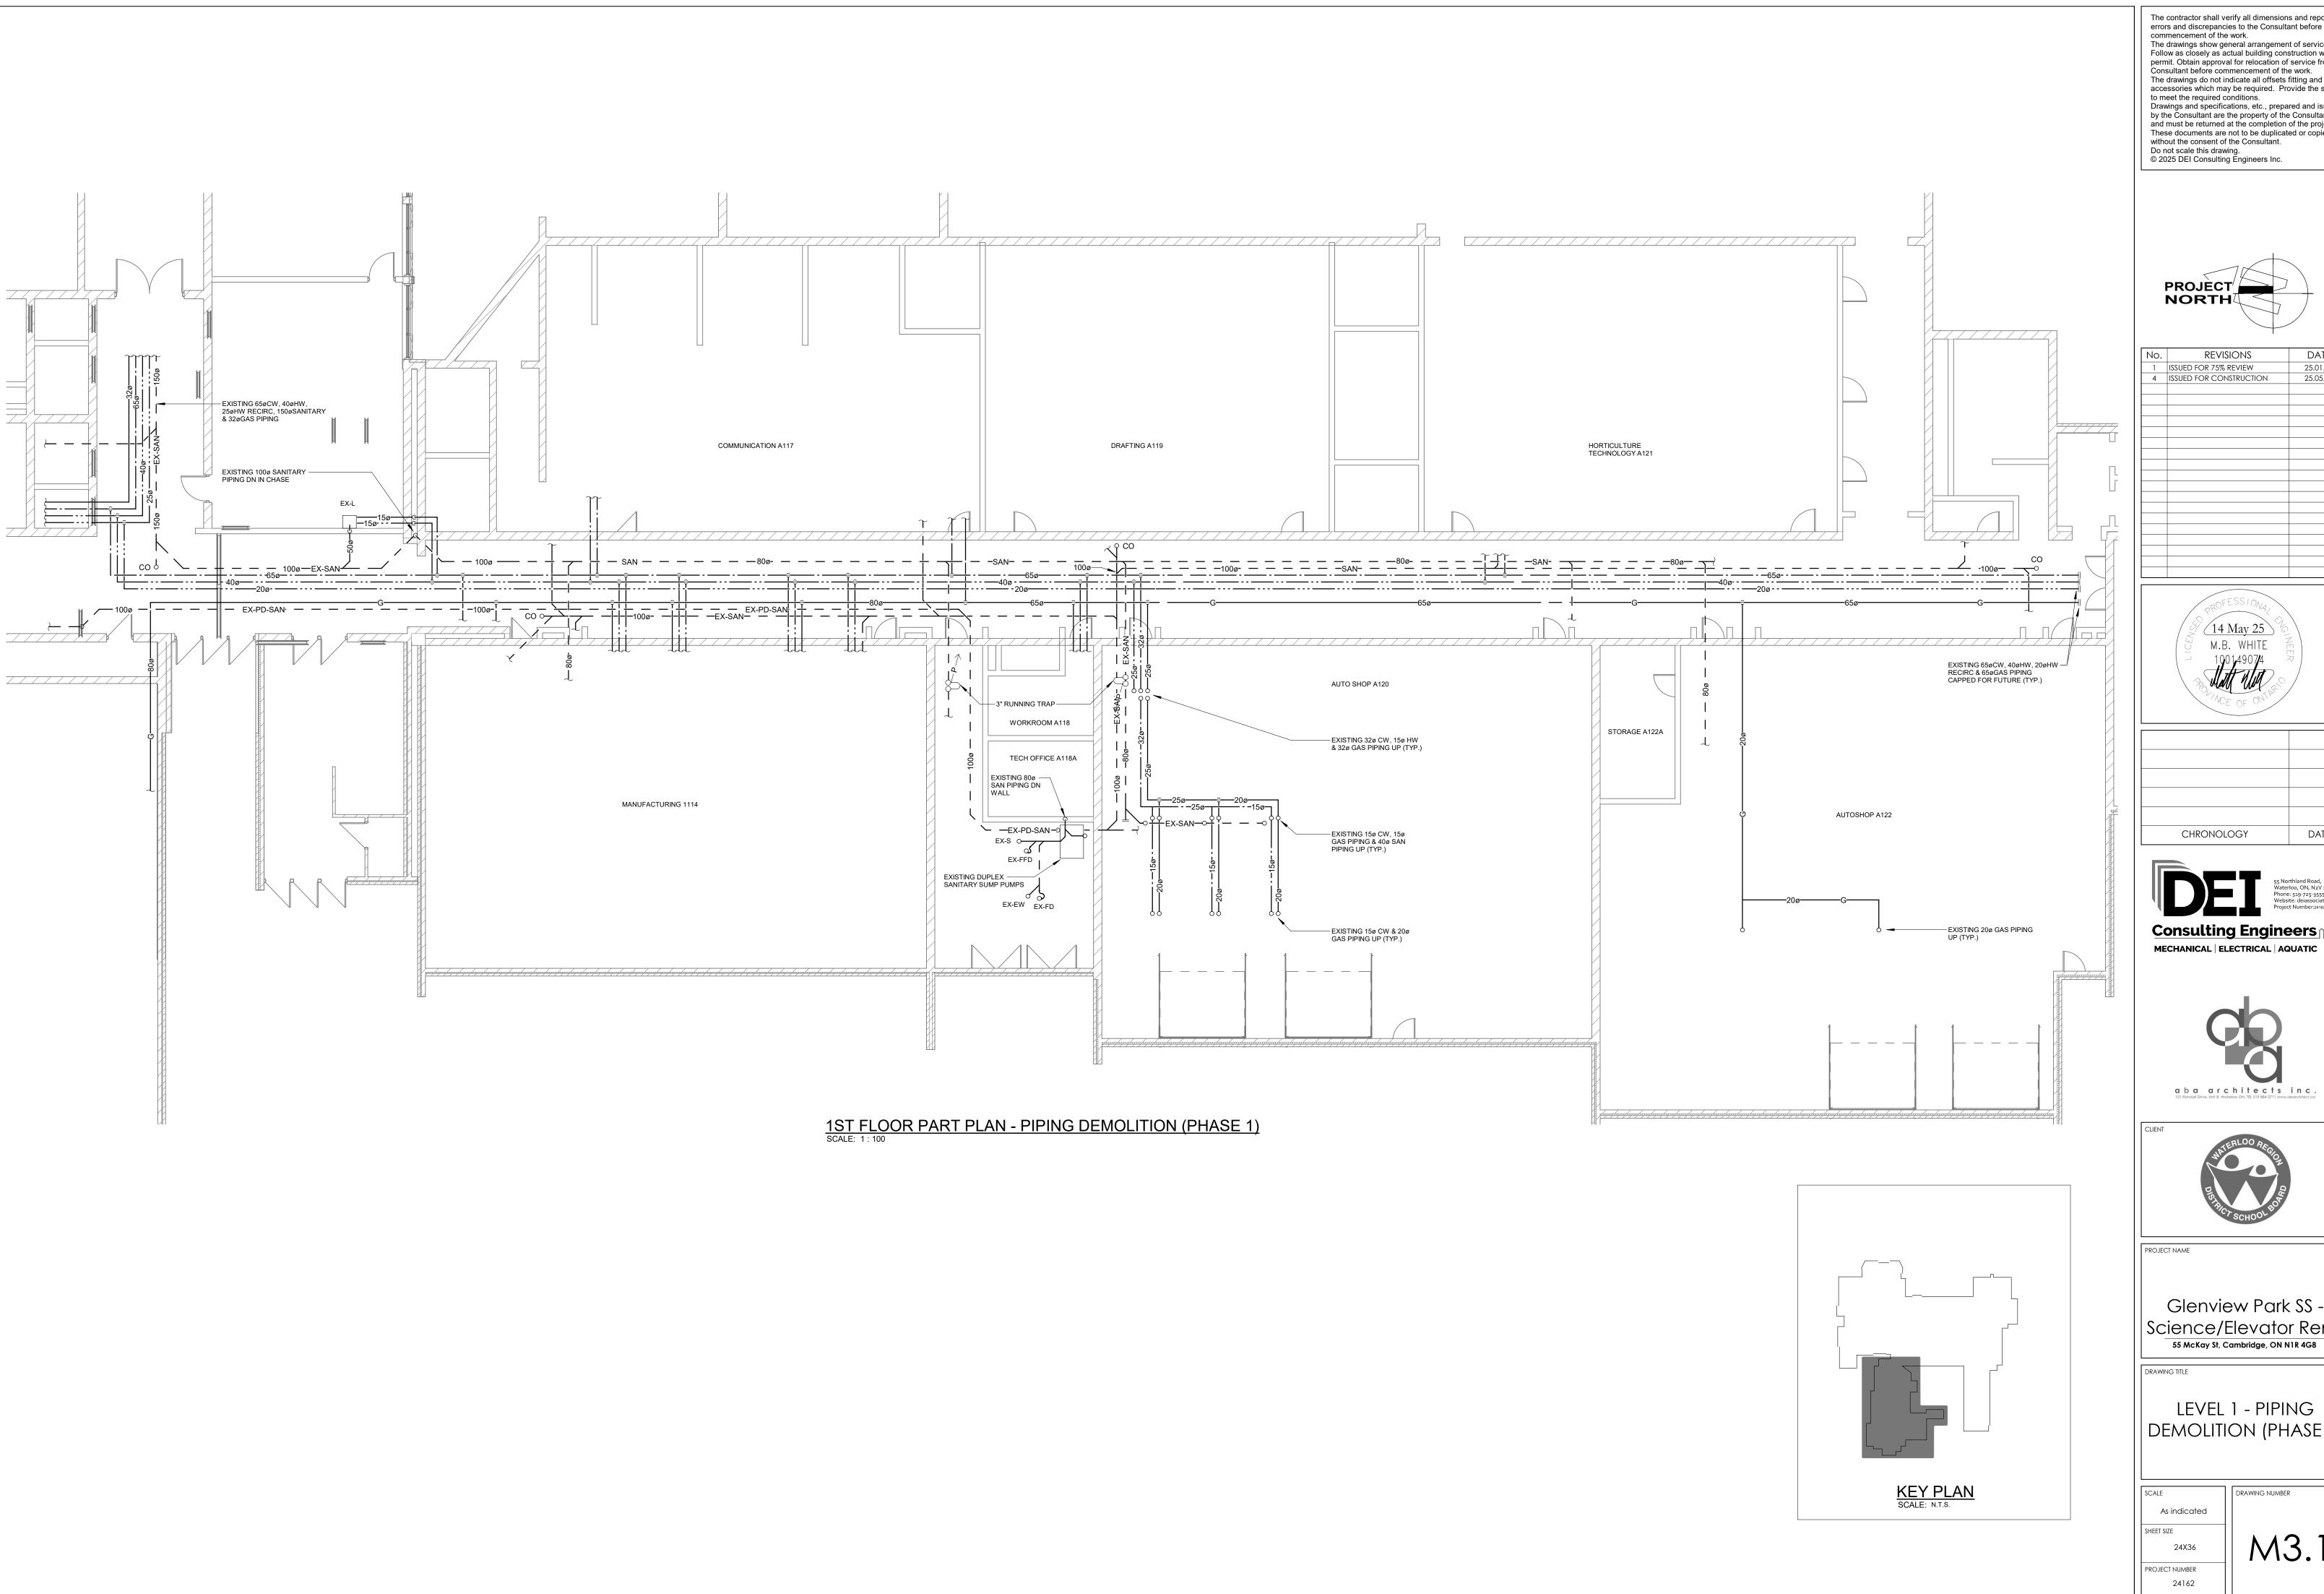

The contractor shall verify all dimensions and report all errors and discrepancies to the Consultant before commencement of the work.


The drawings show general arrangement of services.
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The drawings do not indicate all offsets fitting and accessories which may be required. Provide the same to most the required conditions. to meet the required conditions.

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No.	REVISIONS	DATE
1	ISSUED FOR 75% REVIEW	25.01.31
4	ISSUED FOR CONSTRUCTION	25.05.14








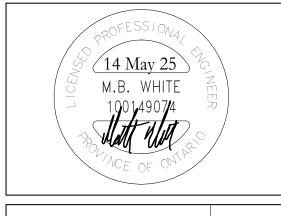

Glenview Park SS -Science/Elevator Reno 55 McKay St, Cambridge, ON N1R 4G8

LEVEL 1 - PIPING DEMOLITION (PHASE 1)

DRAWING NUMBER

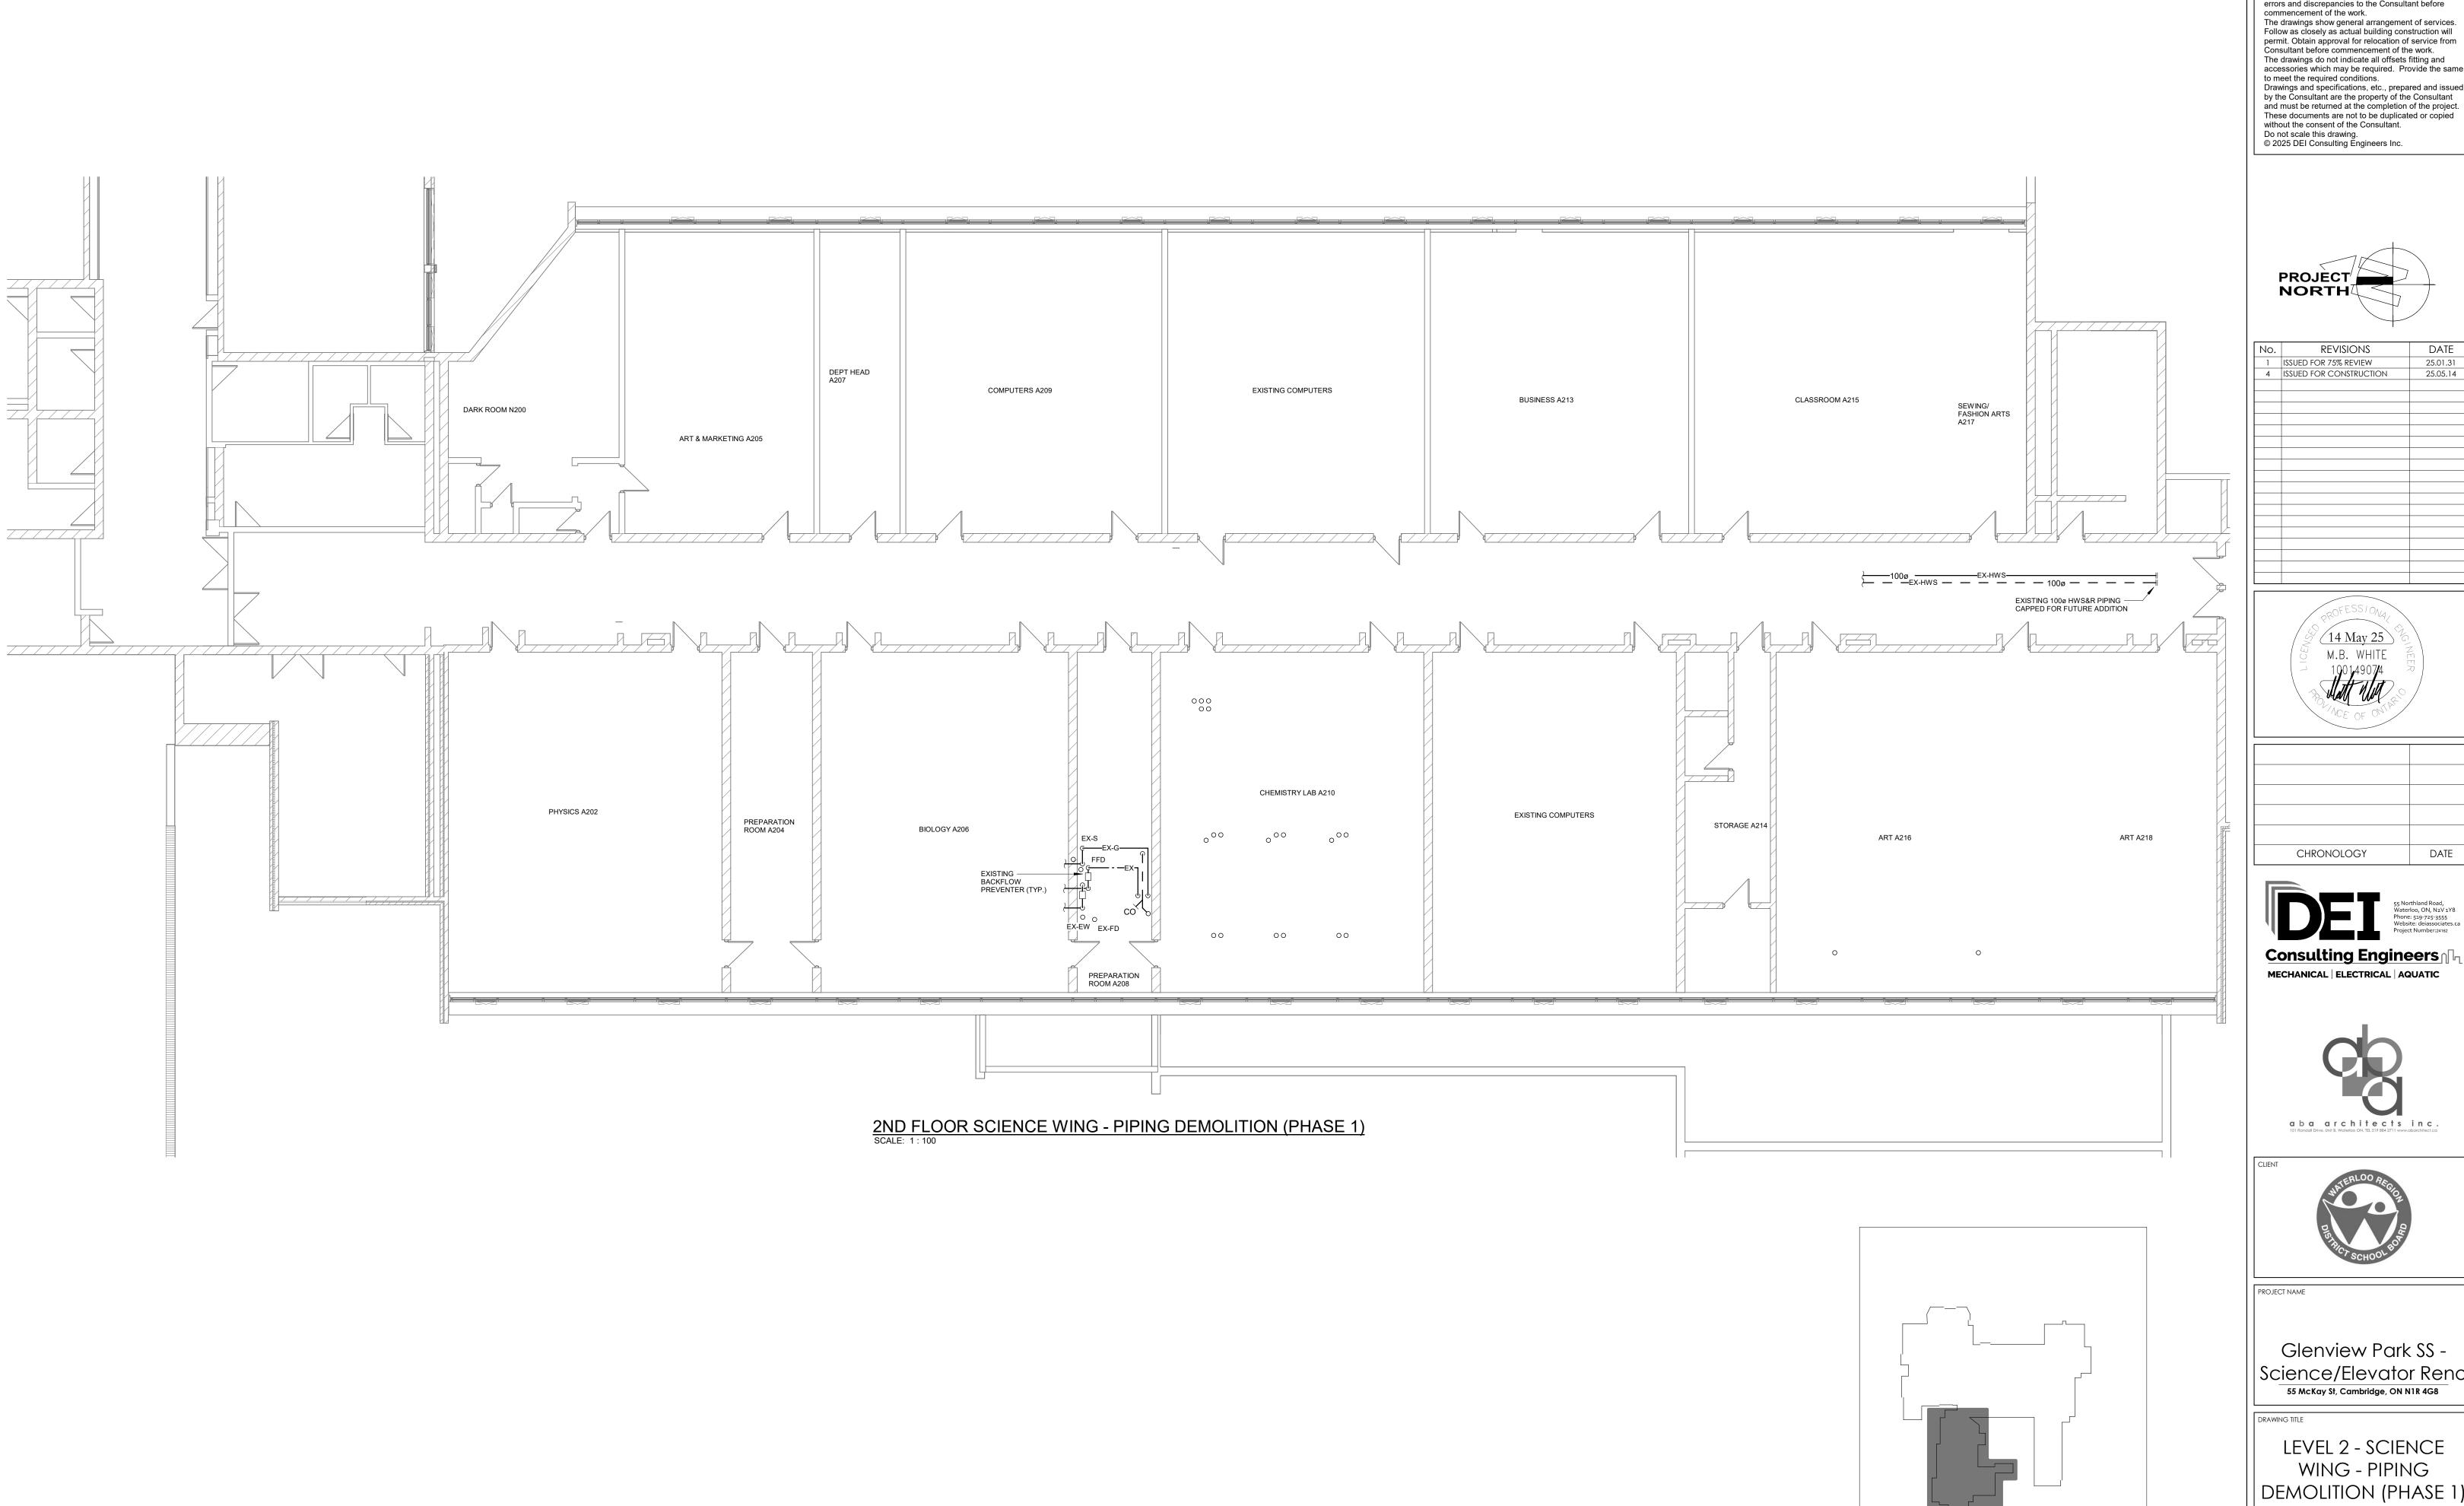

The contractor shall verify all dimensions and report all errors and discrepancies to the Consultant before commencement of the work.

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No.	REVISIONS	DATE
1	ISSUED FOR 75% REVIEW	25.01.31
4	ISSUED FOR CONSTRUCTION	25.05.14



CHRONOLOGY	DATE
Wa Phi Wa	Northland Road, terloo, ON, N2V 1Y8 one: 519-725-3555 bsite: deiassociates.ca ject Number:24162





Glenview Park SS -Science/Elevator Reno

55 McKay St, Cambridge, ON N1R 4G8


KEY PLAN
SCALE: N.T.S.

LEVEL 2 - SCIENCE WING - PIPING DEMOLITION (PHASE 1)

DRAWING NUMBER As indicated


PROJECT NUMBER 24162

M3.2

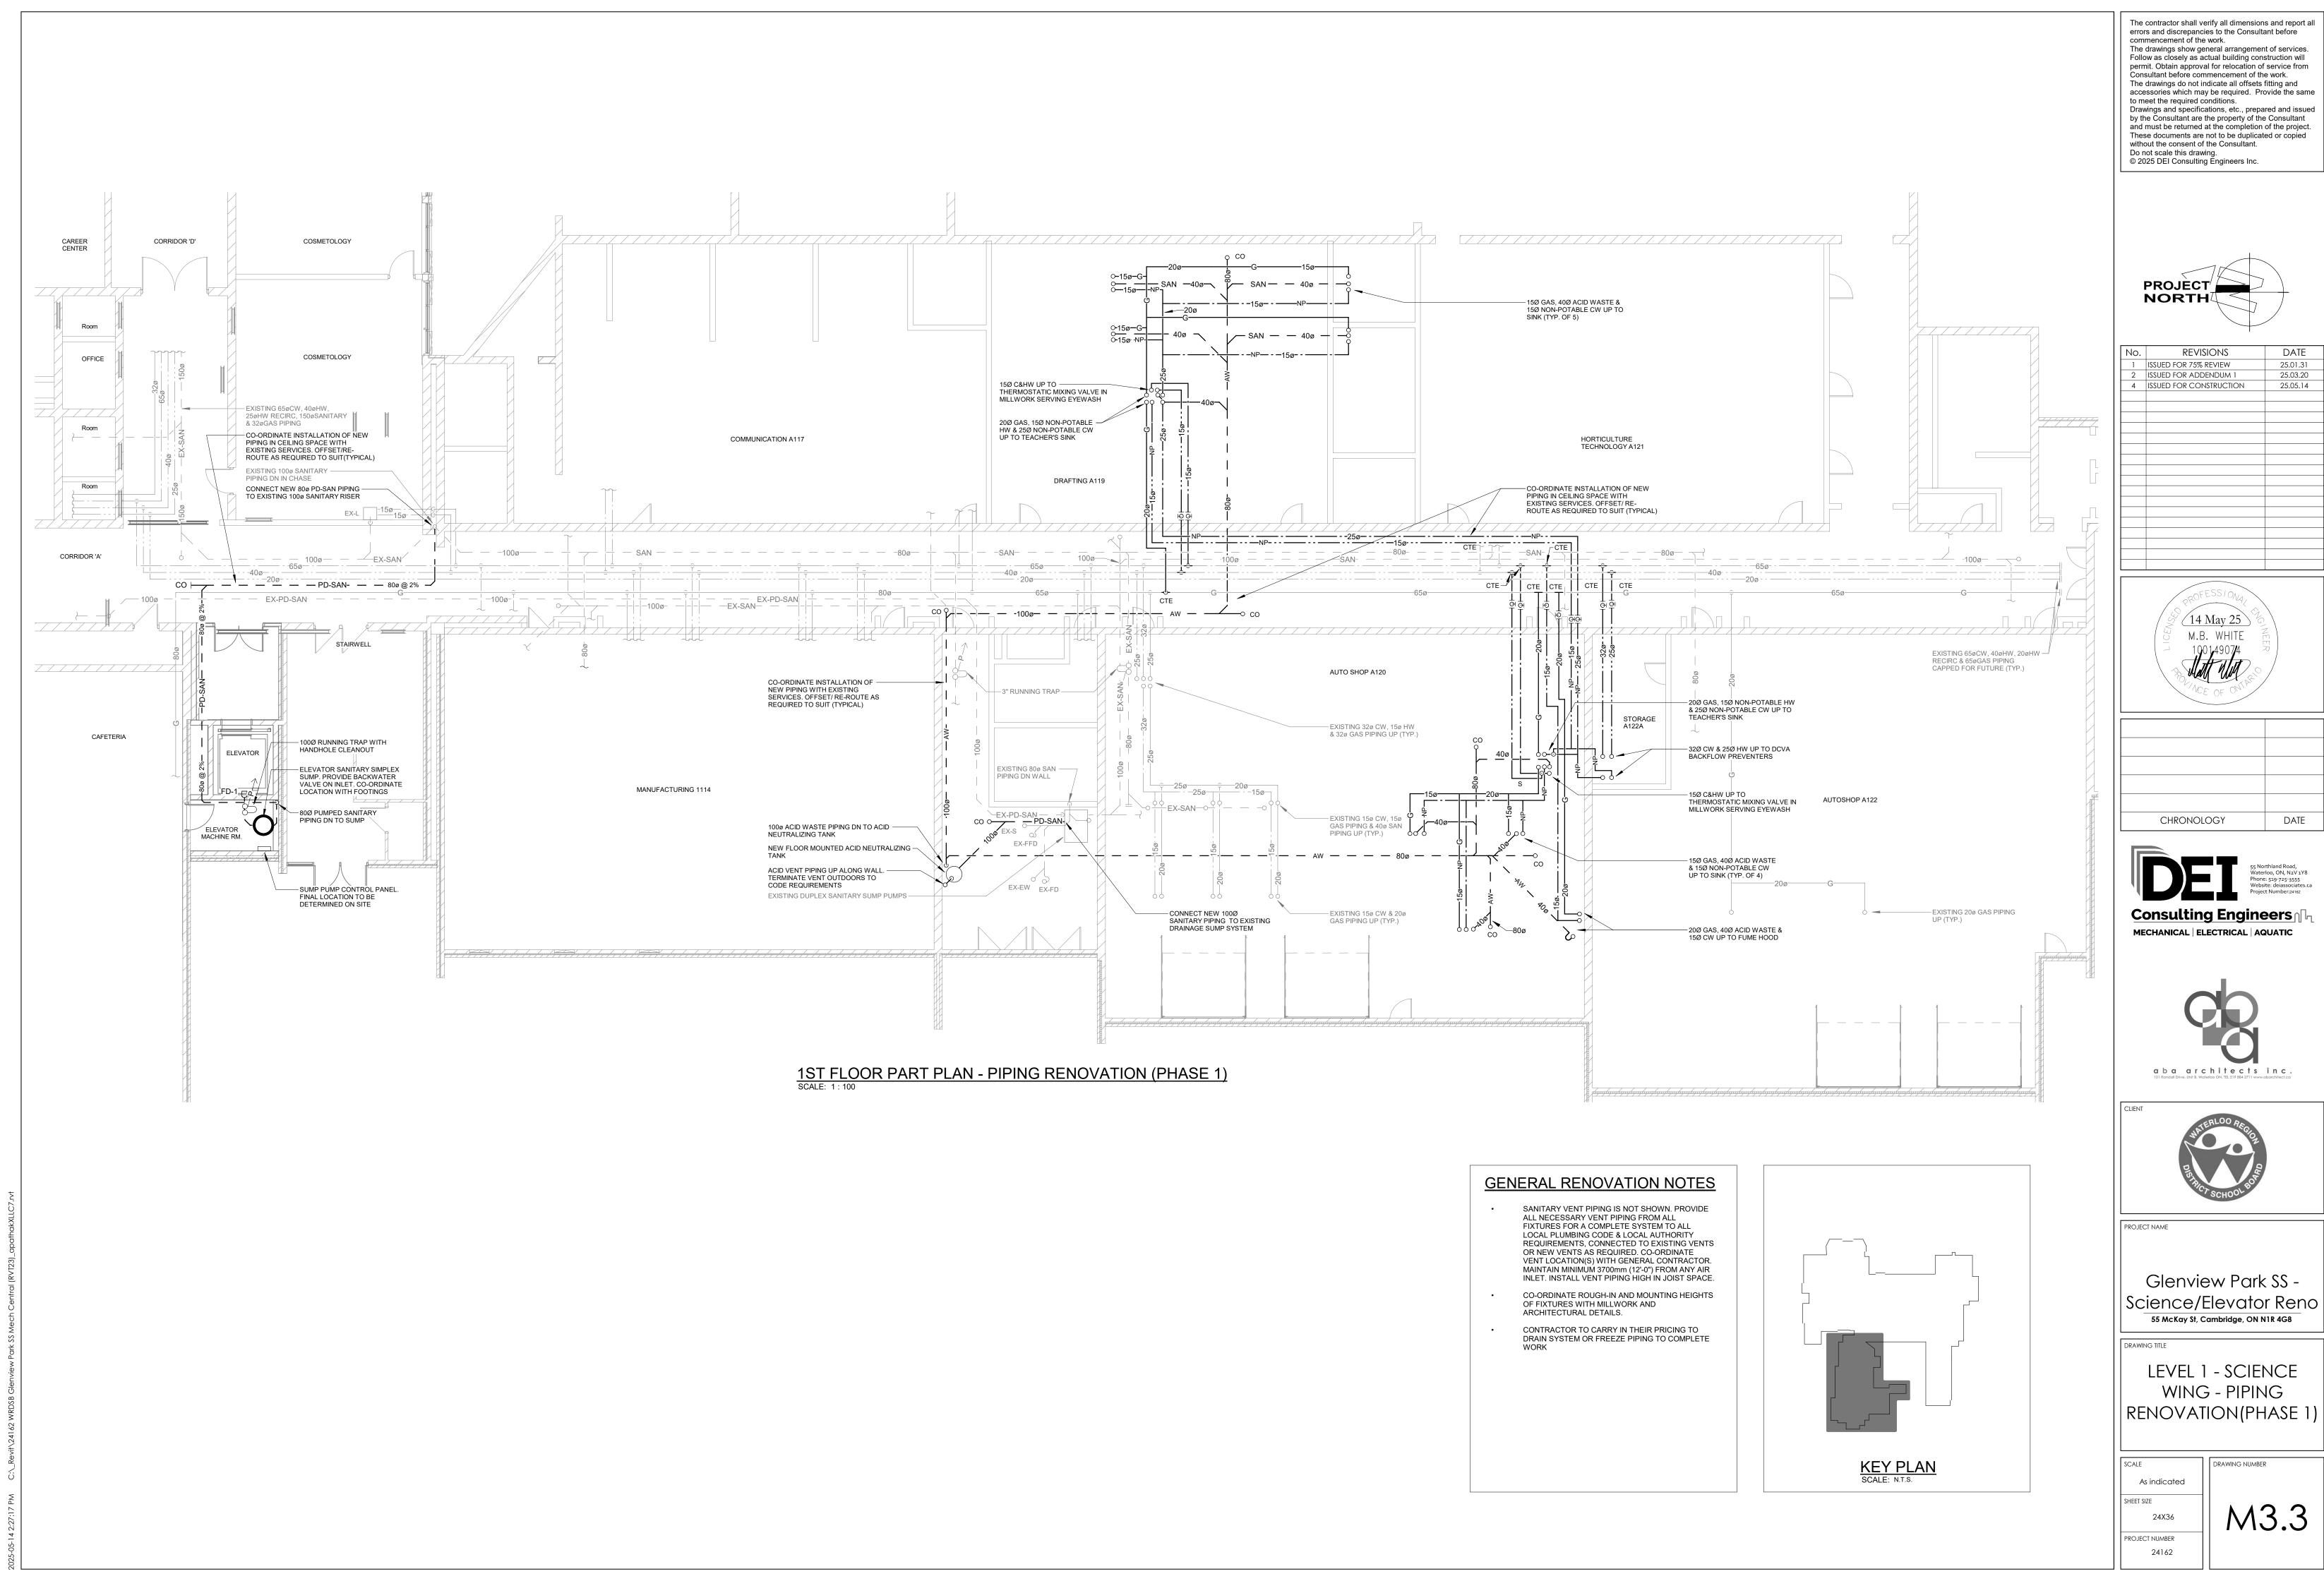

No.	REVISIONS	DATE
1	ISSUED FOR 75% REVIEW	25.01.31
2	ISSUED FOR ADDENDUM 1	25.03.20
4	ISSUED FOR CONSTRUCTION	25.05.14




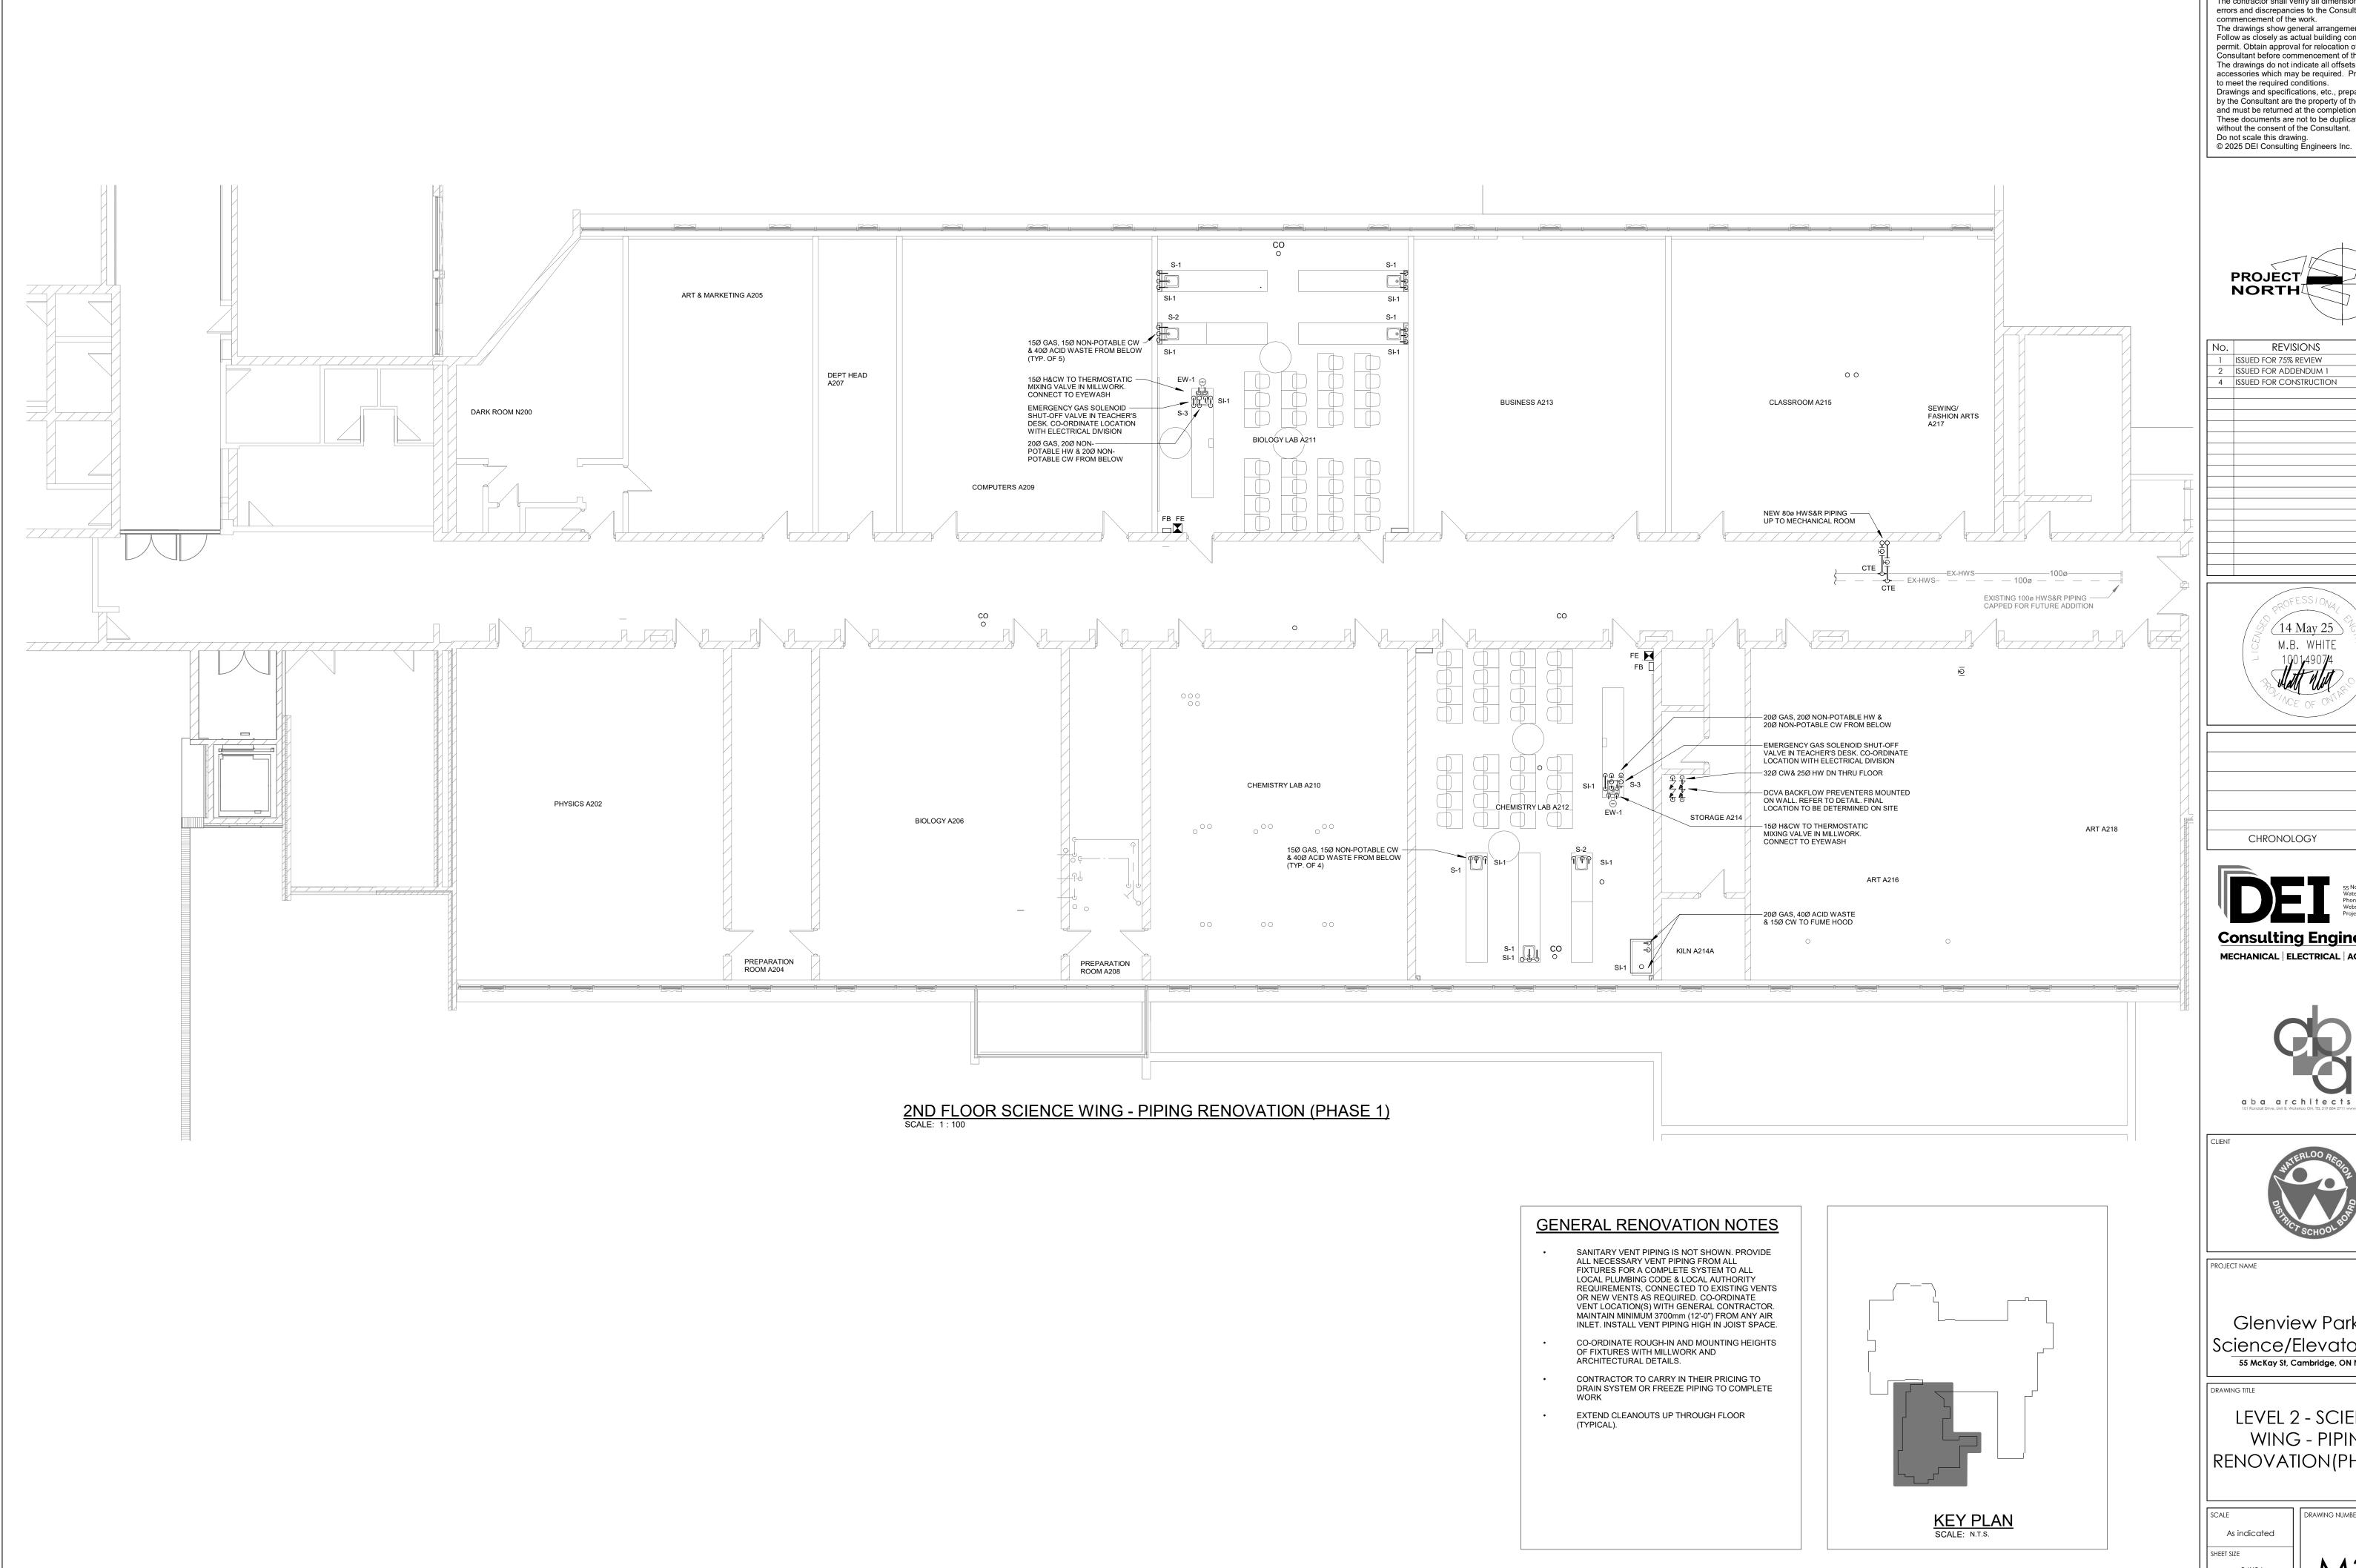

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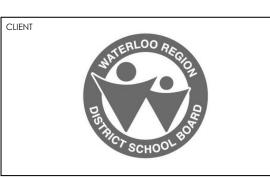
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No.	REVISIONS	DATE
1	ISSUED FOR 75% REVIEW	25.01.31
2	ISSUED FOR ADDENDUM 1	25.03.20
4	ISSUED FOR CONSTRUCTION	25.05.14



CHRONOLOGY	DATE

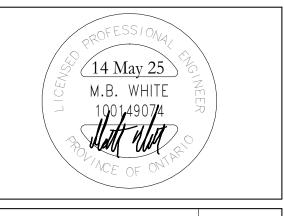





Glenview Park SS -Science/Elevator Reno 55 McKay St, Cambridge, ON N1R 4G8


LEVEL 2 - SCIENCE WING - PIPING RENOVATION(PHASE 1)

DRAWING NUMBER

PROJECT NUMBER

24162

M3.4

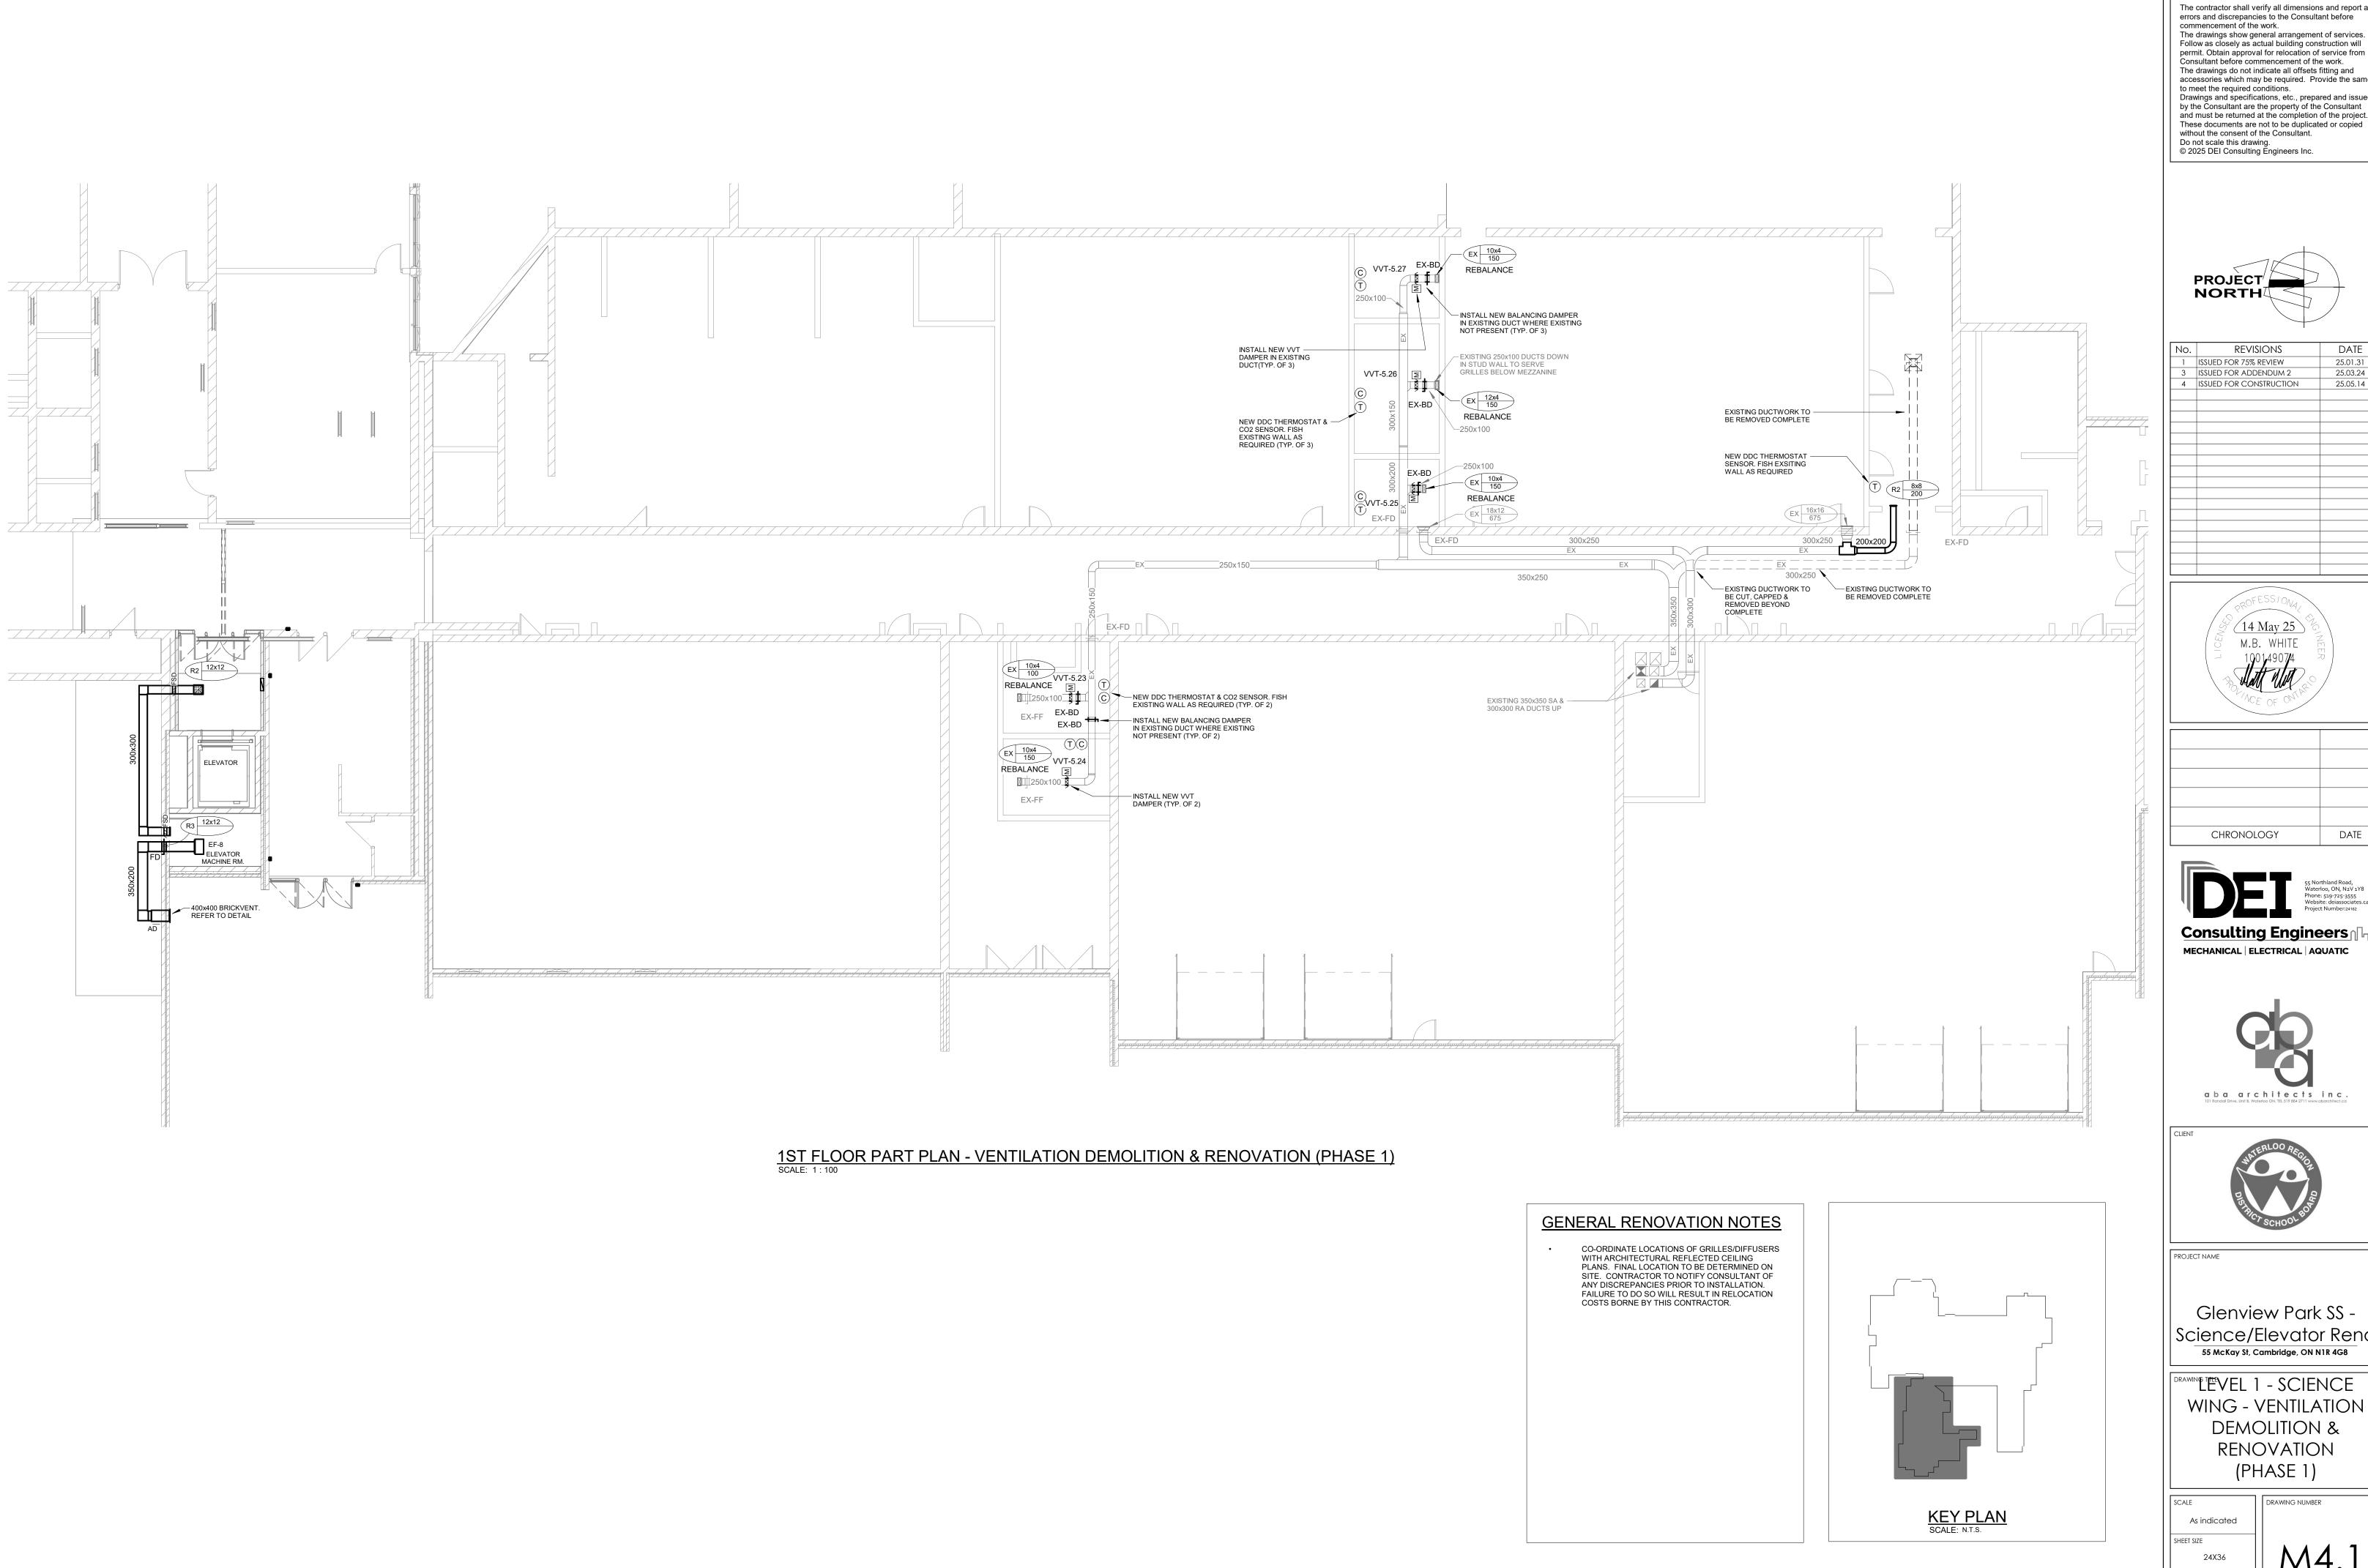

The contractor shall verify all dimensions and report all errors and discrepancies to the Consultant before commencement of the work. commencement of the work.

The drawings show general arrangement of services.
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1	ISSUED FOR 75% REVIEW	25.01.31
3	ISSUED FOR ADDENDUM 2	25.03.24
4	ISSUED FOR CONSTRUCTION	25.05.14











Glenview Park SS -Science/Elevator Reno 55 McKay St, Cambridge, ON N1R 4G8

DRAWING TEVEL 1 - SCIENCE WING - VENTILATION DEMOLITION & RENOVATION (PHASE 1)

PROJECT NUMBER 24162

DRAWING NUMBER As indicated

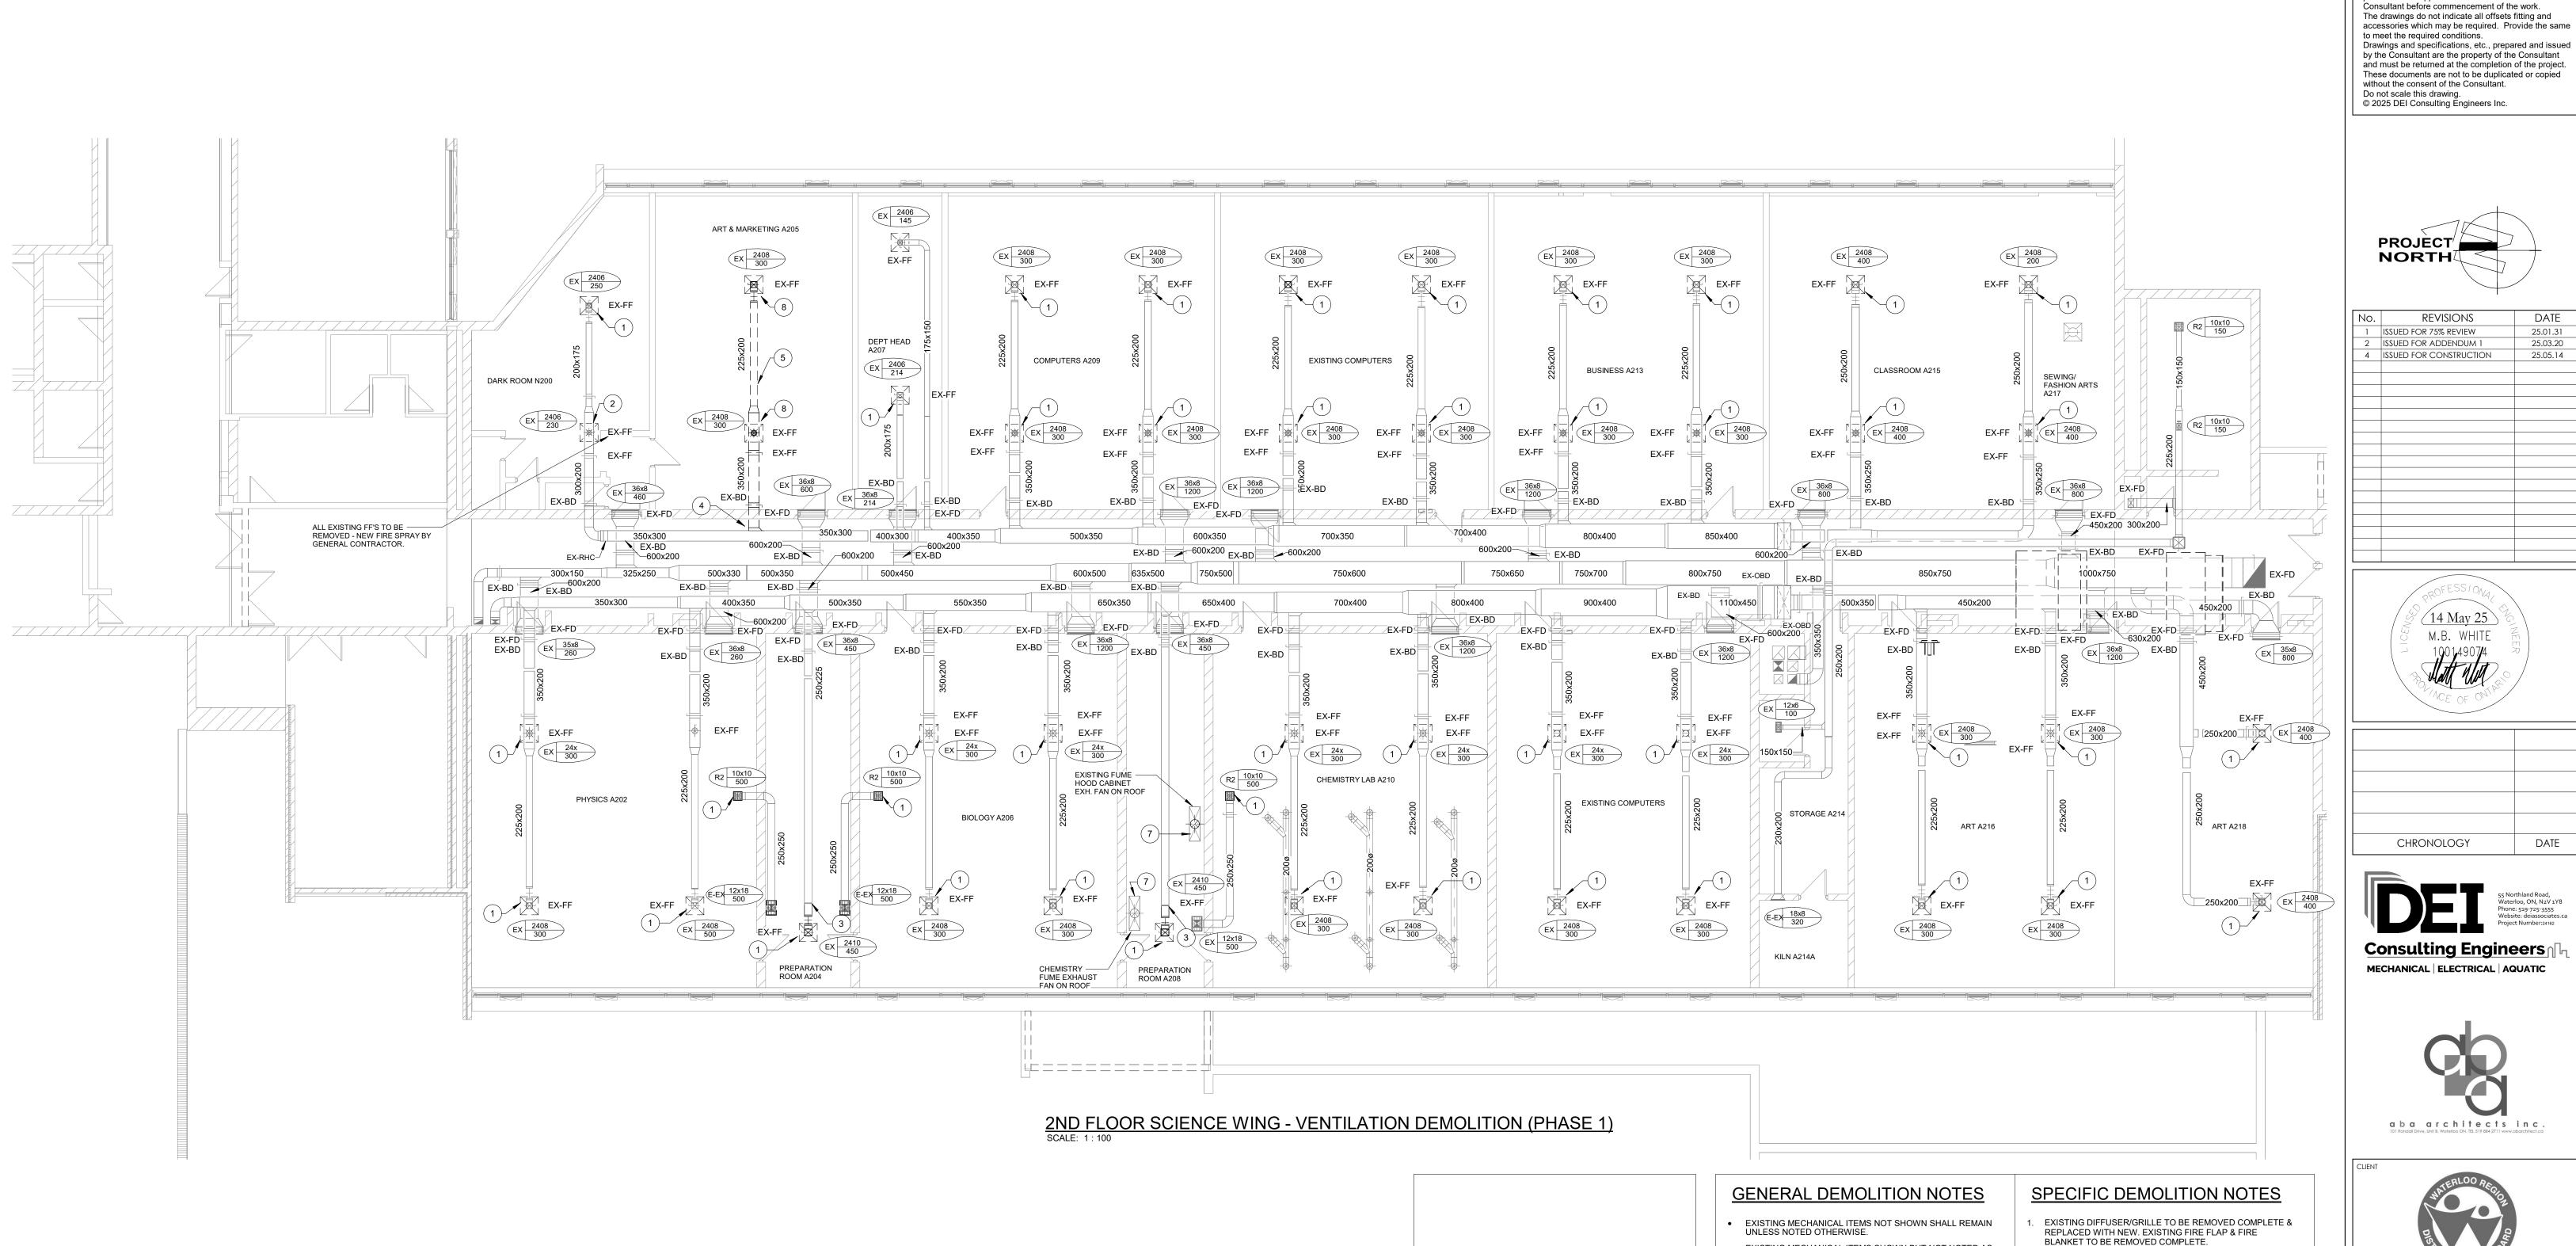

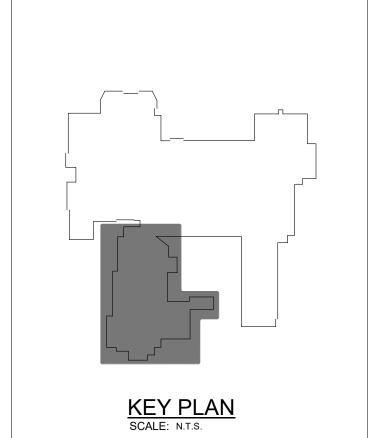

- EXISTING MECHANICAL ITEMS SHOWN BUT NOT NOTED AS BEING REMOVED OR RENOVATED SHALL REMAIN AS PRESENTLY INSTALLED AND OPERATING.
- THIS CONTRACTOR SHALL BE RESPONSIBLE FOR VERIFYING ON SITE ALL LOCATIONS AND SIZES OF ALL SERVICES & EQUIPMENT PRIOR TO THE COMMENCEMENT OF WORK.
- ALL OPENINGS THAT RESULT FROM THE REMOVAL OF EQUIPMENT OR SERVICES SHALL BE NEATLY PATCHED WITH SUITABLE NEW MATERIALS TO SUIT EXISTING CONSTRUCTION.
- REMOVAL OF EXISTING PIPING, OR DUCT SYSTEMS INCLUDES REMOVAL OF ALL HANGERS, INSULATION, FITTINGS, ETC.
- MAINTAIN INTEGRITY OF EXISTING SYSTEMS THAT ARE TO REMAIN OR BE MODIFIED.
- INSTALL NEW SYSTEM OR SERVICES WHERE REQUIRED TO MAINTAIN SYSTEM OPERATION PRIOR TO DEMOLITION OF EXISTING SERVICES.
- THIS CONTRACTOR IS TO REMOVE & REPLACE CEILINGS AS REQUIRED FOR REMOVAL/REPLACEMENT OF SERVICES. EXISTING PNEUMATIC THERMOSTAT/SENSOR TO BE
- REMOVED COMPLETE. REMOVE WIRING/TUBING BACK TO SOURCE. EXISTING PNEUMATIC TUBING TO BE SOLDERED/CRIMPED IN CONCEALED LOCATION. PROVIDE NEW DDC THERMOSTAT.
- 2. EXISTING DIFFUSER/GRILLE TO BE REMOVED COMPLETE. EXISTING DUCTWORK TO BE CUT & CAPPED AT BRANCH MAIN AND REMOVED BEYOND COMPLETE.
- B. EXISTING DUCTWORK TO BE CUT & CAPPED AND REMOVED BEYOND COMPLETE.
- 4. EXISTING DUCTWORK TO BE CUT AND REMOVED BEYOND
- 5. EXISTING DUCTWORK TO BE REMOVED COMPLETE.
- 6. EXISTING DIFFUSER/GRILLE TO BE REMOVED COMPLETE.
- EXISTING DUCTWORK TO BE TEMPORARILY REMOVED TO
- ACCOMMODATS NEW CEILING WORK. RE-INSTALL SAME.
- 8. EXISTING DIFFUSER/ GRILLE TO BE REMOVED COMPLETE.


PROJECT = $\mathsf{NORTH} \mathbb{I}$

No.	REVISIONS	DATE
1	ISSUED FOR 75% REVIEW	25.01.31
2	ISSUED FOR ADDENDUM 1	25.03.20
4	ISSUED FOR CONSTRUCTION	25.05.14
1		

The contractor shall verify all dimensions and report all errors and discrepancies to the Consultant before

The drawings show general arrangement of services.
Follow as closely as actual building construction will permit. Obtain approval for relocation of service from

commencement of the work.

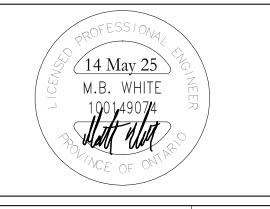

CHRONOLOGY		DATE
	Nater Phone Nebs	rthland Road, rloo, ON, N2V 1Y8 :: 519-725-3555 te: deiassociates.ca t Number:24162





PROJECT NAME

Glenview Park SS -Science/Elevator Reno 55 McKay St, Cambridge, ON N1R 4G8


LEVEL 2 - SCIENCE WING - VENTILATION DEMOLITION (PHASE 1)

As indicated

DRAWING NUMBER


HEET SIZE


PROJECT NUMBER 24162

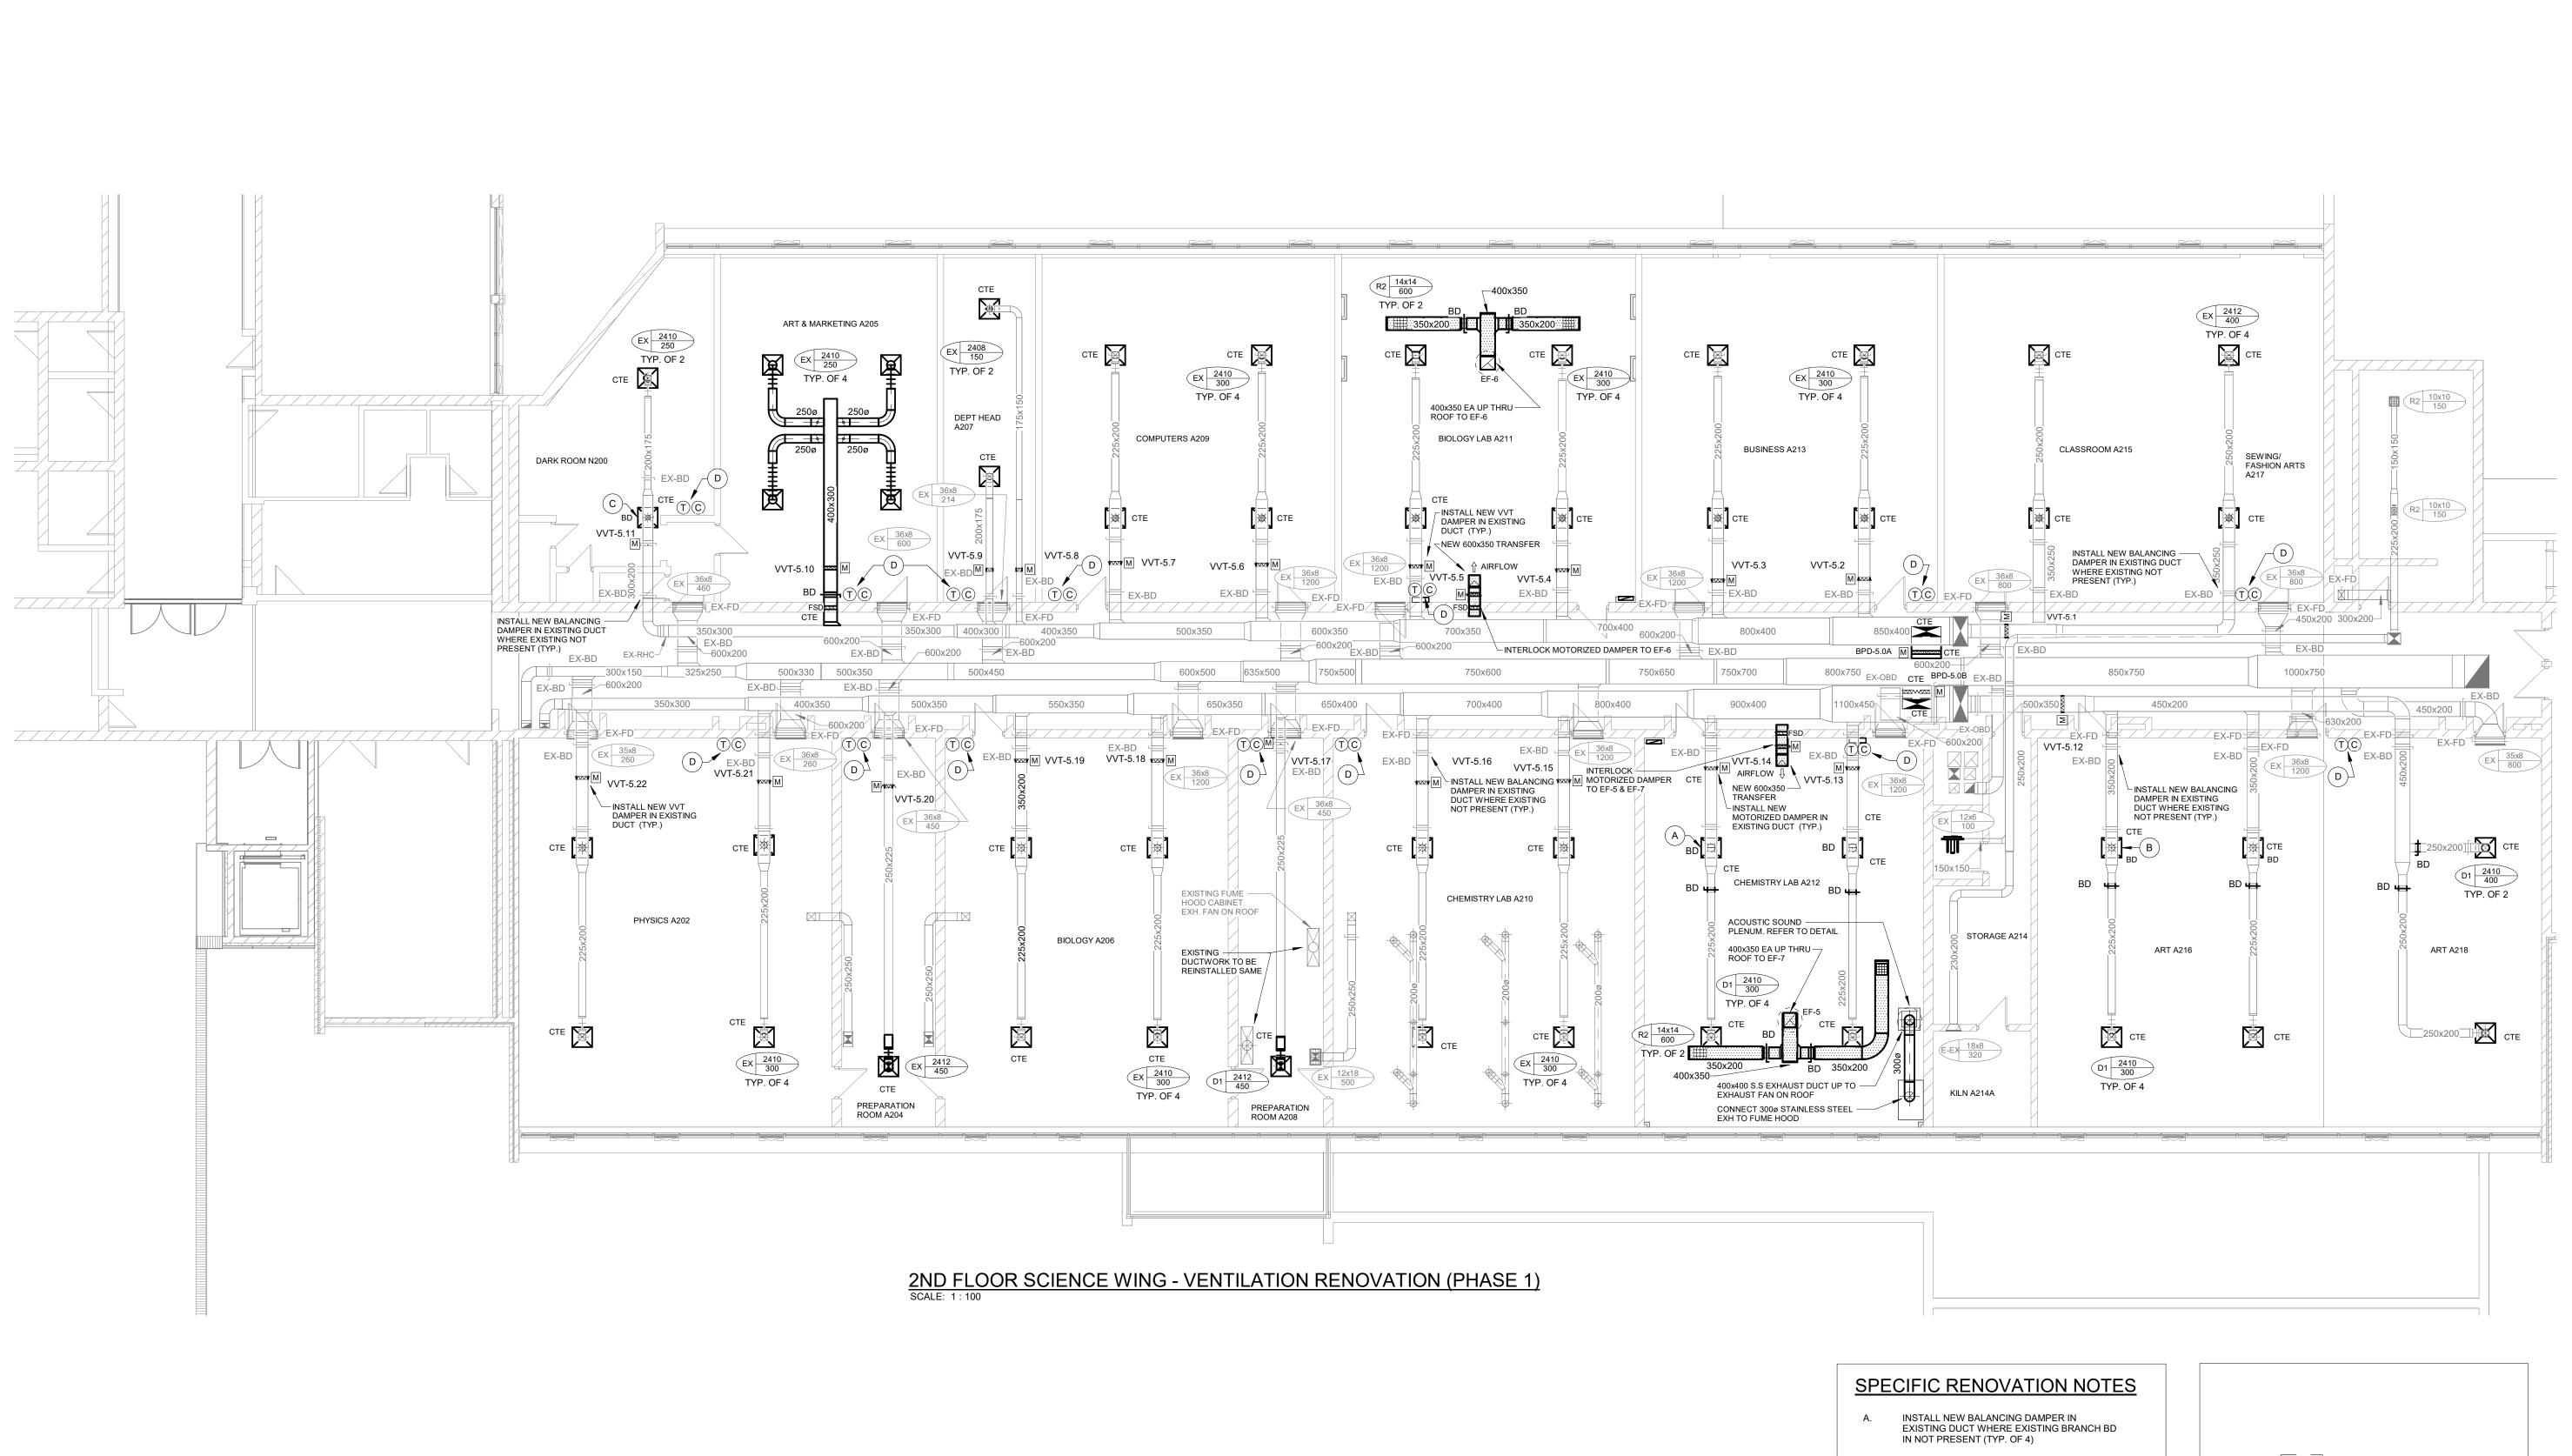

- INSTALL NEW BALANCING DAMPER IN EXISTING DUCT WHERE EXISTING BRANCH BD
- INSTALL NEW BALANCING DAMPER IN EXISTING DUCT WHERE EXISTING BRANCH BD
- NEW DDC THERMOSTAT & CO2 SENSOR.

IN NOT PRESENT (TYP. OF 6)

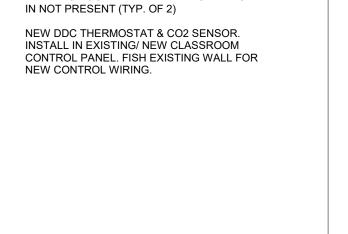


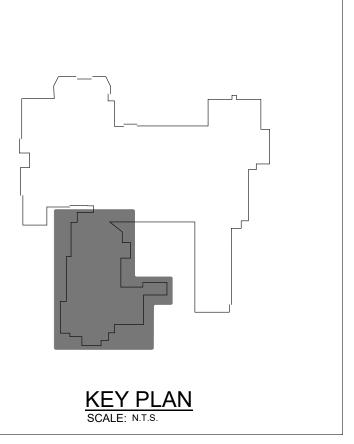


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No.	REVISIONS	DATE
1	ISSUED FOR 75% REVIEW	25.01.31
2	ISSUED FOR ADDENDUM 1	25.03.20
4	ISSUED FOR CONSTRUCTION	25.05.14





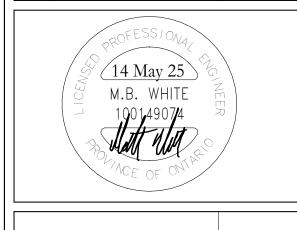
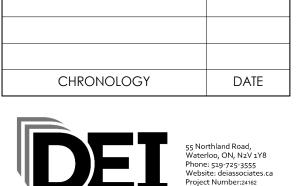
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PROJECT NAME


Glenview Park SS -Science/Elevator Reno 55 McKay St, Cambridge, ON N1R 4G8

LEVEL 2 - SCIENCE WING - VENTILATION RENOVATION (PHASE 1)

DRAWING NUMBER As indicated

SHEET SIZE PROJECT NUMBER

24162

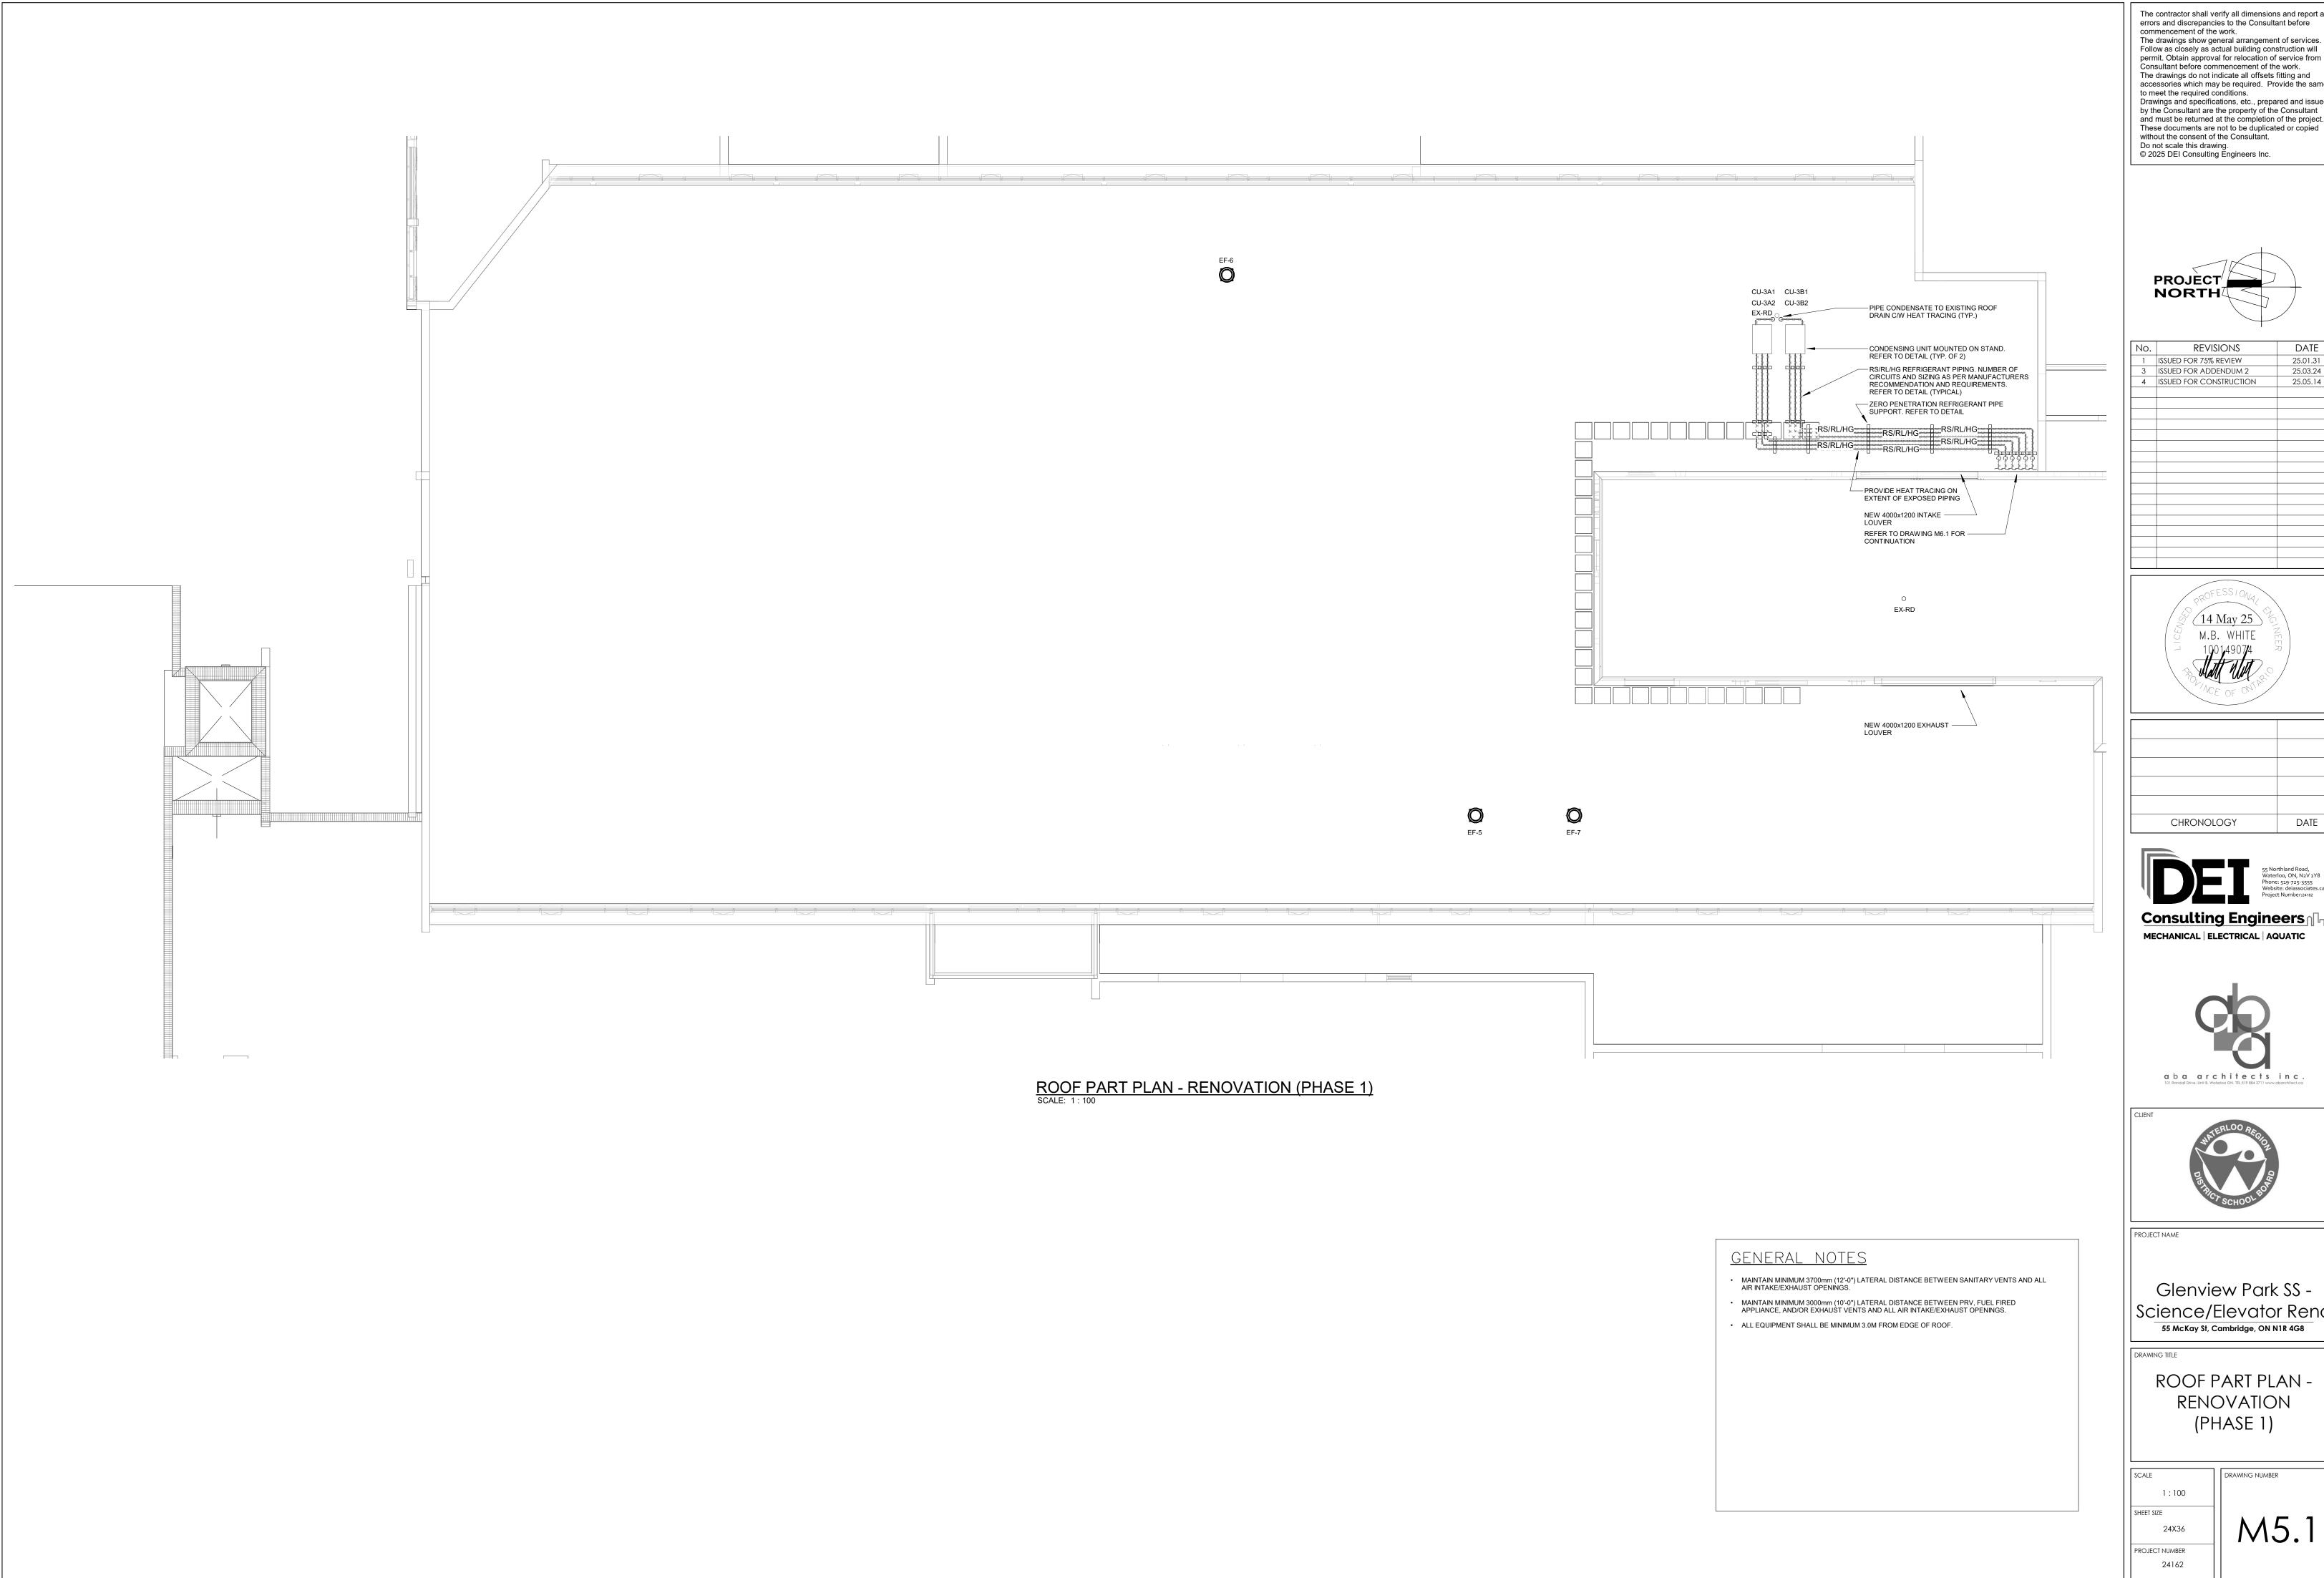

The contractor shall verify all dimensions and report all errors and discrepancies to the Consultant before commencement of the work. commencement of the work.

The drawings show general arrangement of services.
Follow as closely as actual building construction will permit. Obtain approval for relocation of service from Consultant before commencement of the work.


The drawings do not indicate all offsets fitting and accessories which may be required. Provide the same to meet the required conditions.

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No.	REVISIONS	DATE
1	ISSUED FOR 75% REVIEW	25.01.31
3	ISSUED FOR ADDENDUM 2	25.03.24
4	ISSUED FOR CONSTRUCTION	25.05.14
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Glenview Park SS -Science/Elevator Reno 55 McKay St, Cambridge, ON N1R 4G8

> ROOF PART PLAN -RENOVATION (PHASE 1)

GENERAL DEMOLITION NOTES

- EXISTING MECHANICAL ITEMS NOT SHOWN SHALL REMAIN UNLESS NOTED OTHERWISE.
- EXISTING MECHANICAL ITEMS SHOWN BUT NOT NOTED AS BEING REMOVED OR RENOVATED SHALL REMAIN AS
- THIS CONTRACTOR SHALL BE RESPONSIBLE FOR VERIFYING ON SITE ALL LOCATIONS AND SIZES OF ALL SERVICES & EQUIPMENT PRIOR TO THE COMMENCEMENT OF WORK.

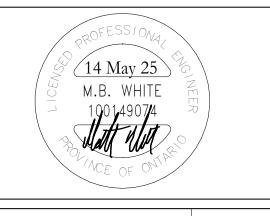
PRESENTLY INSTALLED AND OPERATING.

- ALL OPENINGS THAT RESULT FROM THE REMOVAL OF EQUIPMENT OR SERVICES SHALL BE NEATLY PATCHED WITH SUITABLE NEW MATERIALS TO SUIT EXISTING CONSTRUCTION.
- REMOVAL OF EXISTING PIPING, OR DUCT SYSTEMS INCLUDES REMOVAL OF ALL HANGERS, INSULATION, FITTINGS, ETC.
- MAINTAIN INTEGRITY OF EXISTING SYSTEMS THAT ARE TO REMAIN OR BE MODIFIED.
- INSTALL NEW SYSTEM OR SERVICES WHERE REQUIRED TO MAINTAIN SYSTEM OPERATION PRIOR TO DEMOLITION OF EXISTING SERVICES.
- THIS CONTRACTOR IS TO REMOVE & REPLACE CEILINGS AS REQUIRED FOR REMOVAL/REPLACEMENT OF SERVICES.


SPECIFIC DEMOLITION NOTES


- EXISTING DUCTWORK TO BE CUT AND REMOVED BEYOND COMPLETE.
- EXISTING FAN/UNIT TO BE REMOVED COMPLETE.
- EXISTING DUCTWORK TO BE REMOVED COMPLETE.
- EXISTING BLOCK WALL (BELOW LOUVER) TO BE TEMPORARILY REMOVED TO ACCOMMODATS INSTALLATION OF NEW UNIT INTO ROOM. REFER TO ARCHICTURAL DRAWINGS FOR EXTENT OF BLOCK WALL REMOVAL.
- EXISTING LOUVER TO BE REMOVED COMPLETE.
- EXISTING PNEUMATIC MOTORIZED DAMPER ACTUATOR TO BE REMOVED COMPLETE. EXISTING COMPRESSED AIR TUBING/ CONTROL TO BE REMOVED COMPLETE/ BACK TO SOURCE. EXISTING PNEUMATIC TUBING TO BE SOLDERED/CRIMPED IN CONCEALED LOCATION.
- EXISTING PNEUMATIC MOTORIZED DAMPER TO BE REMOVED COMPLETE. EXISTING COMPRESSED AIR TUBING/ CONTROL TO BE REMOVED COMPLETE/ BACK TO SOURCE. EXISTING PNEUMATIC TUBING TO BE SOLDERED/CRIMPED IN CONCEALED LOCATION.

DELETED

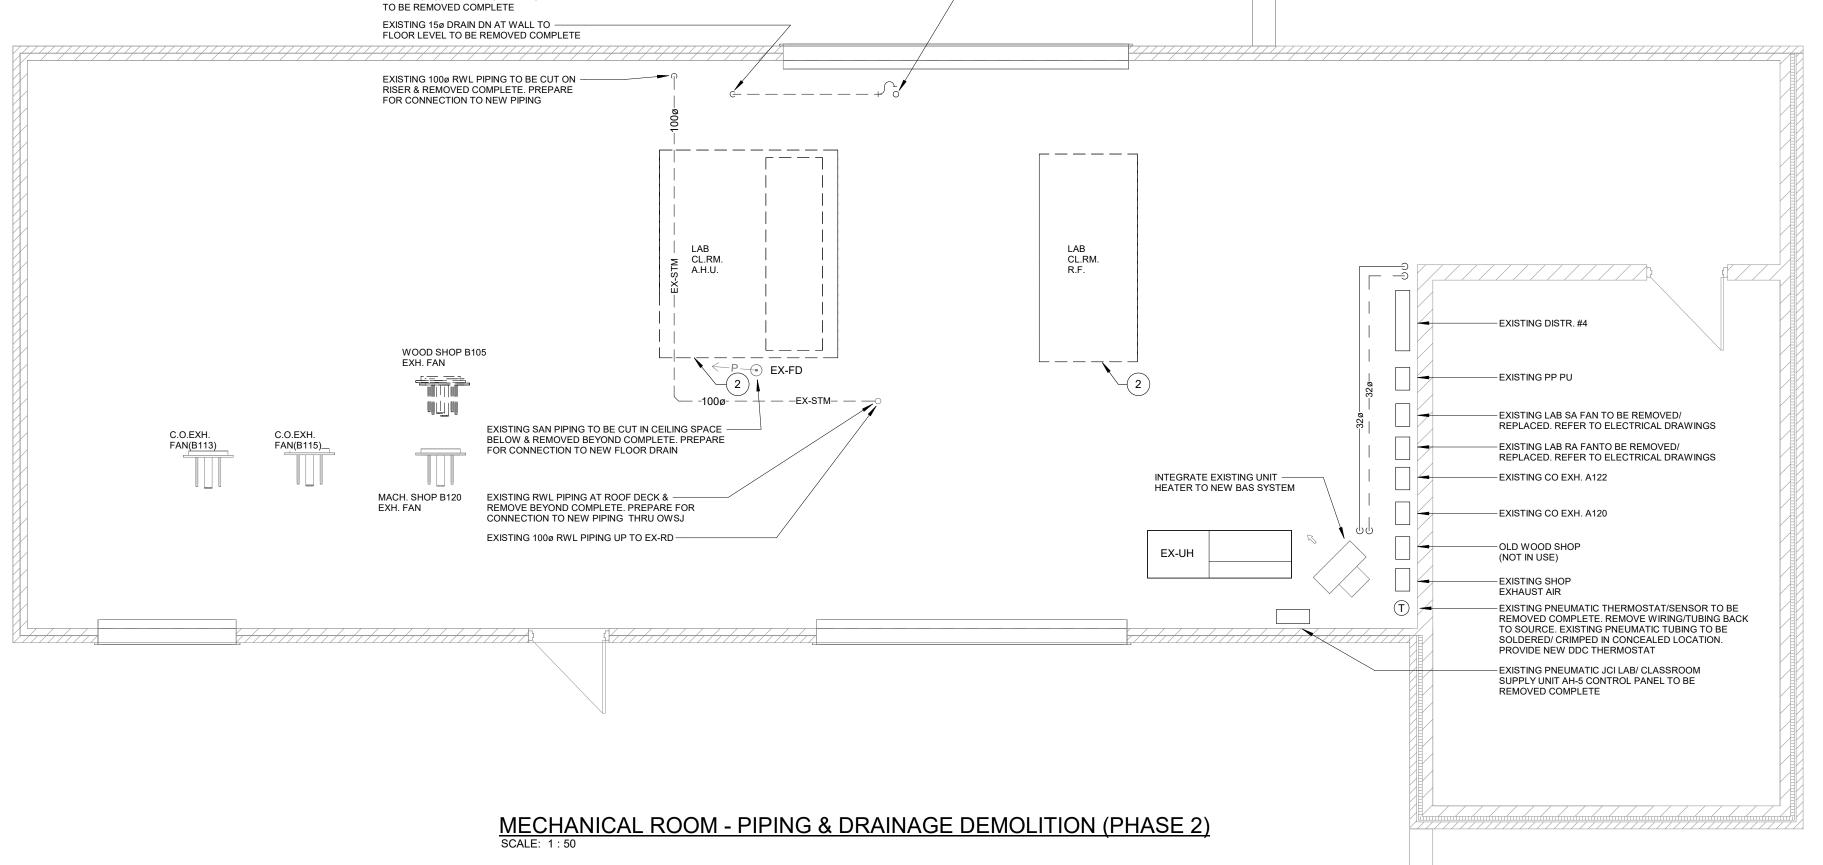

EXISTING 15ø DRAIN FROM PLENUM -

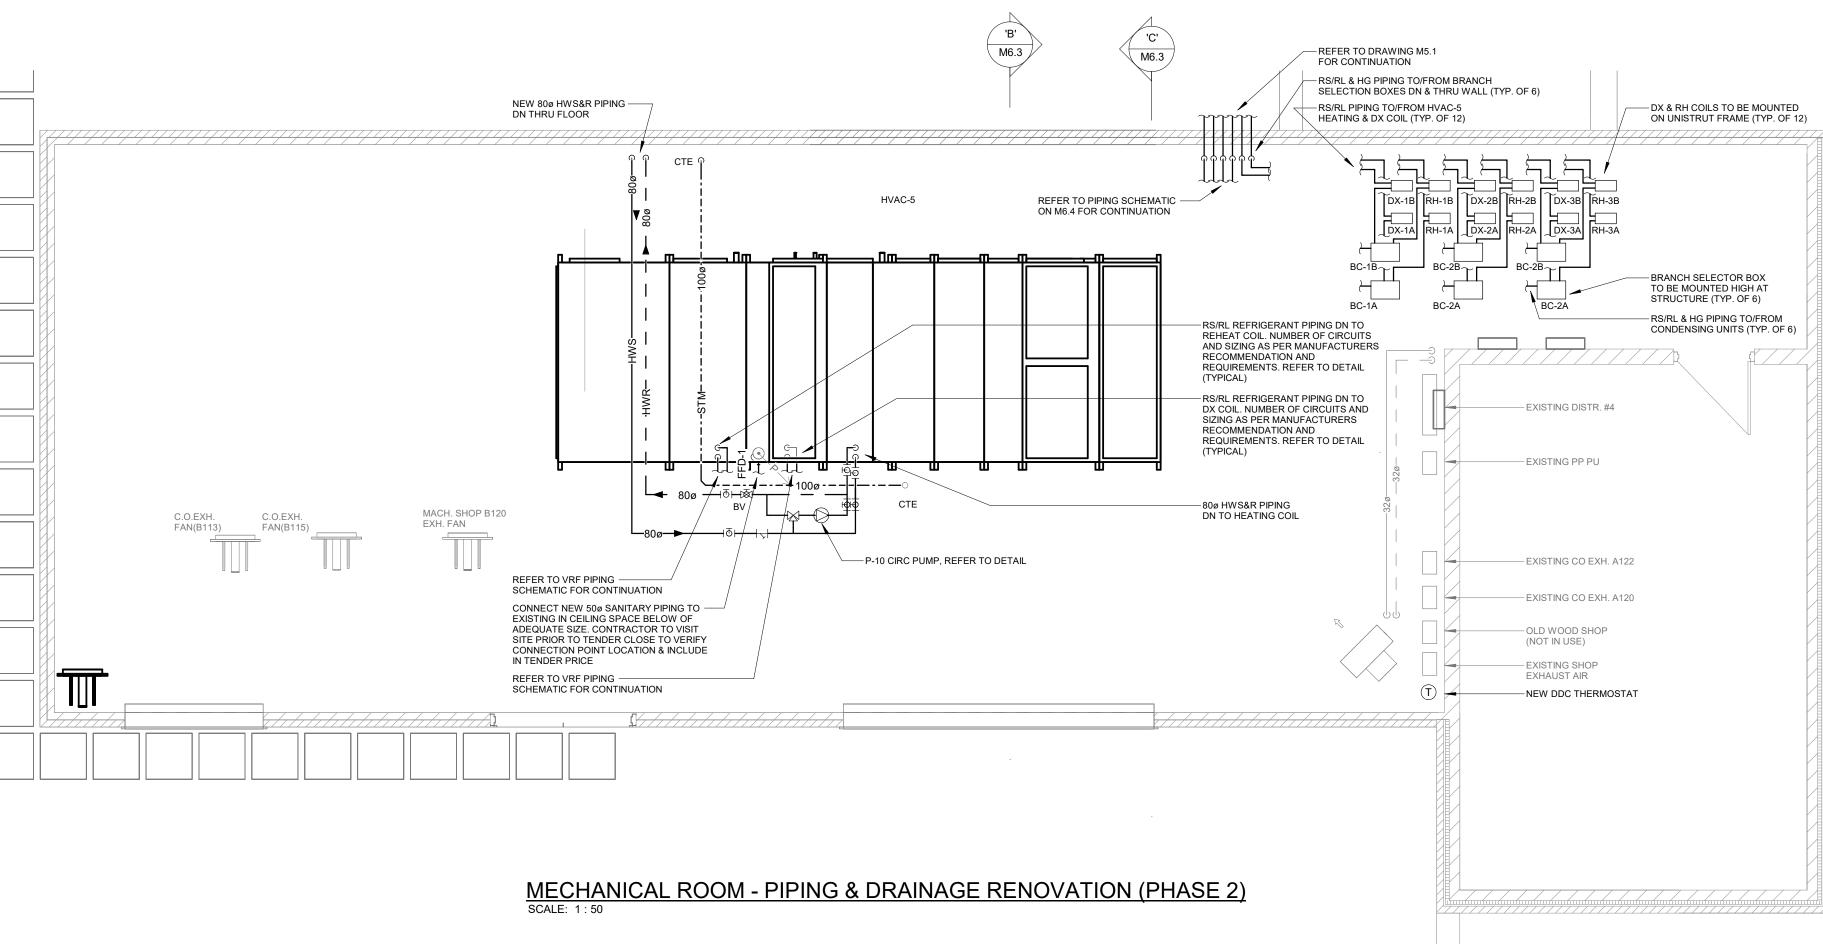

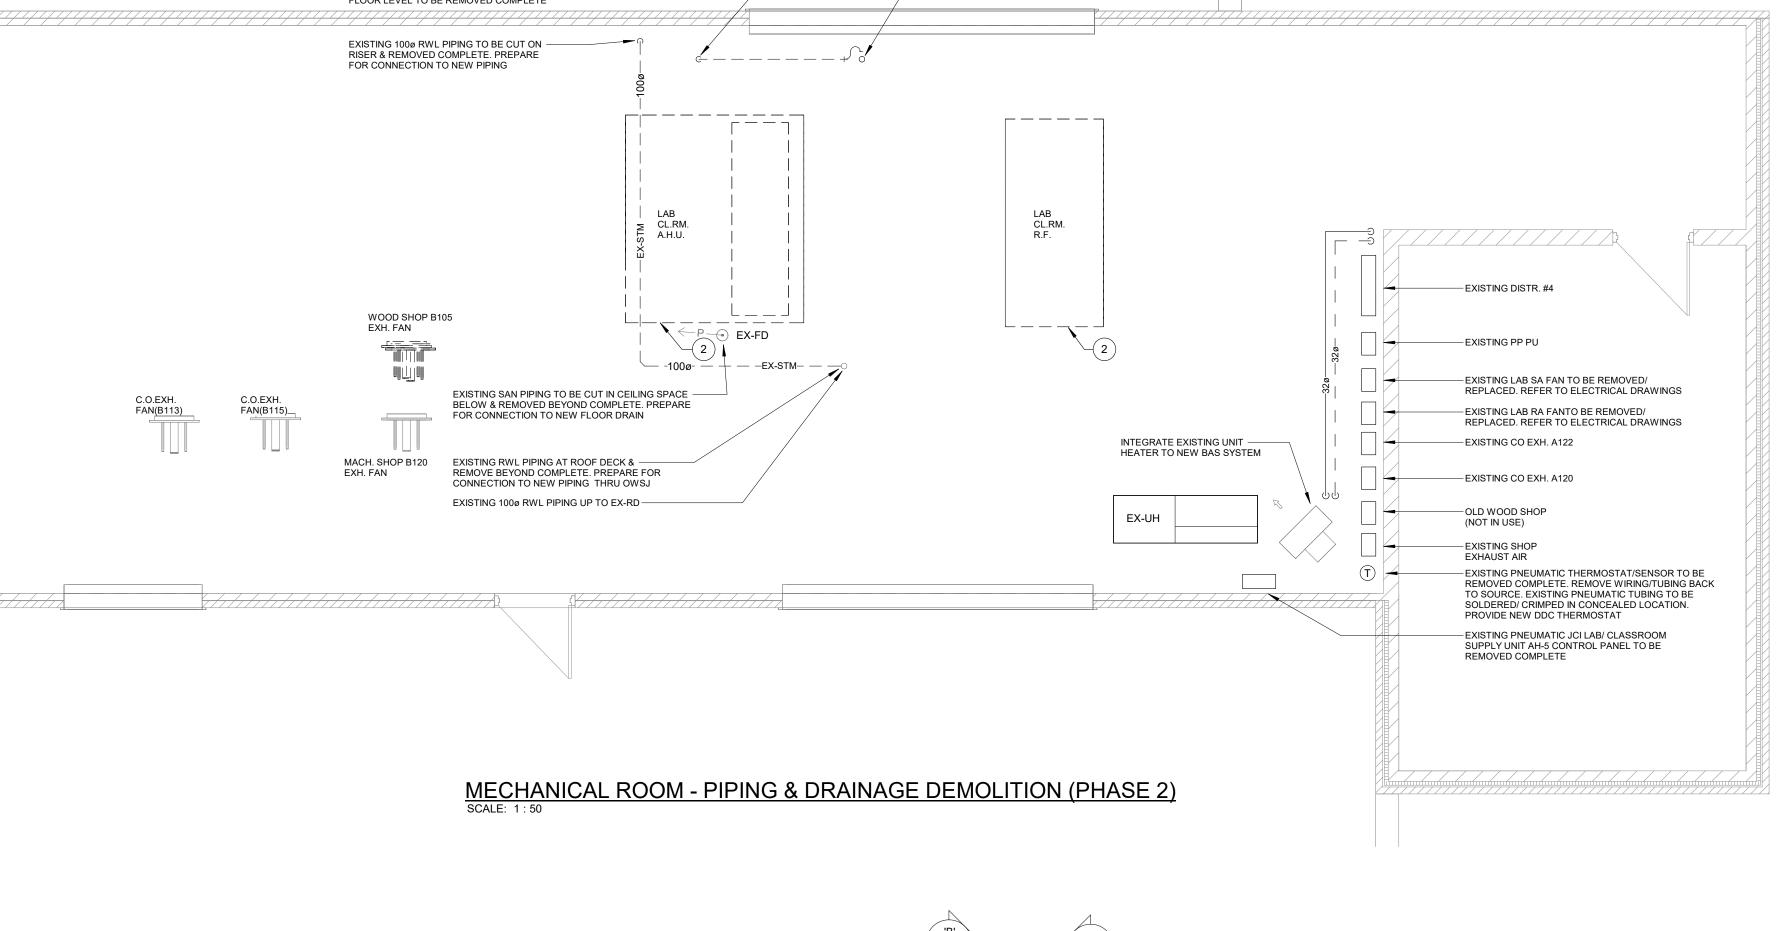


The contractor shall verify all dimensions and report all errors and discrepancies to the Consultant before commencement of the work. The drawings show general arrangement of services. Follow as closely as actual building construction will permit. Obtain approval for relocation of service from Consultant before commencement of the work. The drawings do not indicate all offsets fitting and accessories which may be required. Provide the same to meet the required conditions. Drawings and specifications, etc., prepared and issued by the Consultant are the property of the Consultant and must be returned at the completion of the project. These documents are not to be duplicated or copied without the consent of the Consultant. Do not scale this drawing.

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No.	REVISIONS	DATE
1	ISSUED FOR 75% REVIEW	25.01.31
2	ISSUED FOR ADDENDUM 1	25.03.20
3	ISSUED FOR ADDENDUM 2	25.03.24
4	ISSUED FOR CONSTRUCTION	25.05.14





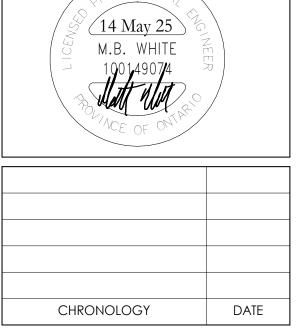



PROJECT NAME

Glenview Park SS -Science/Elevator Reno 55 McKay St, Cambridge, ON N1R 4G8


MECH ROOM - PIPING & DRAINAGE DEMO/RENO(PHASE 2)


DRAWING NUMBER

As indicated

SHEET SIZE

PROJECT NUMBER 24162

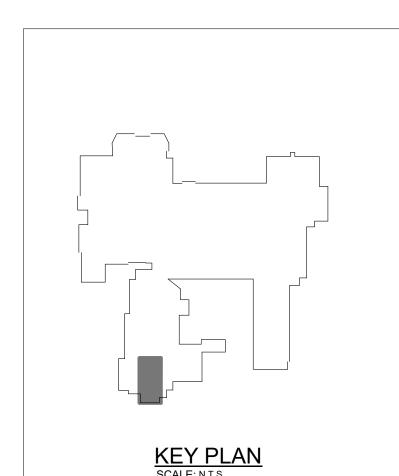

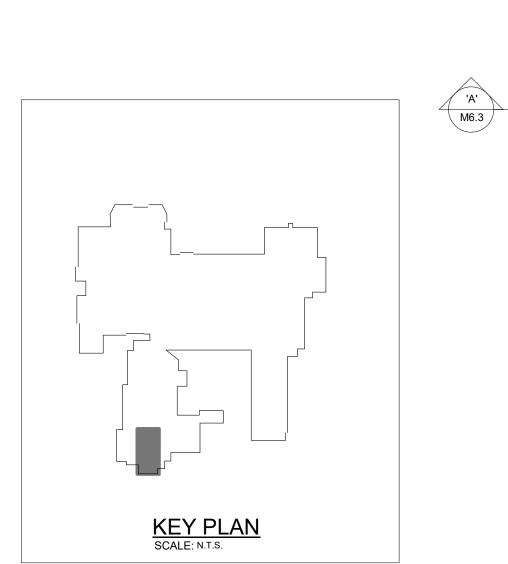

GENERAL DEMOLITION NOTES

- EXISTING MECHANICAL ITEMS NOT SHOWN SHALL REMAIN UNLESS NOTED OTHERWISE.

 EXISTING MECHANICAL ITEMS SHOWN BUT NOT NOTED AS BEING REMOVED OR RENOVATED SHALL REMAIN AS
- PRESENTLY INSTALLED AND OPERATING.

 THIS CONTRACTOR SHALL BE RESPONSIBLE FOR VERIFYING ON SITE ALL LOCATIONS AND SIZES OF ALL SERVICES & EQUIPMENT PRIOR TO THE COMMENCEMENT OF WORK.
- ALL OPENINGS THAT RESULT FROM THE REMOVAL OF EQUIPMENT OR SERVICES SHALL BE NEATLY PATCHED WITH SUITABLE NEW MATERIALS TO SUIT EXISTING CONSTRUCTION.
- REMOVAL OF EXISTING PIPING, OR DUCT SYSTEMS INCLUDES REMOVAL OF ALL HANGERS, INSULATION, FITTINGS, ETC.
 MAINTAIN INTEGRITY OF EXISTING SYSTEMS THAT ARE TO
- REMAIN OR BE MODIFIED.

 INSTALL NEW SYSTEM OR SERVICES WHERE REQUIRED TO MAINTAIN SYSTEM OPERATION PRIOR TO DEMOLITION OF EXISTING SERVICES.
- THIS CONTRACTOR IS TO REMOVE & REPLACE CEILINGS AS REQUIRED FOR REMOVAL/REPLACEMENT OF SERVICES.
- EXISTING PNEUMATIC THERMOSTAT/SENSOR TO BE REMOVED COMPLETE. REMOVE WIRING/TUBING BACK TO SOURCE. EXISTING PNEUMATIC TUBING TO BE SOLDERED/CRIMPED IN CONCEALED LOCATION. PROVIDE NEW DDC THERMOSTAT.

SPECIFIC DEMOLITION NOTES

- EXISTING DUCTWORK TO BE CUT AND REMOVED BEYOND COMPLETE.
- . EXISTING FAN/UNIT TO BE REMOVED COMPLETE.

EXISTING DUCTWORK TO BE REMOVED COMPLETE.


- 4. EXISTING BLOCK WALL (BELOW LOUVER) TO BE TEMPORARILY REMOVED TO ACCOMMODATS INSTALLATION OF NEW UNIT INTO ROOM. REFER TO ARCHICTURAL DRAWINGS FOR EXTENT OF BLOCK WALL REMOVAL.
- 5. EXISTING LOUVER TO BE REMOVED COMPLETE.
- 6. EXISTING PNEUMATIC MOTORIZED DAMPER ACTUATOR TO BE REMOVED COMPLETE. EXISTING COMPRESSED AIR TUBING/ CONTROL TO BE REMOVED COMPLETE/ BACK TO SOURCE. EXISTING PNEUMATIC TUBING TO BE SOLDERED/CRIMPED IN CONCEALED LOCATION.
- 7. EXISTING PNEUMATIC MOTORIZED DAMPER TO BE REMOVED COMPLETE. EXISTING COMPRESSED AIR TUBING/ CONTROL TO BE REMOVED COMPLETE/ BACK TO SOURCE. EXISTING PNEUMATIC TUBING TO BE SOLDERED/CRIMPED IN CONCEALED LOCATION.
- 8. EXISTING OBSOLETE EXHAUST FAN TO BE REMOVED COMPLETEAND STORED ON SITE IN MECH ROOM FOR FUTURE USE BY OWNER.
- 9. EXISTING DUCTWORK TO BE CUT AT LOUVER/PLENUM AND REMOVED BEYOND COMPLETE.
- 10. EXISTING DUCT TO BE REMOVED COMPLETE. CAP IN CEILIING SPACE BELOW. COORDINATE FLOOR OPENING INFILL WITH GENERAL CONTRACTOR.


SPECIFIC RENOVATION NOTES

- A. NEW DDC MOTORIZED DAMPER ACTUATOR. PROVIDE NEW CONTROL WIRING.
- B. NEW MOTORIZED DAMPER & DDC ACTUATOR.

NOTE

HVAC UNIT SHALL BE DELIVERED IN SECTIONS AND ASSEMBLED ON SITE IN PLACE. IT IS THE RESPONSIBILITY OF THIS CONTRACTOR TO INSTALL THE UNIT IN PLACE TO THE STANDARDS OF THE MANUFACTURER

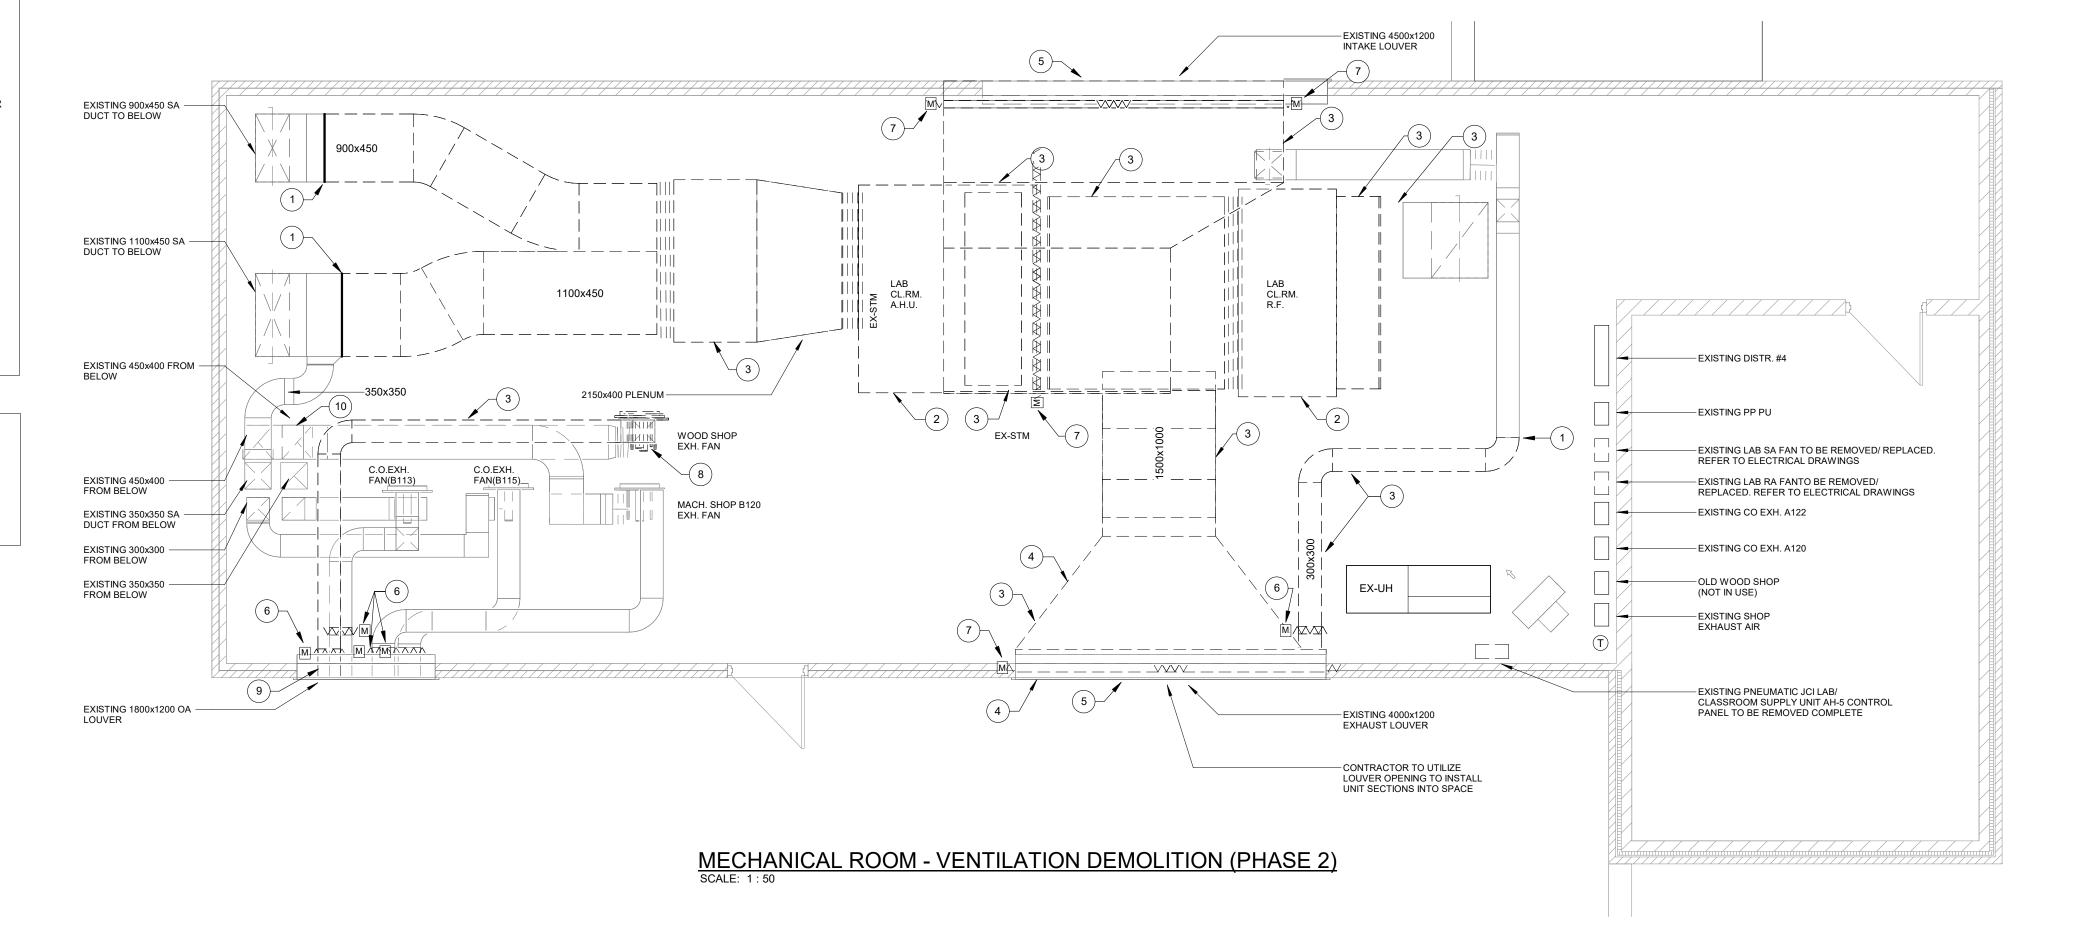


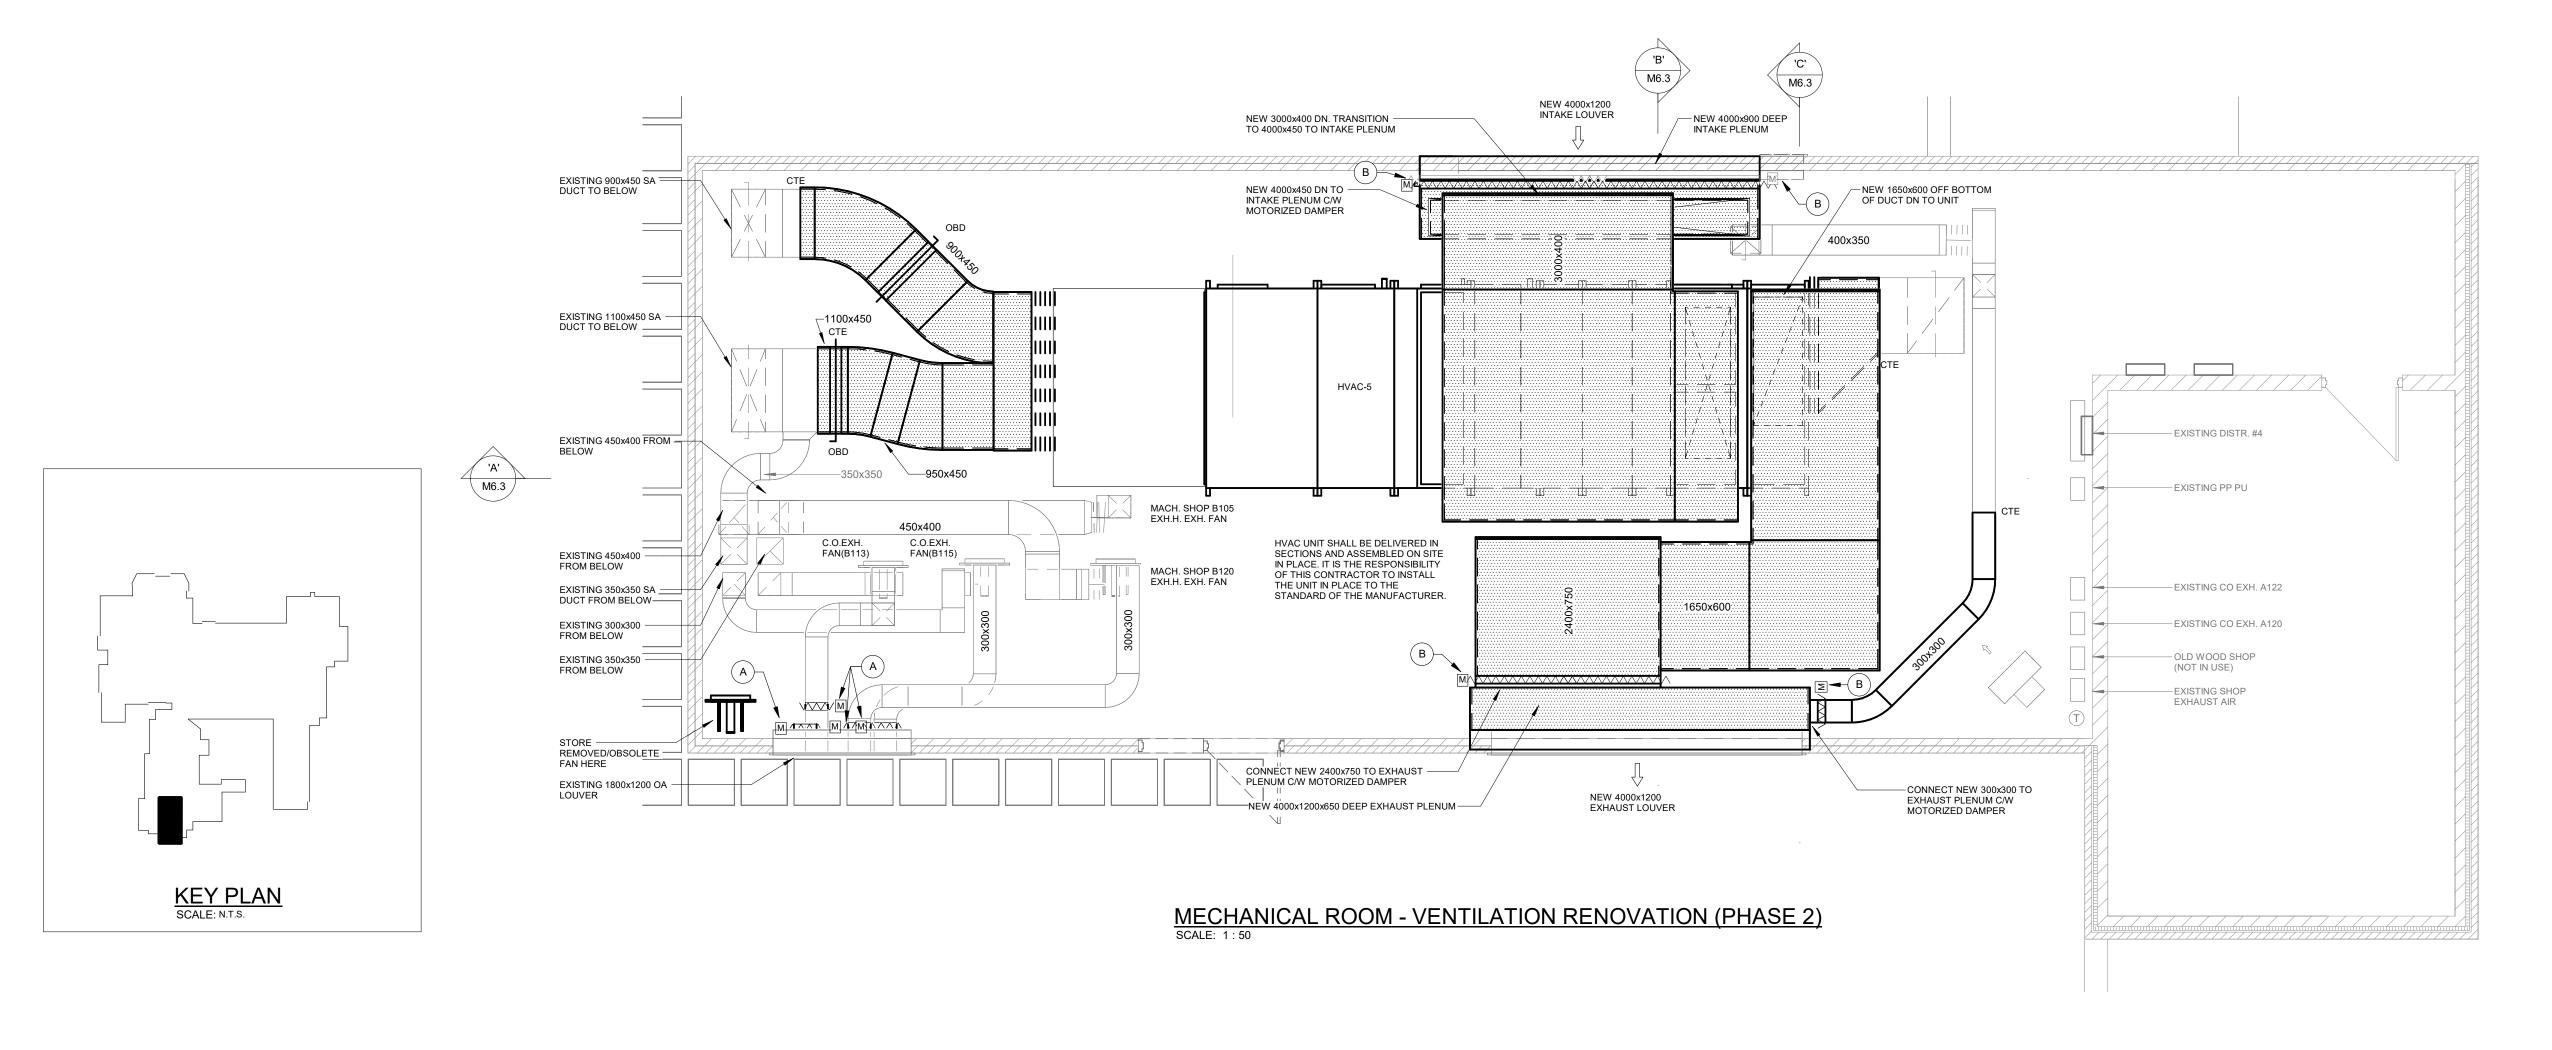

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1	ISSUED FOR 75% REVIEW	25.01.31
2	ISSUED FOR ADDENDUM 1	25.03.20
3	ISSUED FOR ADDENDUM 2	25.03.24
4	ISSUED FOR CONSTRUCTION	25.05.14





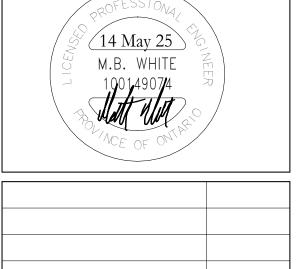

Consulting Engineers



PROJECT NAME

Glenview Park SS -Science/Elevator Reno

55 McKay St, Cambridge, ON N1R 4G8

DRAWING TITLE

PROJECT NUMBER 24162

MECH ROOM VENTILATION
DEMO/RENO (PHASE 2)


As indicated DRAWING NUMBER


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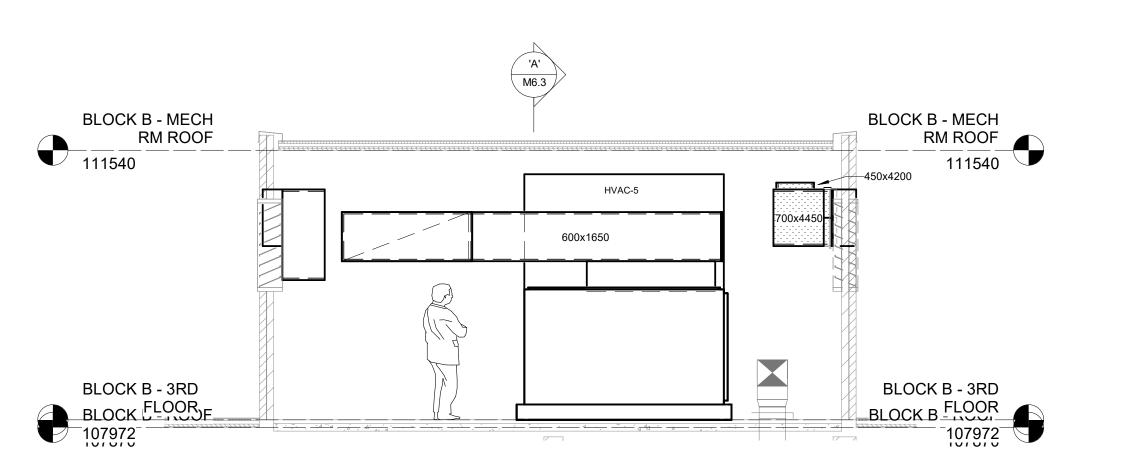
SHEET SIZE

_| M6.2

5-05-14 2:27:29 PM C:_Revit\24162 WRDSB Glenview Park SS Mech Central (RV)



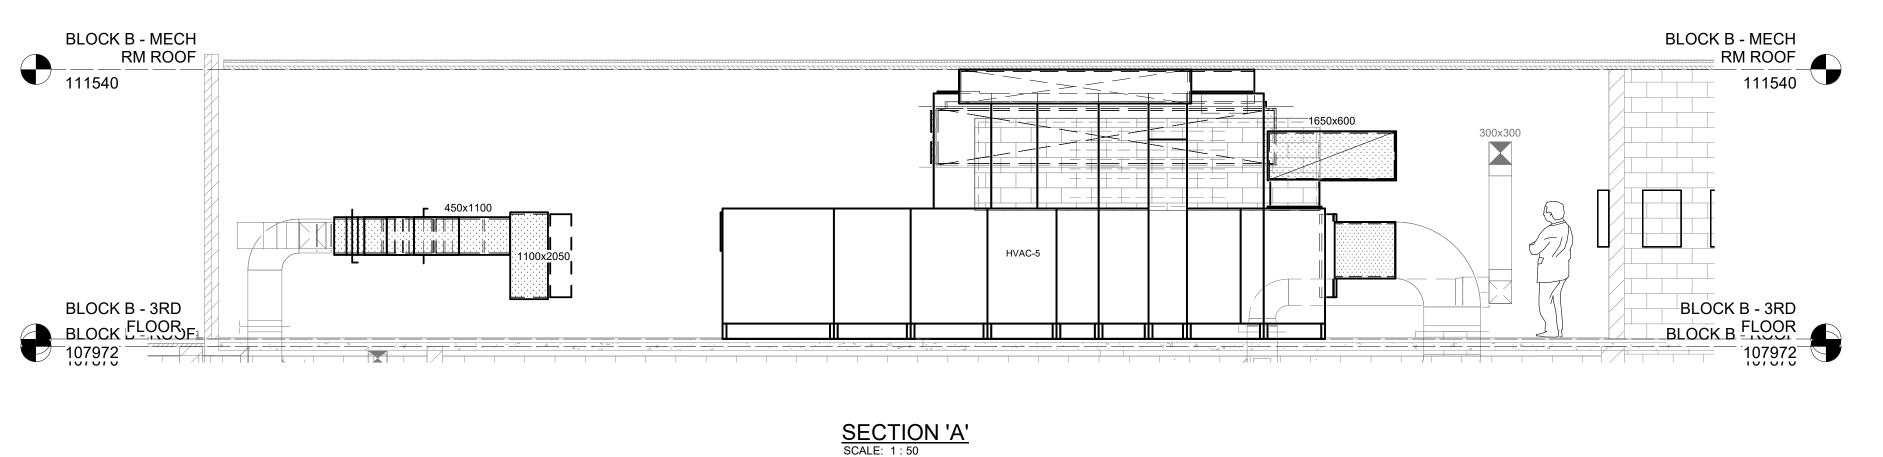

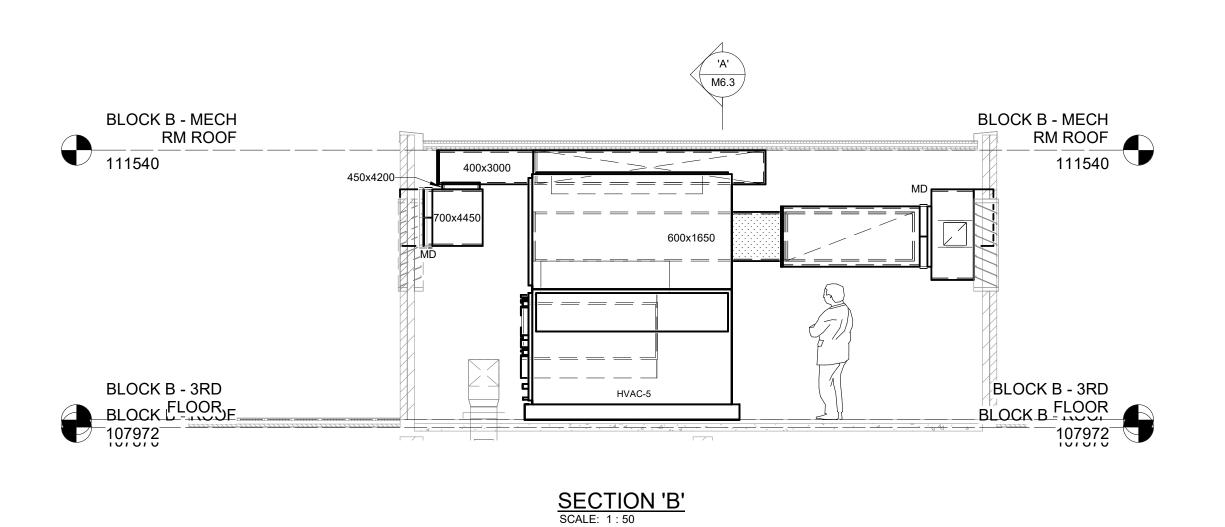

SECTION 'C'
SCALE: 1:50

The contractor shall verify all dimensions and report all errors and discrepancies to the Consultant before commencement of the work.

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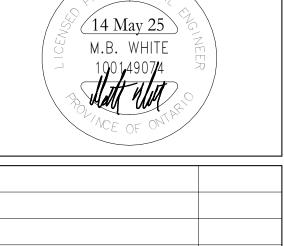
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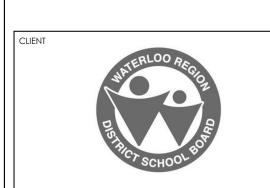
No.	REVISIONS	DATE
1	ISSUED FOR 75% REVIEW	25.01.31
4	ISSUED FOR CONSTRUCTION	25.05.14



CHRONOLOGY		DATE
PET	Water	rthland Road, loo, ON, N2V 1Y8







PROJECT NAME

Glenview Park SS -Science/Elevator Reno

55 McKay St, Cambridge, ON N1R 4G8

DRAWING TITLE

SECTIONS


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24X36


PROJECT NUMBER
24162

SHEET SIZE

M6.3

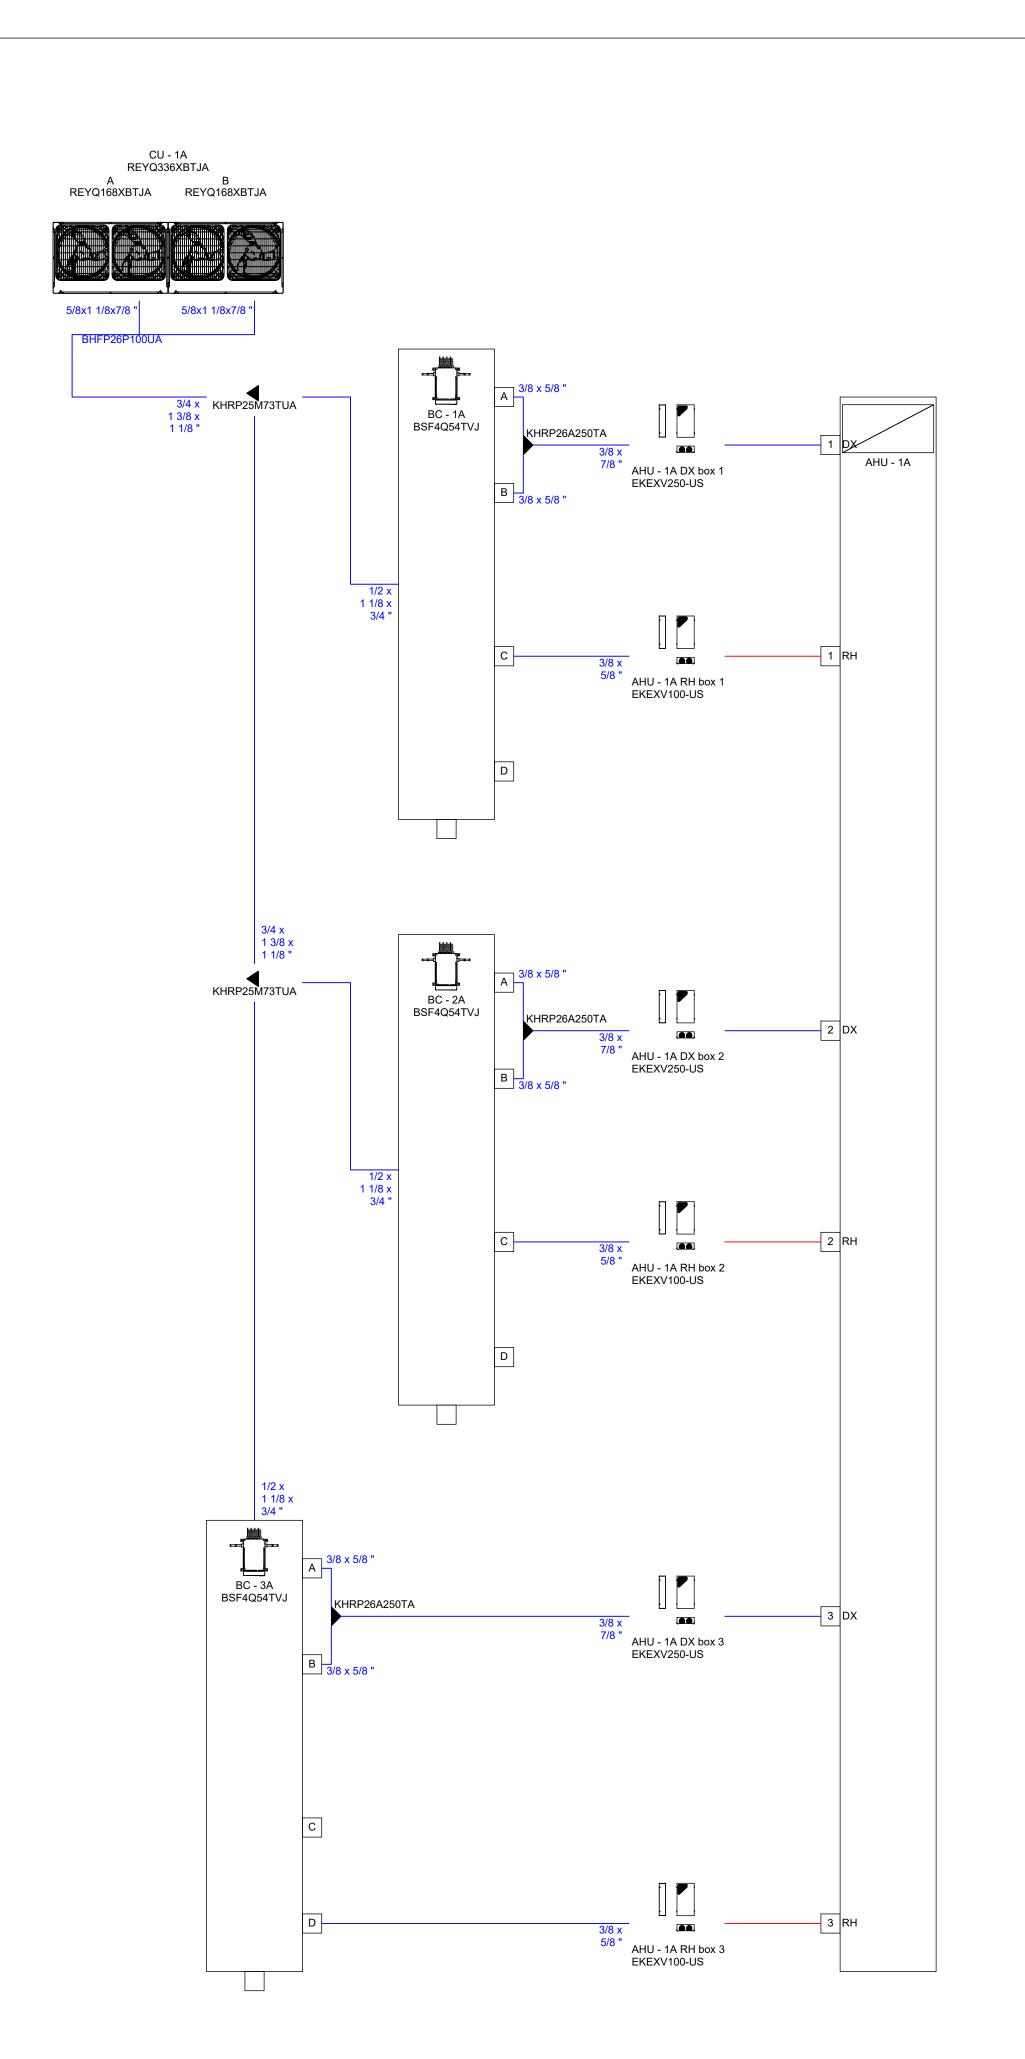

CU-1A PIPING SCHEMATIC

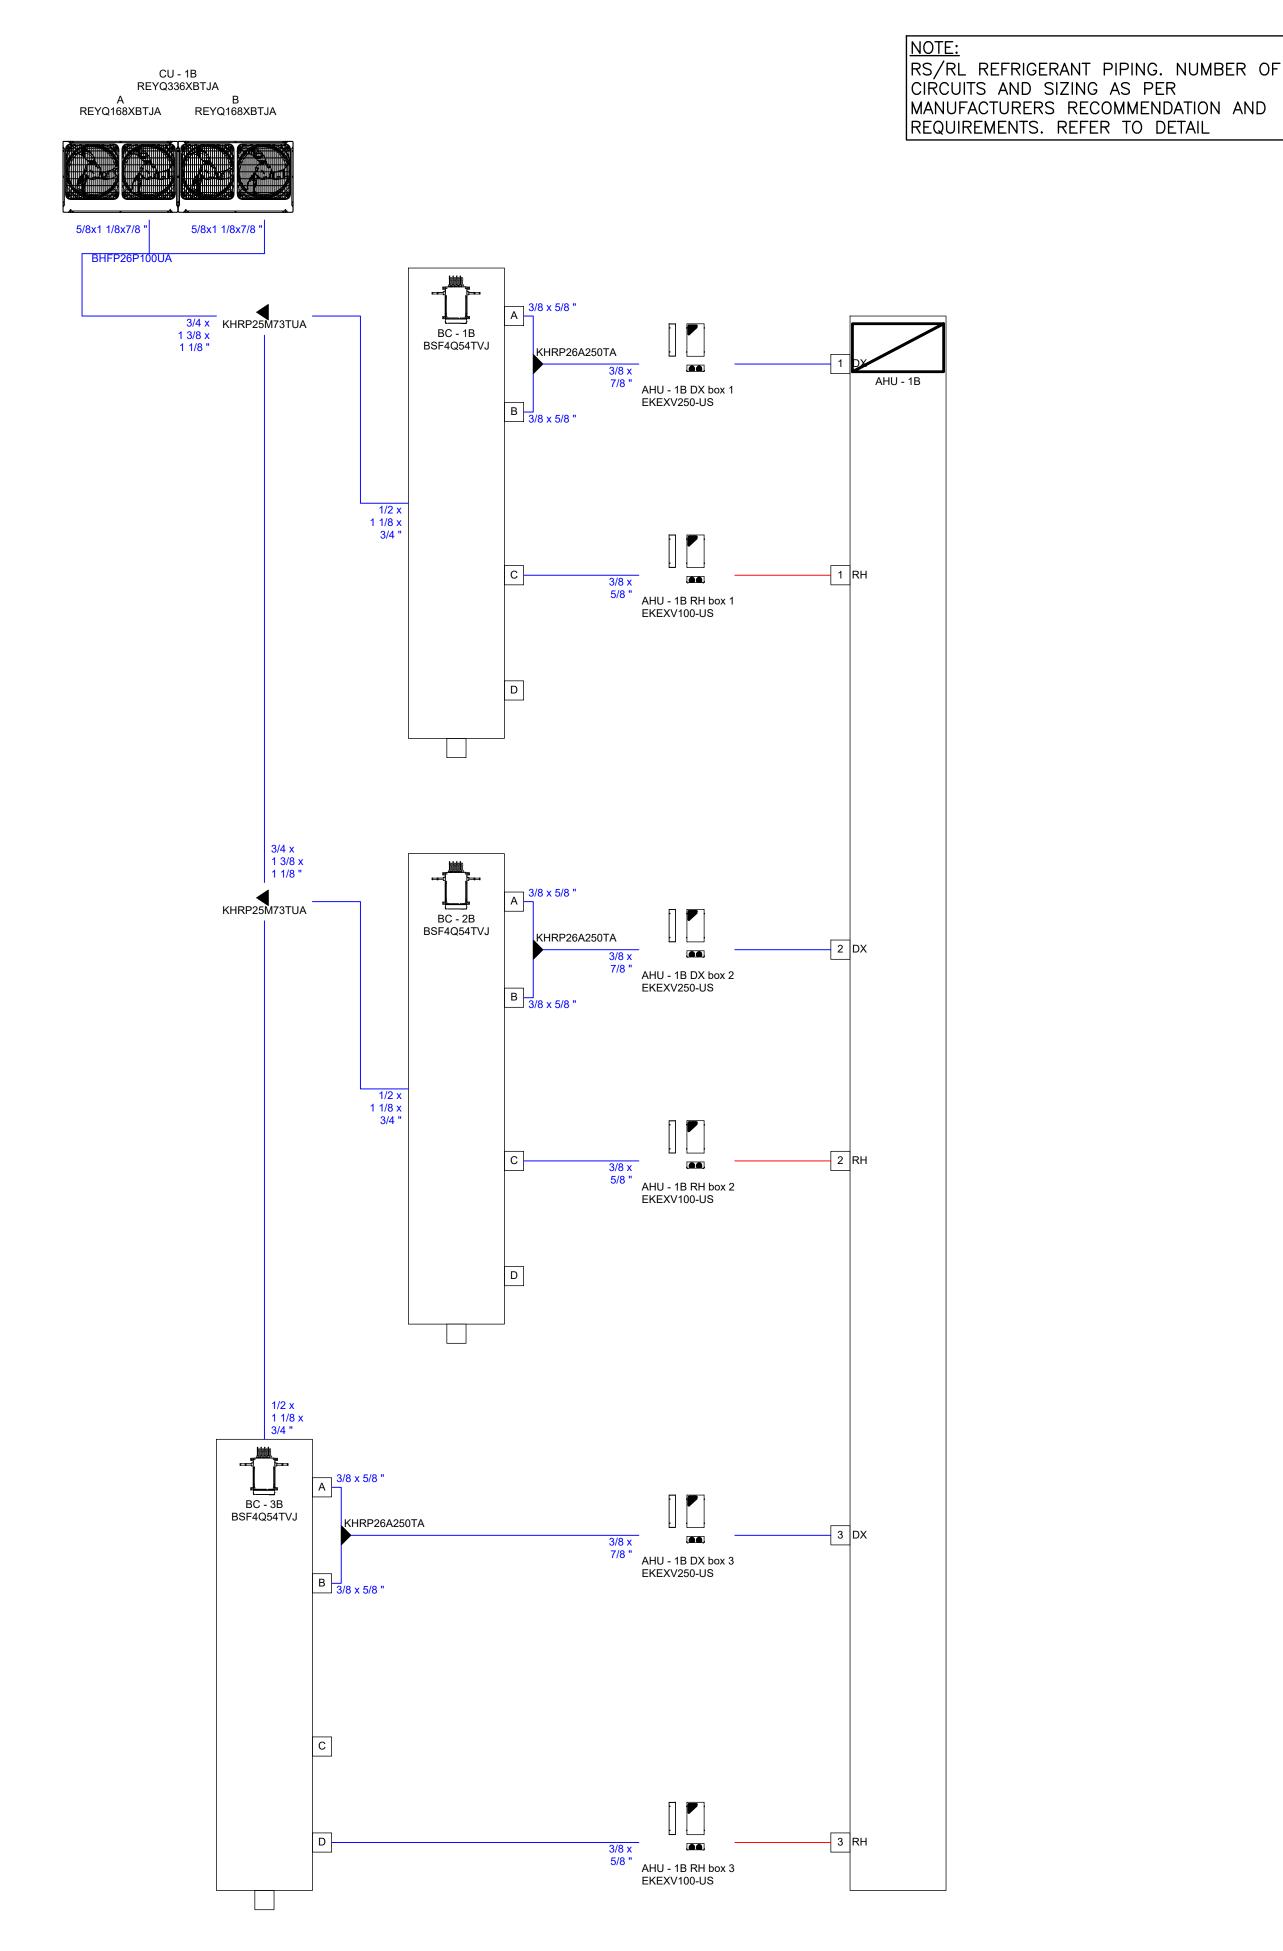


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Do not scale this drawing.


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REVISIONS	DATE
ISSUED FOR 75% REVIEW	2025.01.31
ISSUED FOR PERMIT & TENDER	2025.03.05
issued for construction	2025.05.14
	ISSUED FOR 75% REVIEW ISSUED FOR PERMIT & TENDER




CHRONOLOGY	DATE

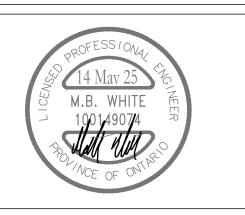

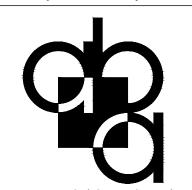

a b a a r c h i t e c t s i n c .

101 Randall Drive, Unit B, Waterloo ON. TEL 519 884 2711 www.abarchitect.ca

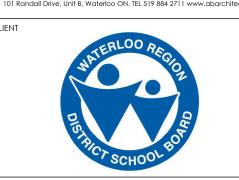

PROJECT NAME

GLENVIEW PARK
SECONDARY SCHOOL

55 McKay Street Cambridge, Ontario

DRAWING TITLE

PROJECT NUMBER

VRV/ VRF PIPING SCHEMATICS


SCALE
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SHEET SIZE
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DRAWING NUMBER

AS NOTED

CU-1B PIPING SCHEMATIC




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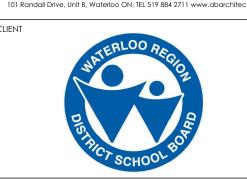
CHRONOLOGY	DATE

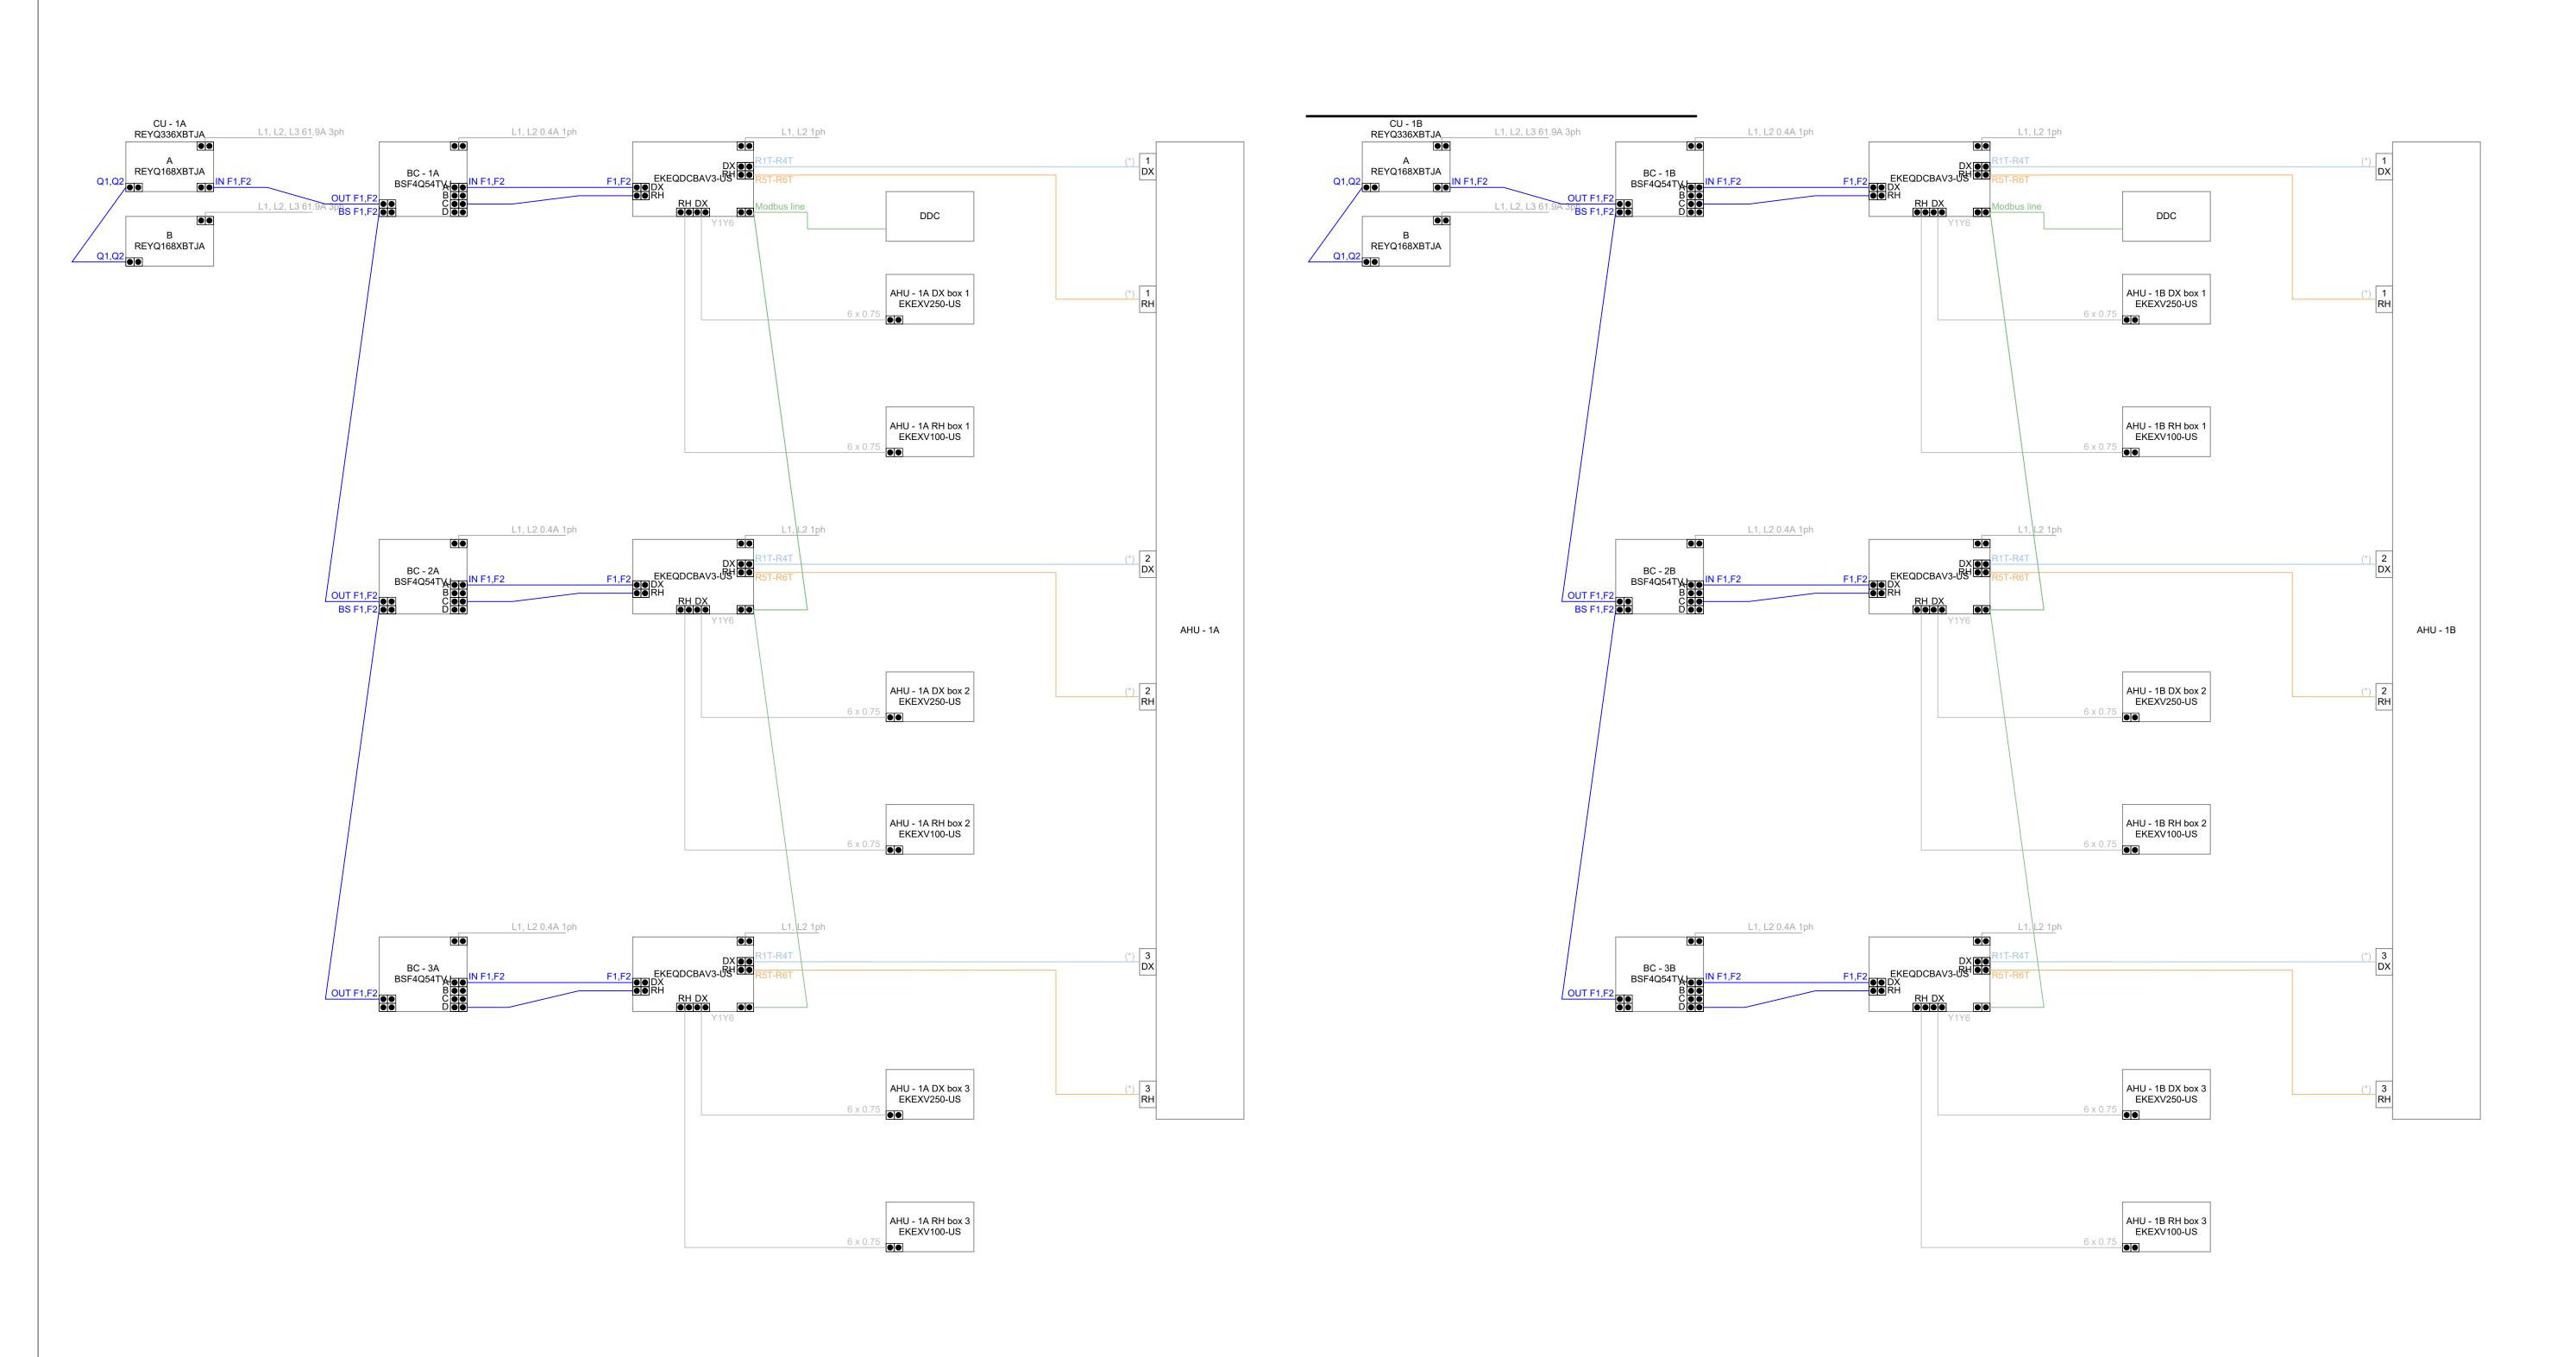



a b a a r c h i t e c t s i n c .
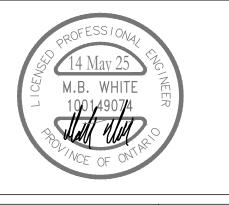
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PROJECT NAME

GLENVIEW PARK
SECONDARY SCHOOL
55 McKay Street Cambridge, Ontario

DRAWING TITLE


VRV/ VRF WIRING SCHEMATICS


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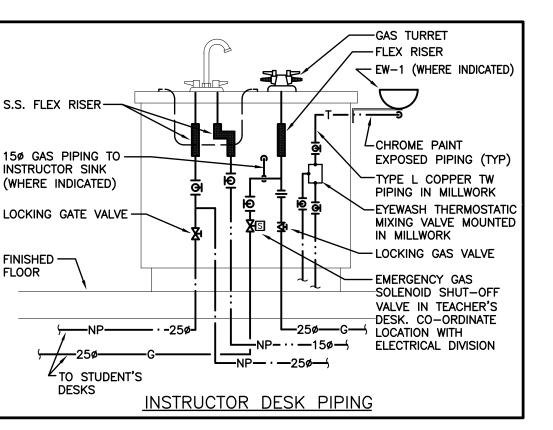
SHEET SIZE
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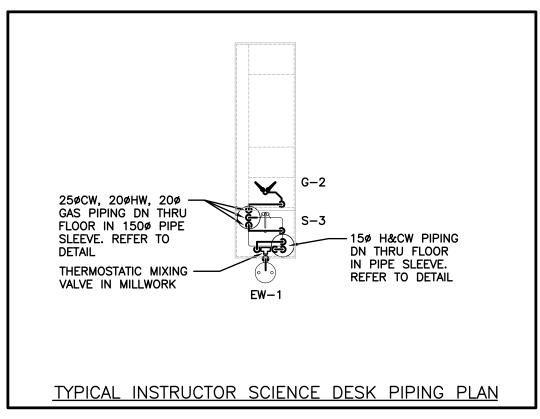
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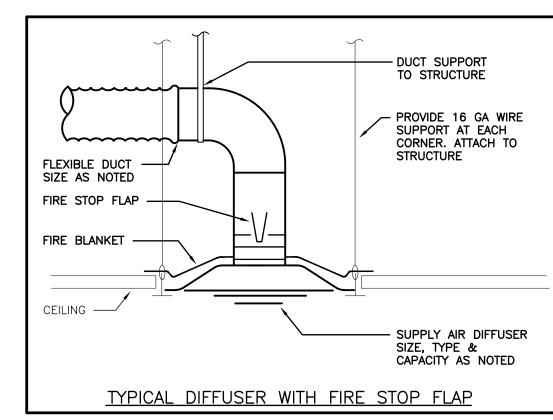
CU-1A WIRING SCHEMATIC










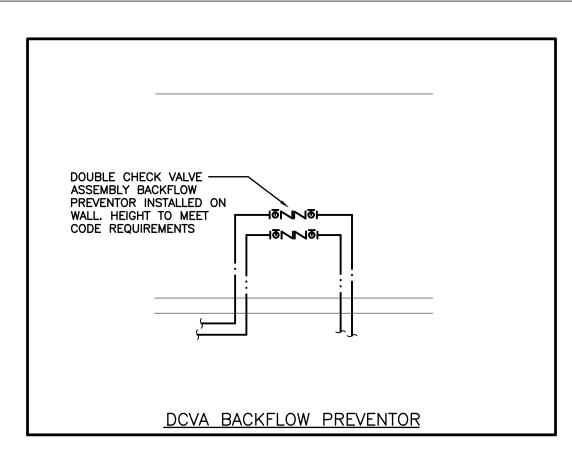


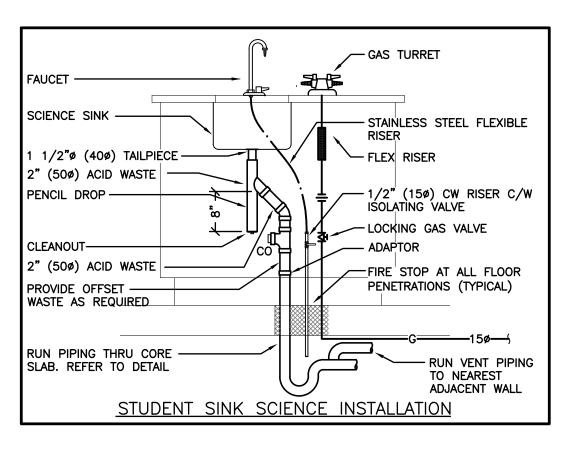

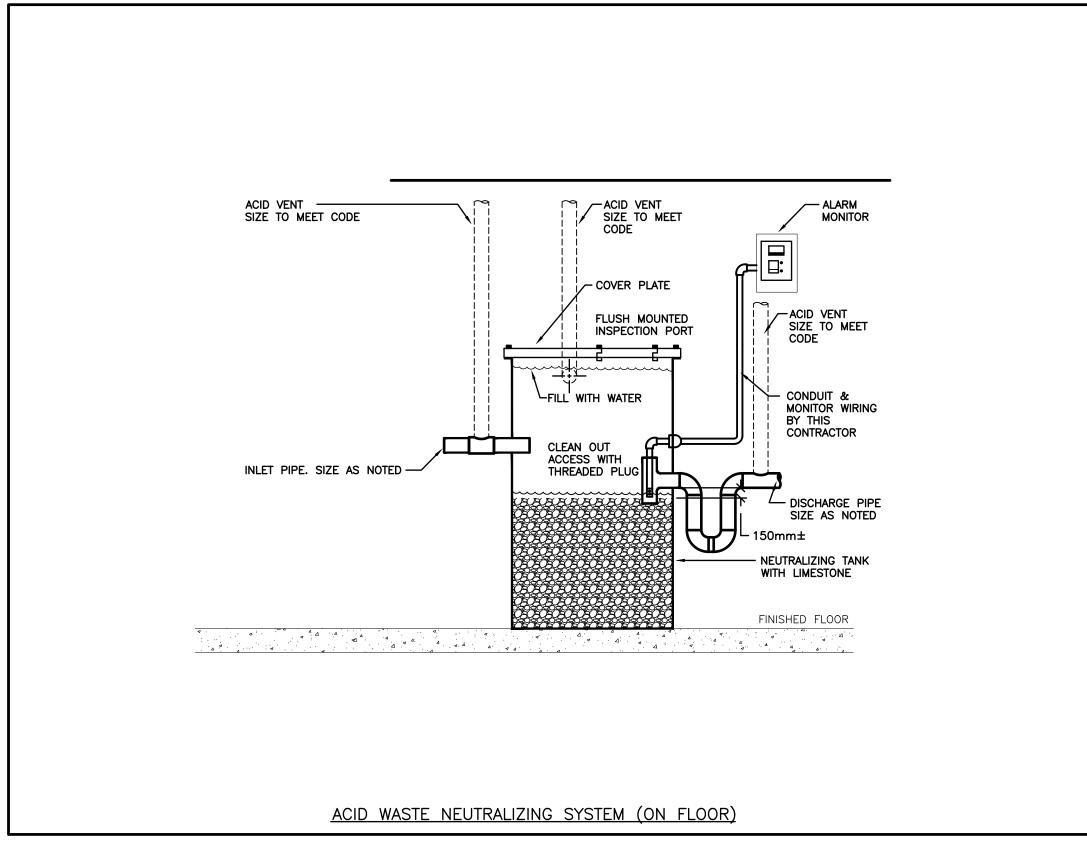


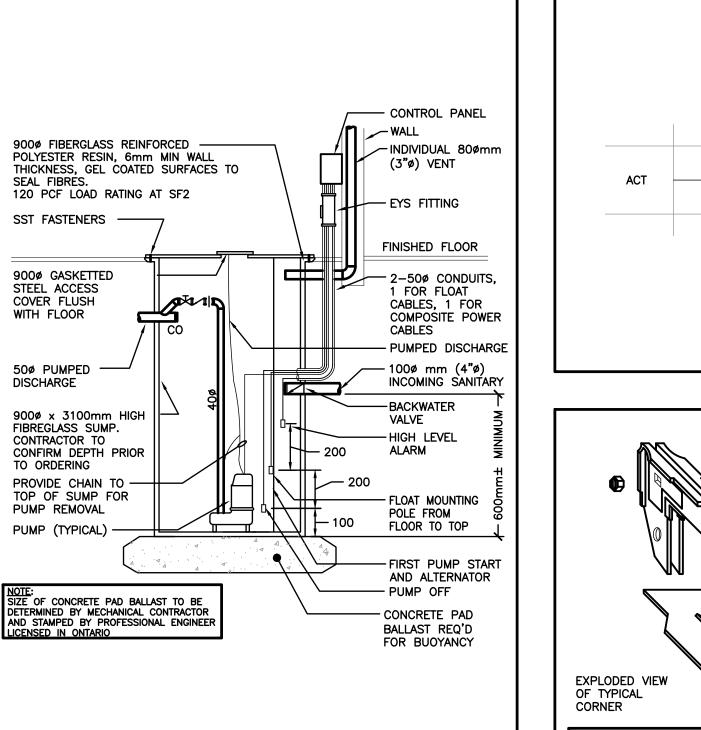


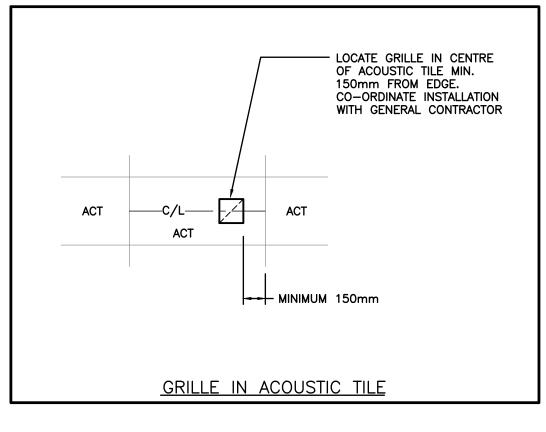


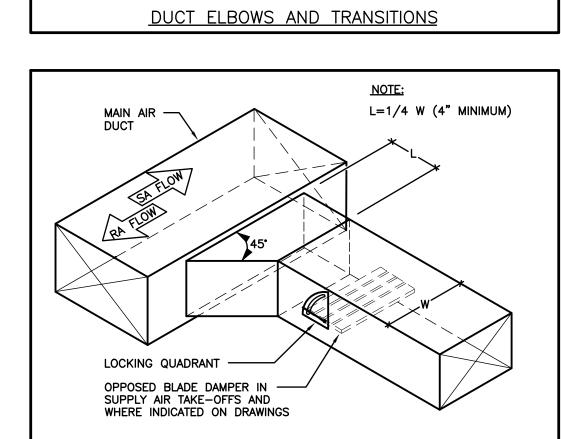


SQUARE DUCT BRANCH TAKEOFF

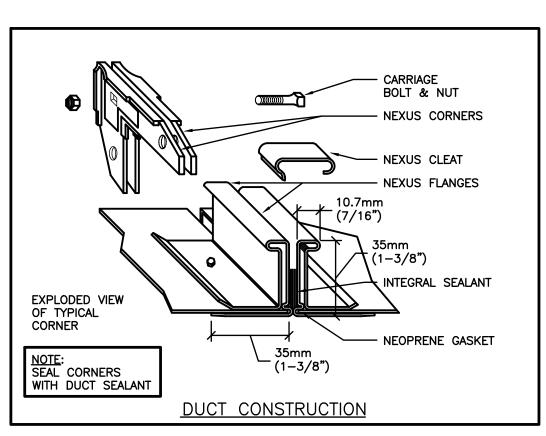

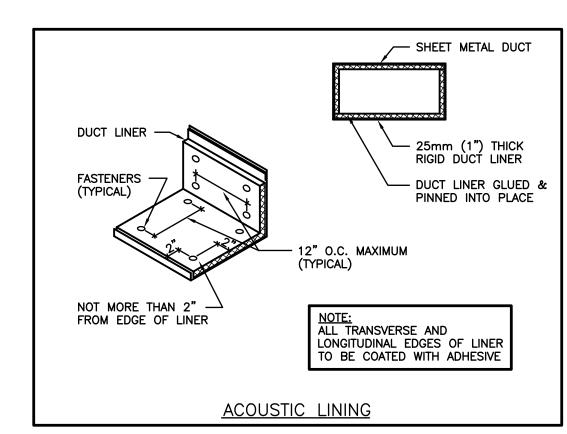

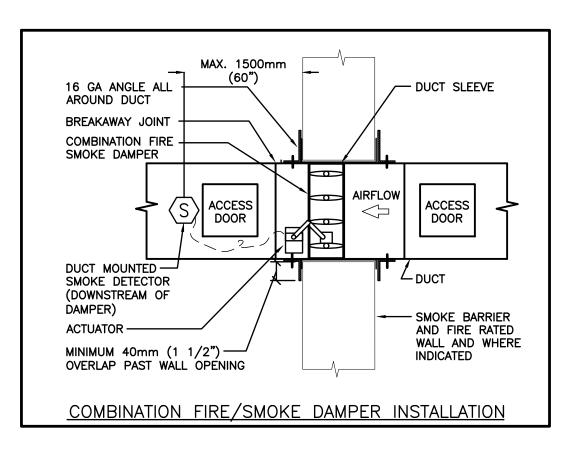


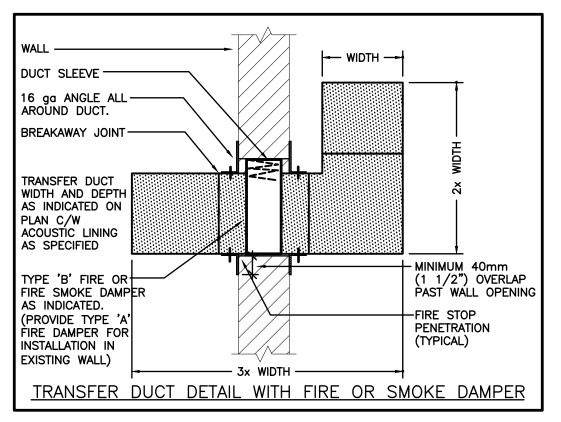


IN ALL STUDENT/INSTRUCTOR DESKS, ENSURE MILLWORK IS EQUIPPED WITH REMOVABLE


SECTIONS TO ALLOW ACCESS TO GAS PIPING


FOR FUTURE INSPECTION/MAINTENANCE.

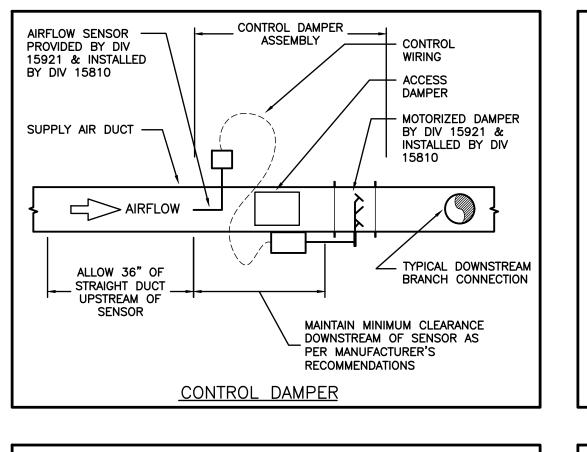


ELEVATOR SANITARY SIMPLEX SUMP & PUMP DETAIL

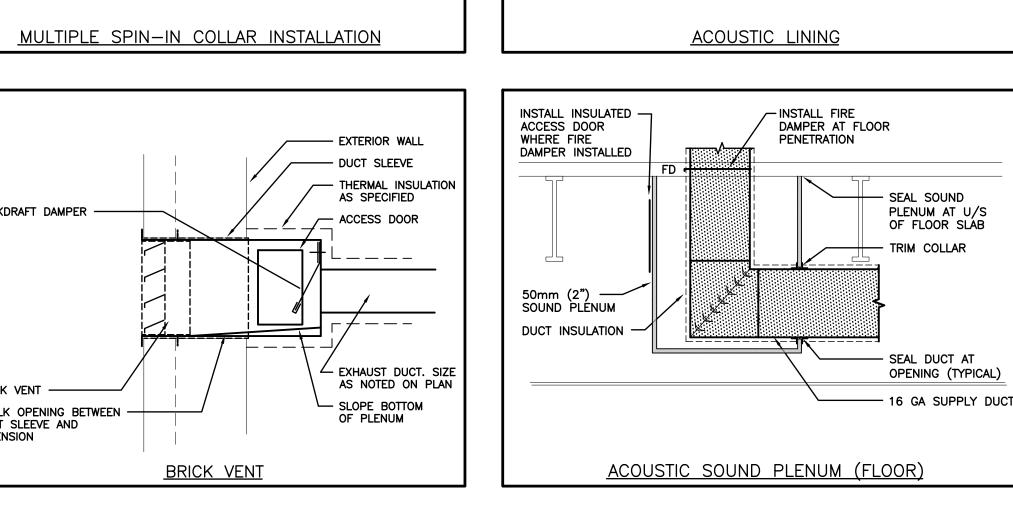

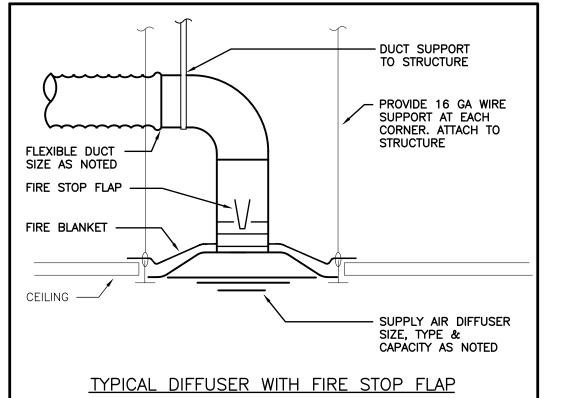

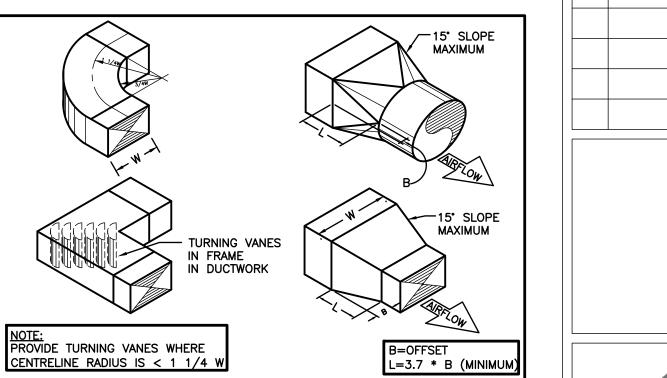

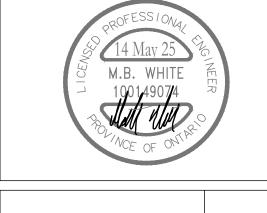

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meet the required conditions. Drawings and specifications, etc., prepared and issued by

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DATE

2025.01.31

2025.03.05

2025.05.14

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ISSUED FOR 75% REVIEW

ISSUED FOR PERMIT & TENDER

ISSUED FOR CONSTRUCTION


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No. REVISIONS

consultant and must be returned at the

CHRONOLOGY	DATE





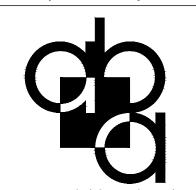



PROJECT NAME


GLENVIEW PARK SECONDARY SCHOOL 55 McKay Street Cambridge, Ontario


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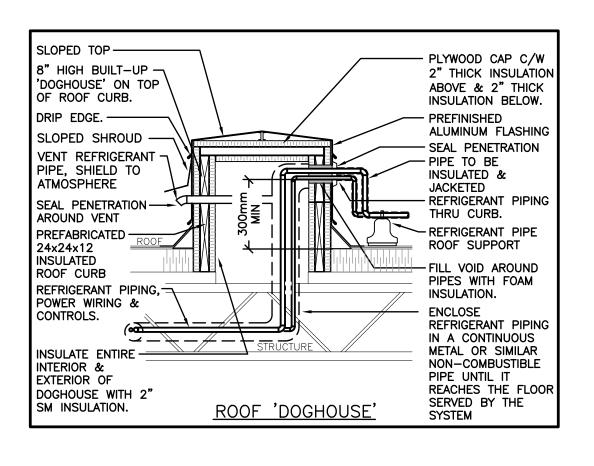
PROJECT NUMBER


DETAILS (PHASE 1)


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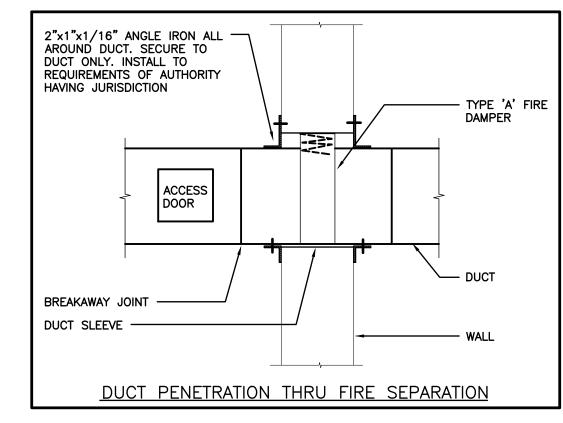





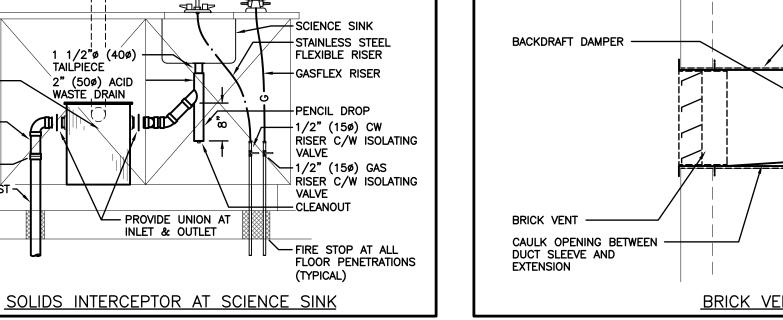


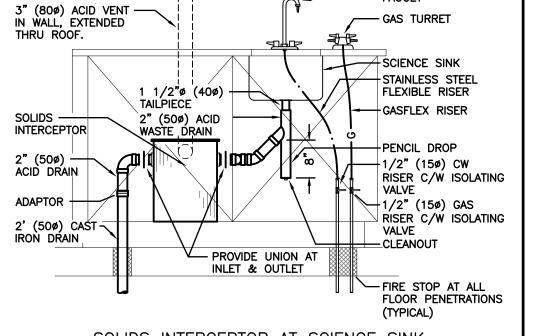


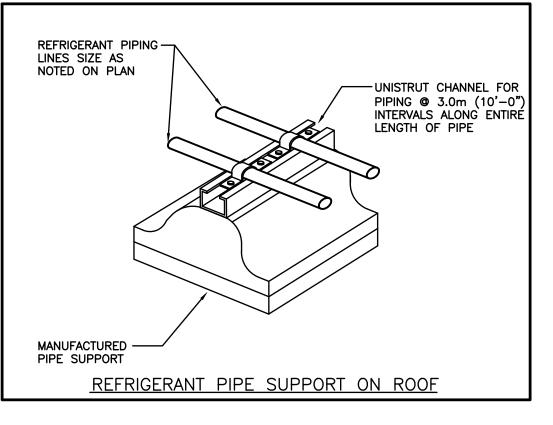

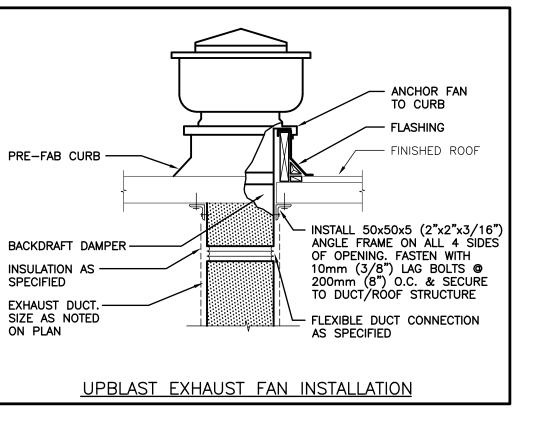

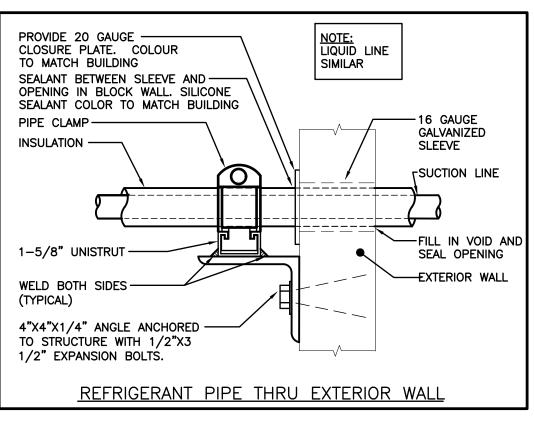


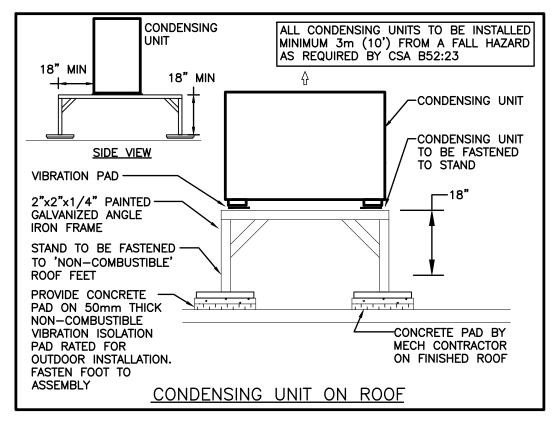


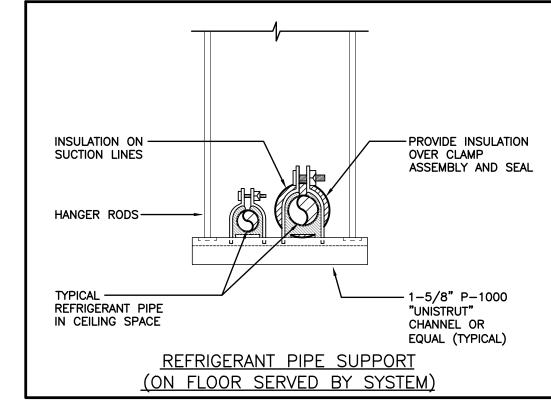


(PHASE 2)

(PHASE 1)

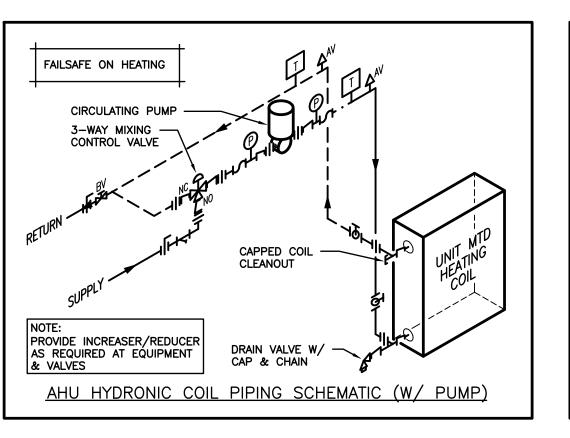

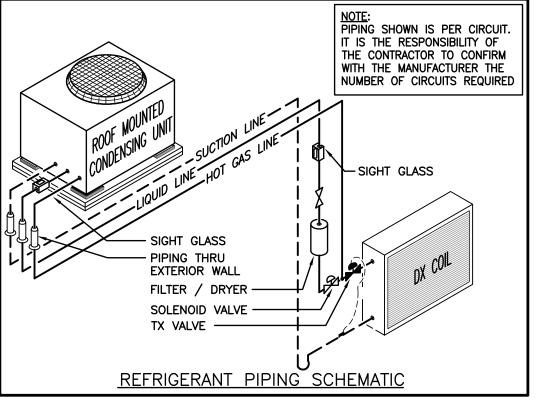


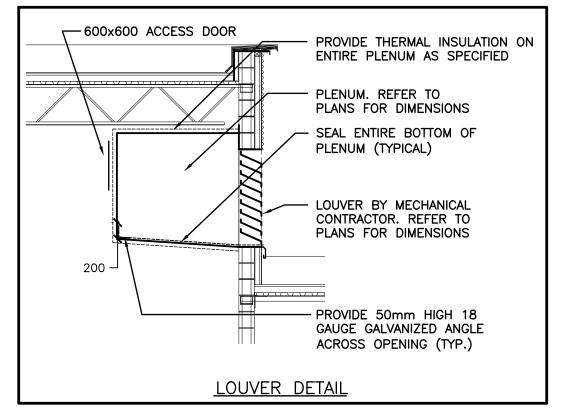


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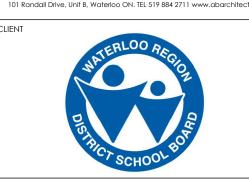






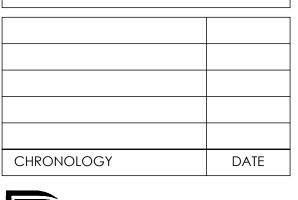

aba architects inc.

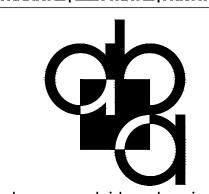

PROJECT NAME

GLENVIEW PARK
SECONDARY SCHOOL
55 McKay Street Cambridge, Ontario

DRAWING TITLE

DETAILS (PHASE 1 & PHASE 2)

AS NOTED

ET SIZE

24x36

DRAWING NUMBER

7