


FIRM NAME: WORKSHOP Architecture 6 Sousa Mendes St Toronto, ON M6P 0A8 tel. 416-901-8055		LOCATION: 85 Sunset Blvd, Cambridge, ON, N1S 1A9		OBO REFERENCE  References are to Division B unless noted [A] for Division A or [C] for Division C.
NAME OF PROJECT: Blair Road Public School Parking Lot Expansion		Project Area: 2380 m²		
ONTARIO'S 2012 BUILDING CODE DATA MATRIX - PART 11				
11.00	Building Code Version: O. Reg. 332/12			[A] 11.2.6
11.01	Project Type:	<input type="checkbox"/> Addition <input type="checkbox"/> Change of use <input type="checkbox"/> Addition and reno. <input type="checkbox"/> Renovation <input checked="" type="checkbox"/> Exterior work		
11.02	Major Occupancy Classification:	Occupancy: <u>Group A, Div. 2</u>	Use: <u>School</u>	
11.03	Superimposed Major Classification:	<input checked="" type="checkbox"/> No <input type="checkbox"/> Yes	Description: _____	
11.04	Building Area (m²)	Existing: _____	New: _____ Total: NO CHANGE	
11.05	Gross Area (m²)	Existing: _____	New: _____ Total: NO CHANGE	
11.06	Mezzanine Area (m²)	Existing: _____	New: _____ Total: NO CHANGE	
11.07	Building Height	Storeys above grade: 1 Storeys below grade: 0	NO CHANGE (m) Above grade: 7.00m	
11.08	Building Size	<input type="checkbox"/> Small <input type="checkbox"/> Medium <input checked="" type="checkbox"/> Large <input type="checkbox"/> > Large		
11.09	Number of Streets	streets (s): 1 street		
11.10	Existing Building Classification:	Change in Major Occupancy: <input type="checkbox"/> Yes <input checked="" type="checkbox"/> Not Applicable (no change of major occupancy)		
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<u>Zoning Summary</u>		Existing	Required/Permitted	Proposed
Use		Elementary School	Elementary School	Unchanged
Parking Spaces	32		12 (for 12 classrooms, not incl. portables)	44
Landscaped Open Area	73%		30% min	70%

① Context Plan  
1 : 1000



② Proposed Site Plan  
1 : 500

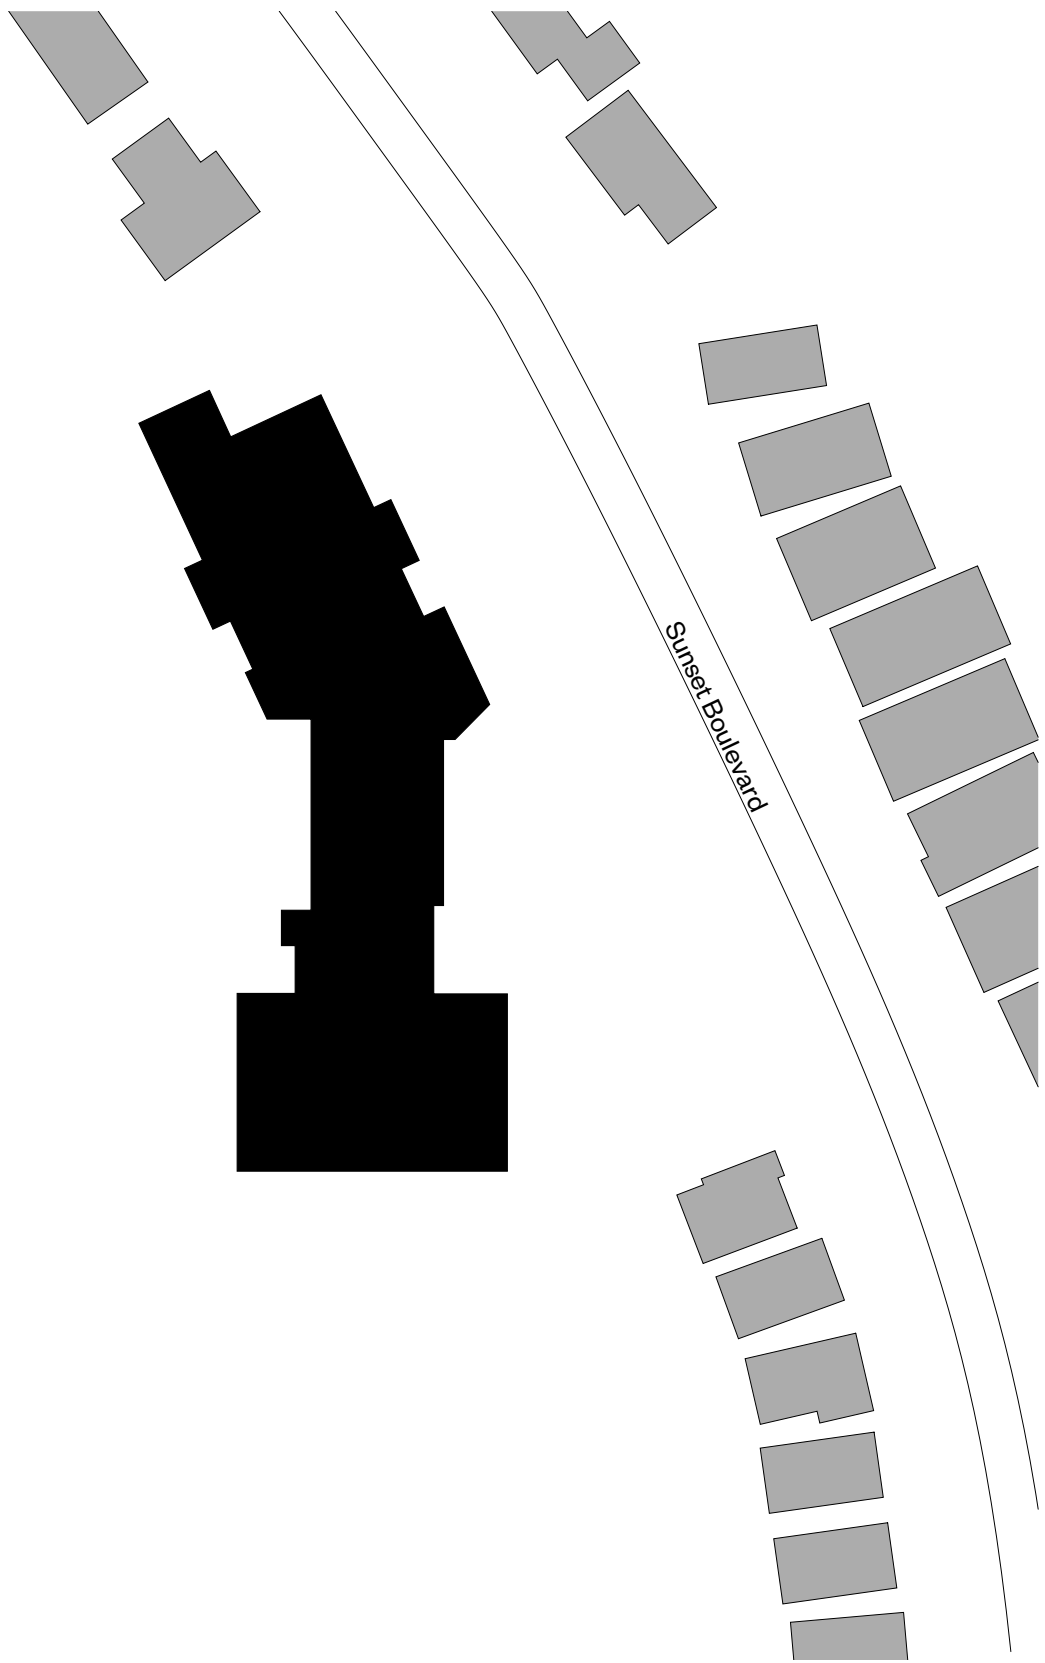

#### General Notes:

1. Drawings are to be read in conjunction with project specifications.
2. Make good all surfaces/areas/finishes damaged during demolition. Prepare existing surfaces to accept new finishes as scheduled/specified.
3. All dimensions are to face of partition unless noted otherwise.
4. Angles are 90 degrees unless noted otherwise.
5. Site access, including working hours, for material delivery, work forces and for refuse removal is to be coordinated with the Owner, as per terms outline in Division 01 General Requirements.
6. General Contractor is to co-ordinate and co-operate with trades retained directly by Owner as applicable.
7. General Contractor shall be responsible for scheduling the trades identified in item 6, where such work affects the progress of the job.
8. Any temporary shoring required, including excavation support systems, shall be coordinated and provided by General Contractor within bid price. Refer also to Structural drawings, details and specification for additional requirements.
9. Building Permit shall be obtained by Owner. All other permits/fees (including but not limited to ESA, Municipal road closure permits, service connection fees, sign permits, etc) to be obtained by the Contractor as necessary to complete the Work. All costs for these permits (Municipal Inspections, traffic direction costs, etc) shall be included in bid price and provided at no additional cost to the Owner.
10. Reinstatement of any adjacent paving/sidewalks/roadways/asphalt within the Municipal Right of Way or adjacent properties disturbed during construction to be carried out according to applicable Municipal Standards. Refer also to Landscape/Civil drawings.

Sheet List	
Sheet Number	Sheet Name
ARCHITECTURAL	
A0.0	OBC Matrix, General Notes, & Context Plan
A1.0	Demolition & Proposed Plans
A2.0	Exterior Elevations & Sections
A3.0	Stair and Guardrail Details
STRUCTURAL	
S0.00	General Notes & Key Plan
S1.00	Foundation Plans & Sections
CIVIL	
C0.00	General Notes
C0.01	Typical Details
C1.00	Site Grading Plan
C2.00	Site Servicing Plan
C3.00	Sediment & Erosion Control Plan
CULTEC 1	Cover Sheet
CULTEC 2	System Layout Sheet
CULTEC 3	System Calculation Sheet
CULTEC 4	System Overlay Sheet
CULTEC 5	150XLHD Detail Sheet
LANDSCAPE	
TPP-1	Tree Preservation Plan
TPP-2	Tree Preservation Notes and Details

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Rev	Description	Date
1	Issued for SD Report	10 Mar 2025
3	Permit/Tender	17 April 2025
4	Issued for Addendum 1	08 May 2025
5	Issued for Construction	09 June 2025

#### Site Plan Legend

- Extent of new asphalt
- Extent of new concrete
- Extent of grass/sod
- Fire route
- Entrance
- Chain link fence
- Catch basin
- Tree (existing)
- Crossway painting



## WORKSHOP


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workshopto.ca

### Blair Road Public School Parking Lot Expansion

85 Sunset Blvd, Cambridge, ON, N1S 1A9

PROJECT CODE:	SCALE:
2430	As indicated
DATE:	STATUS:
June 2025	Construction


#### OBC Matrix, General Notes, & Context Plan

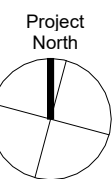


drawing number

A0.0



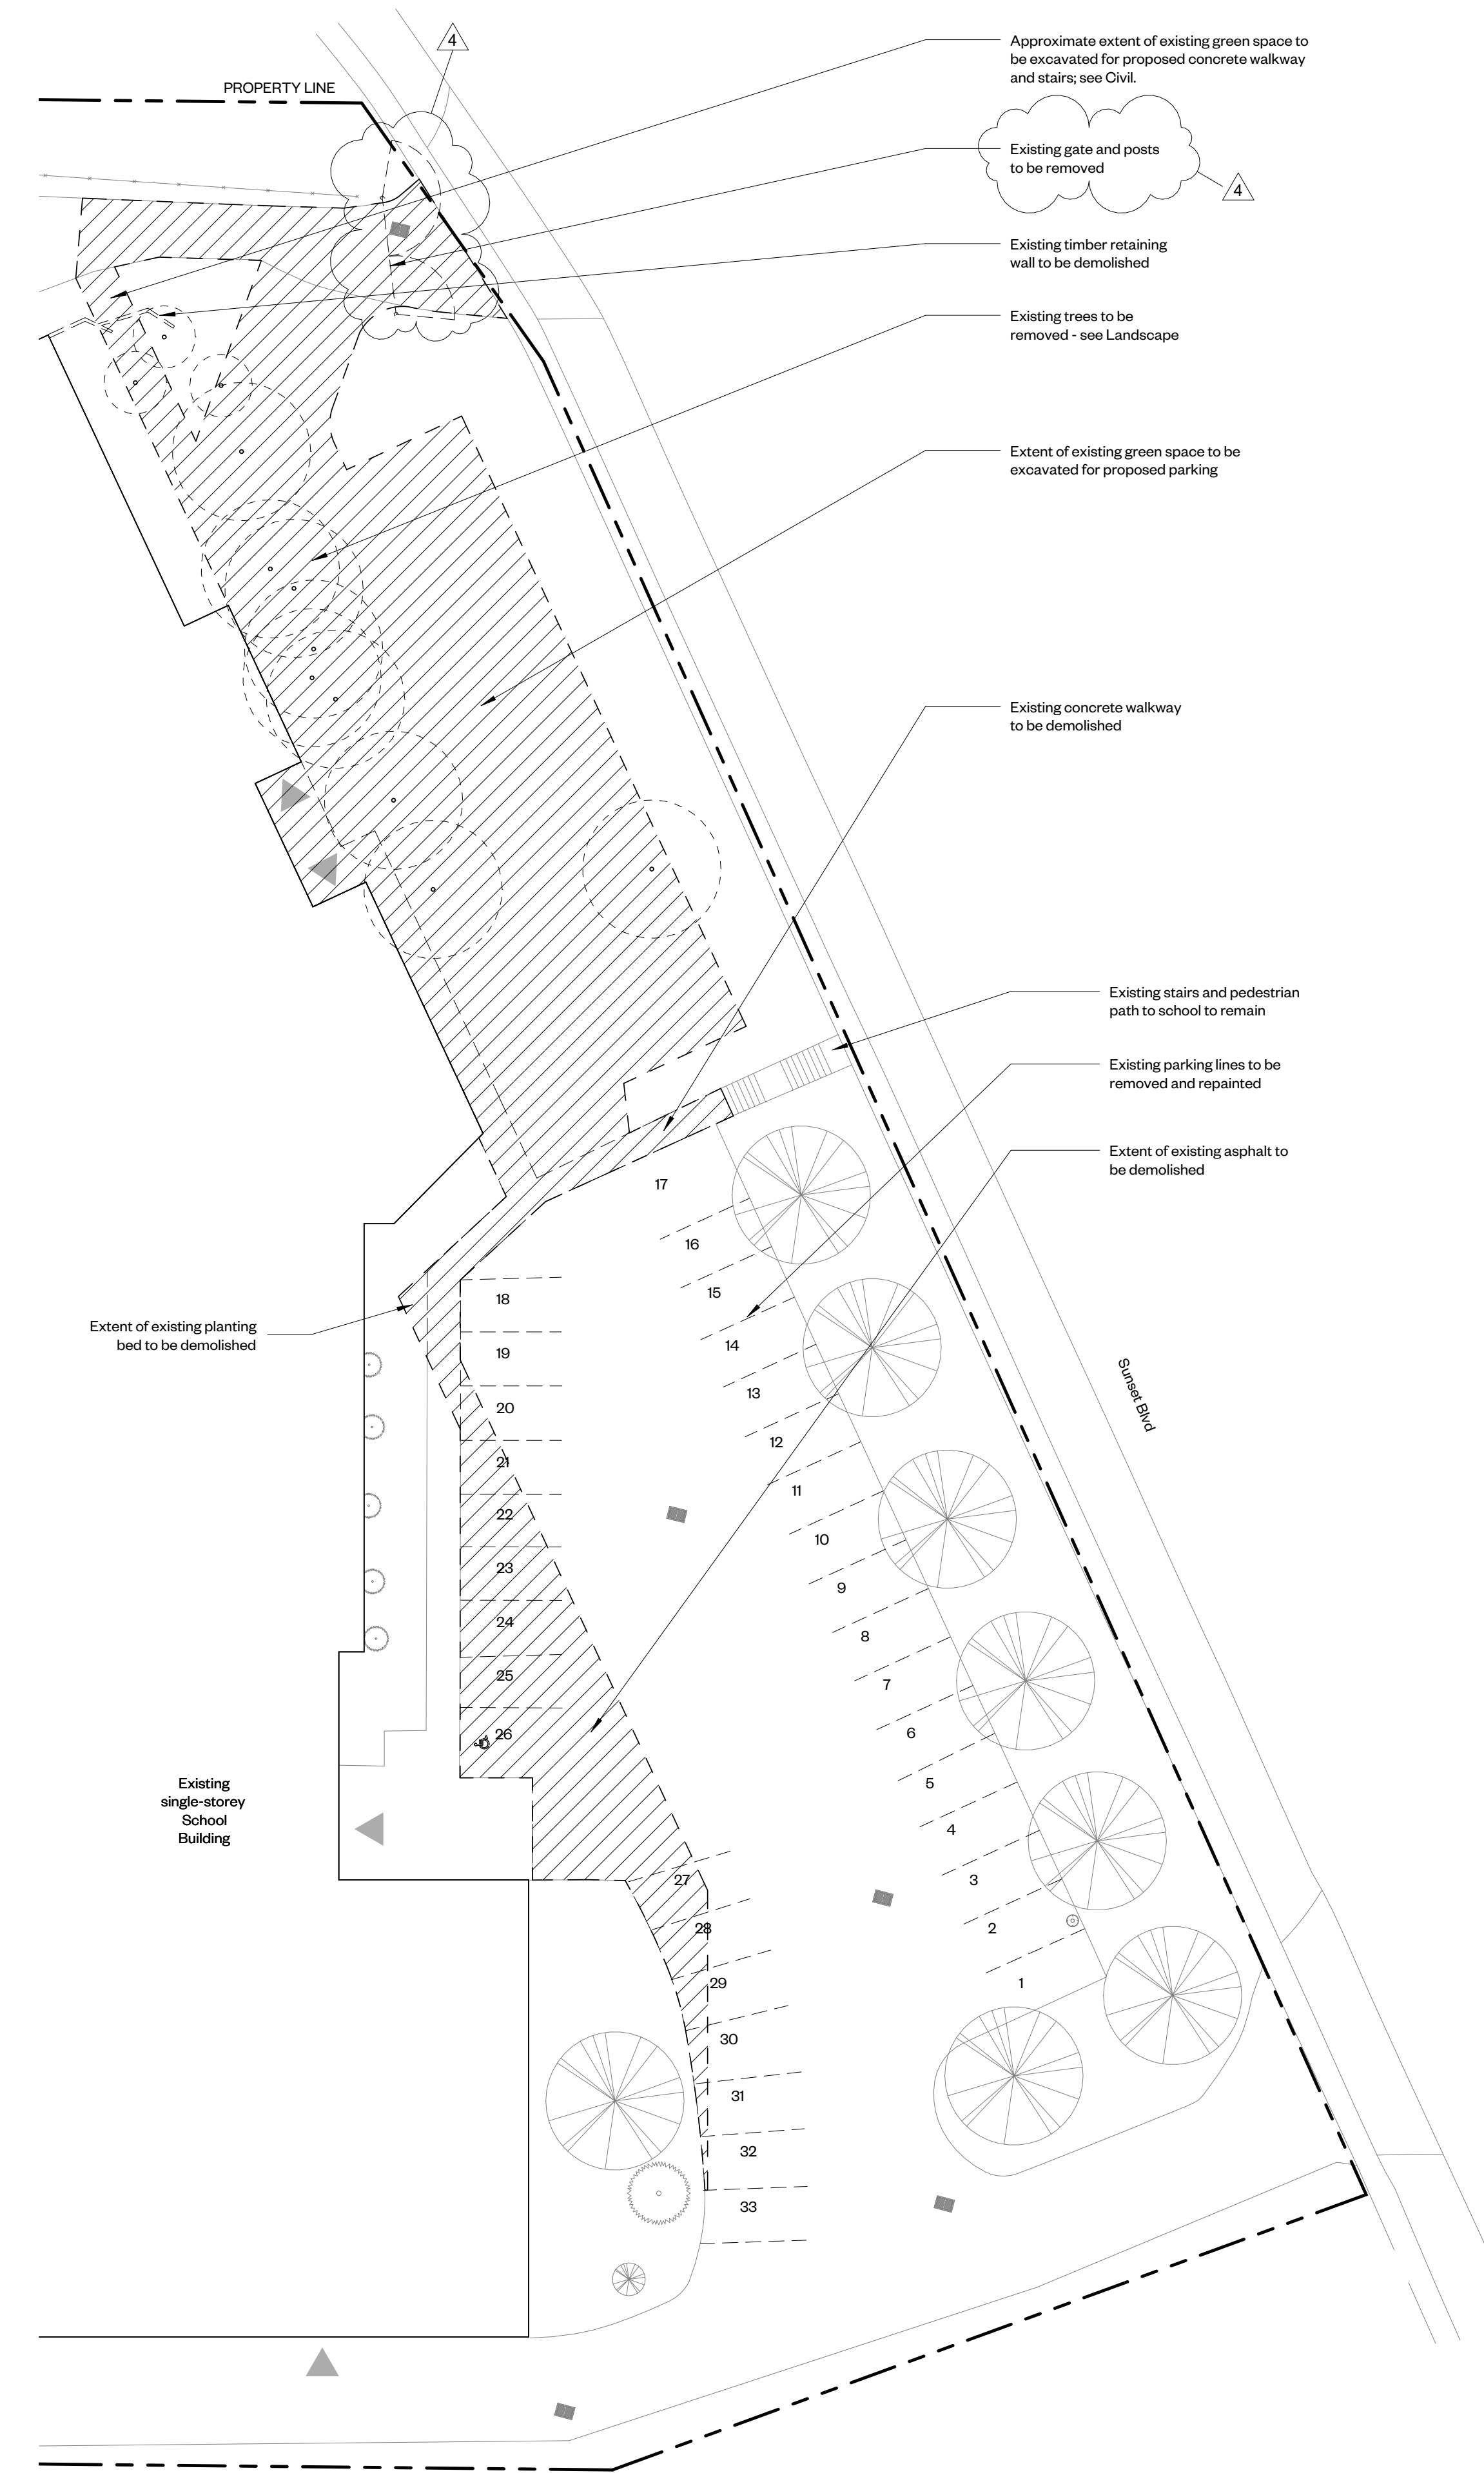

① Site Plan Partial - Demolition  
1 : 250

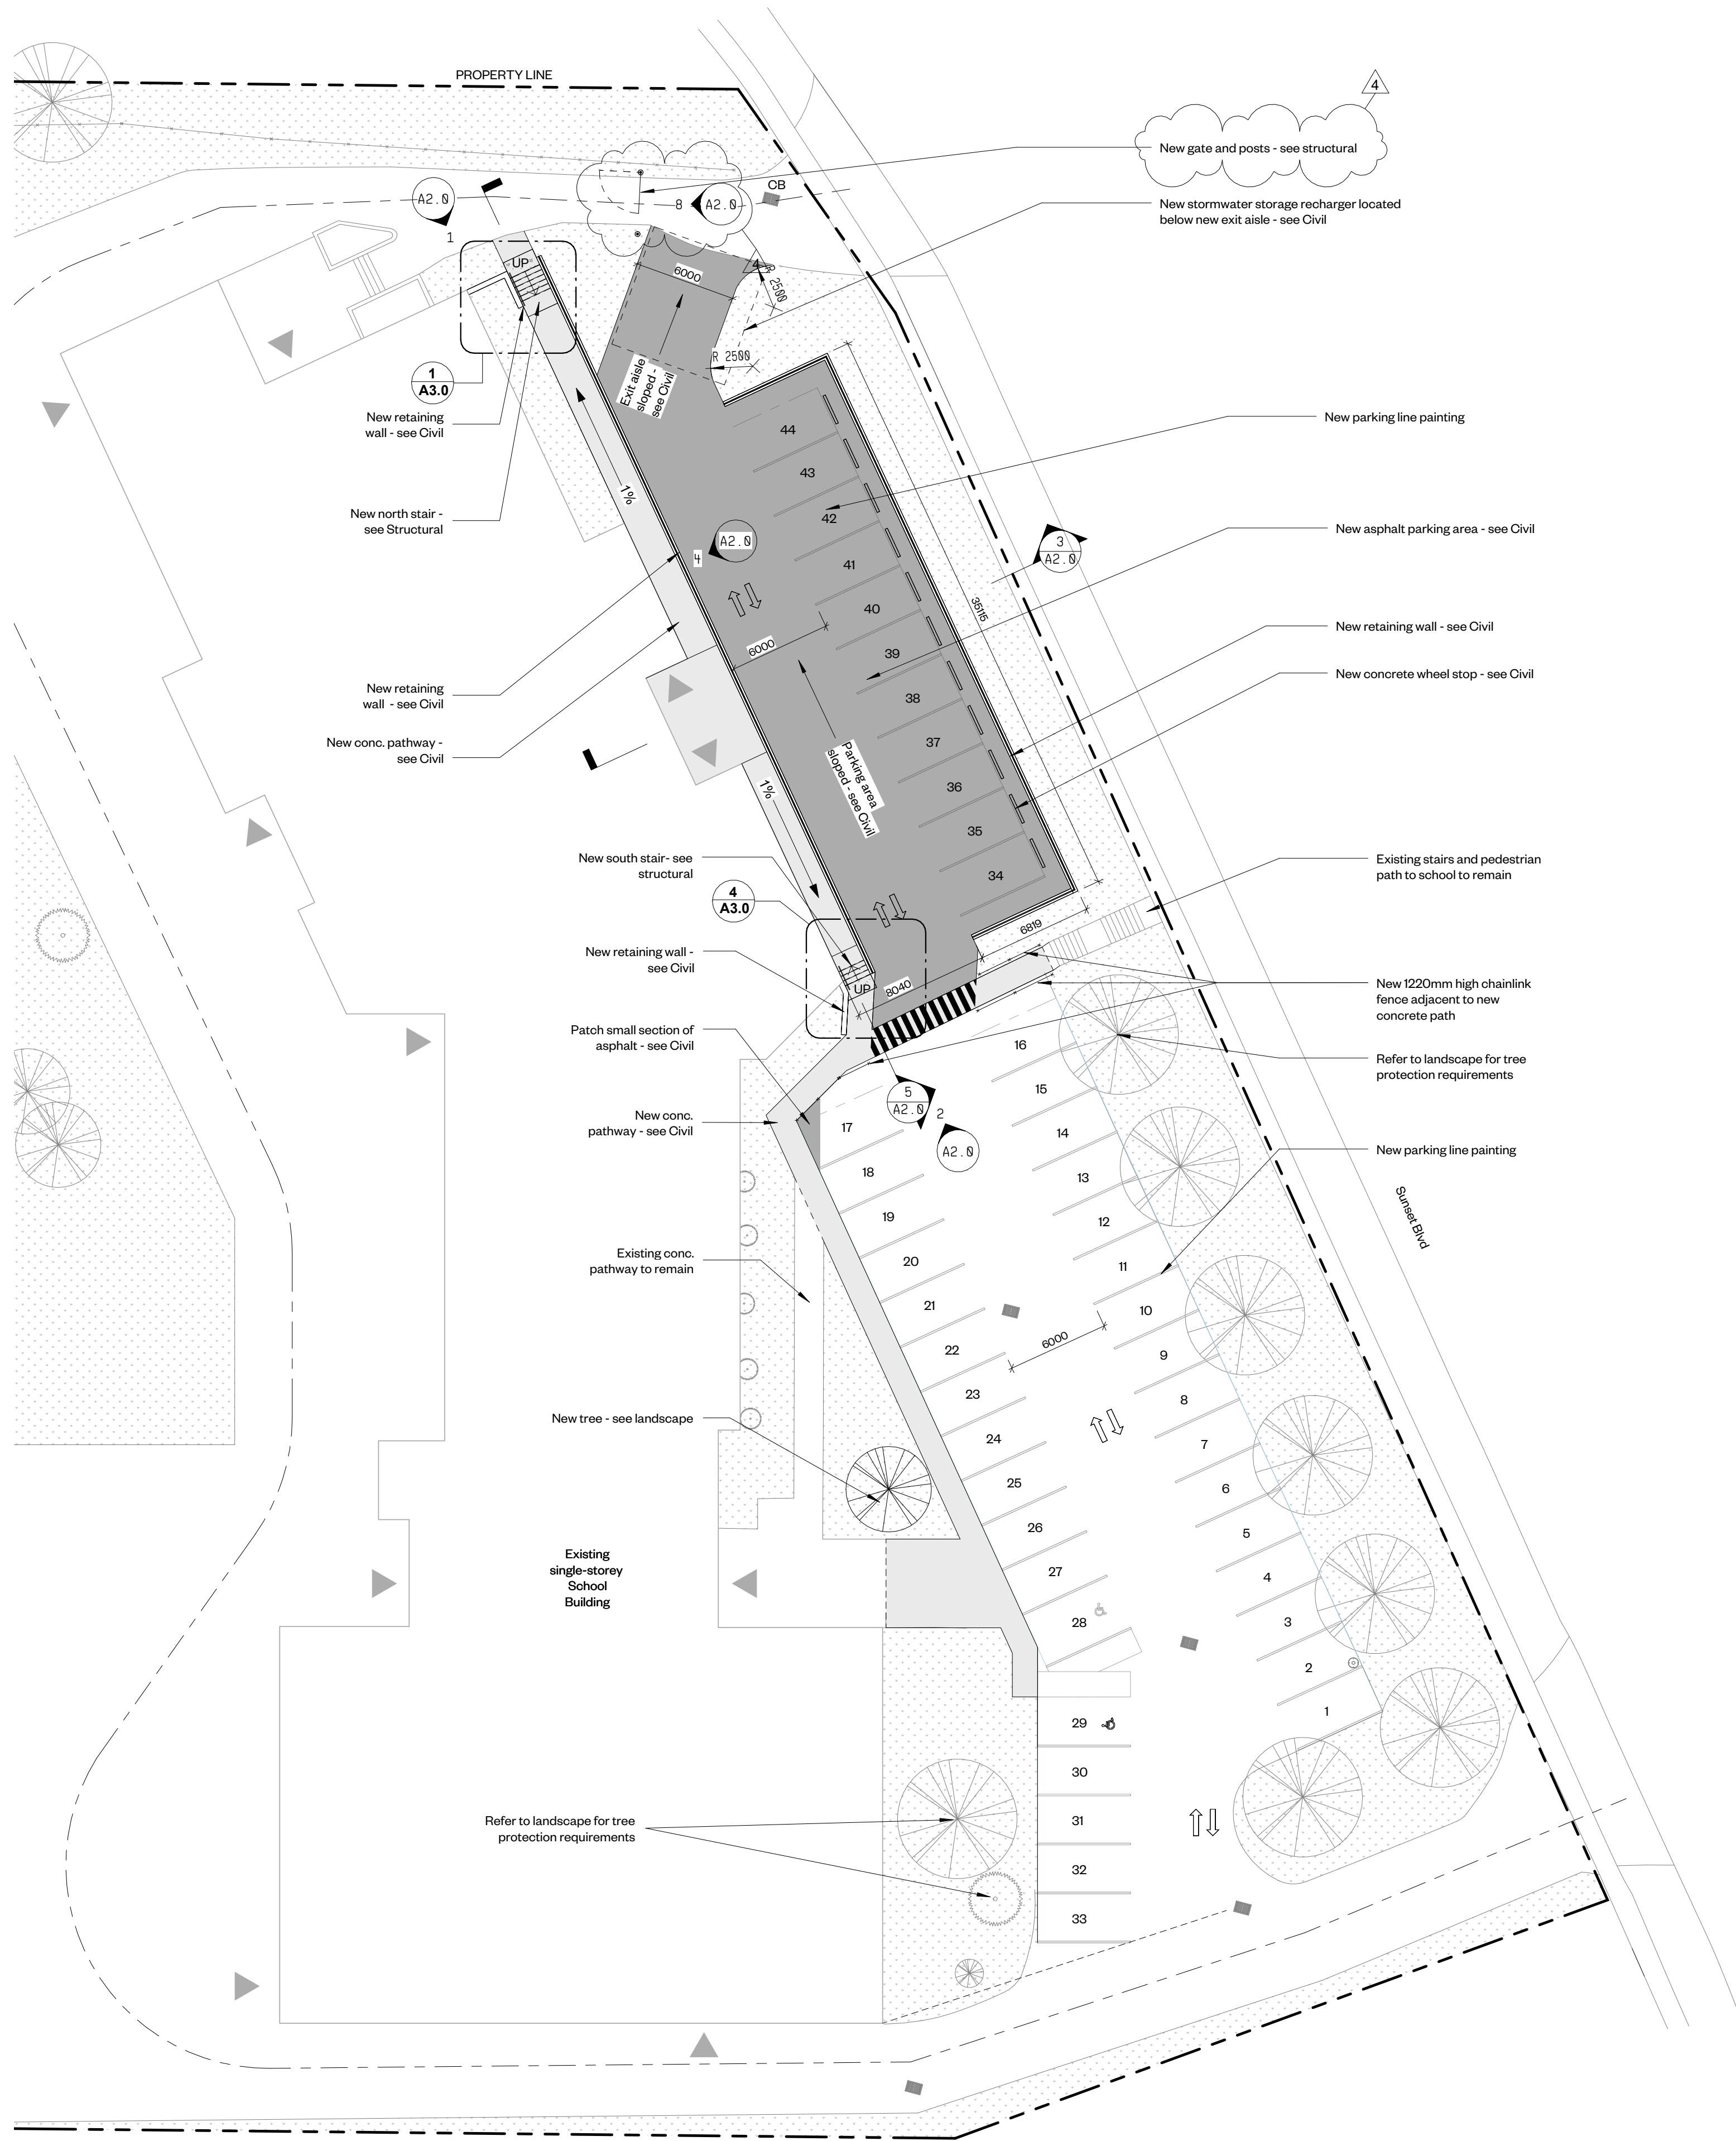

② Site Plan - Proposed  
1 : 250

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- Extent of new concrete
- Extent of grass/sod
- Fire route
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- Catch basin
- Tree (existing)
- Crossway painting

#### Demolition Legend

- Extent of surfaces to be demolished
- Tree to be demolished



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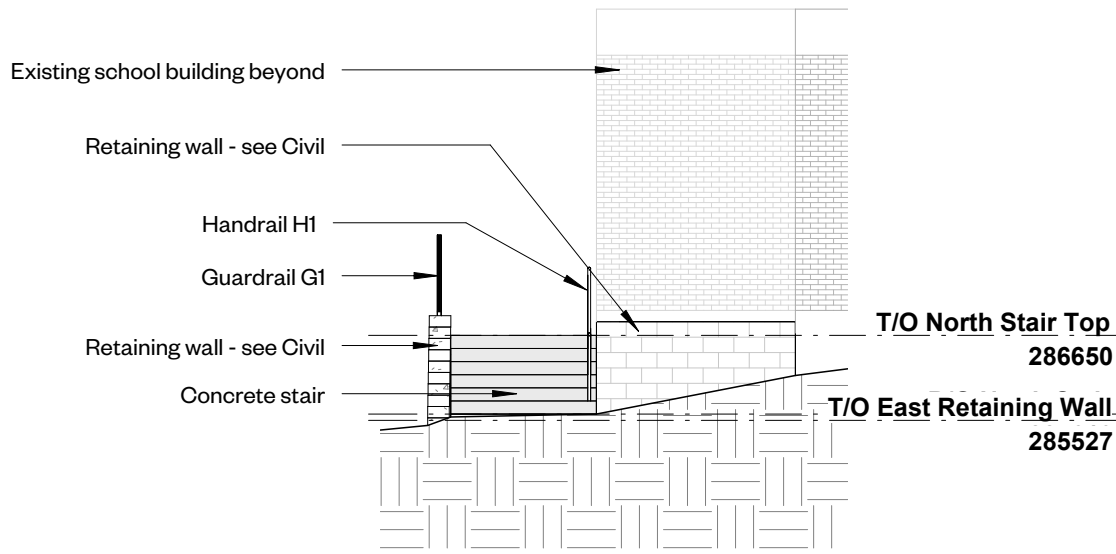
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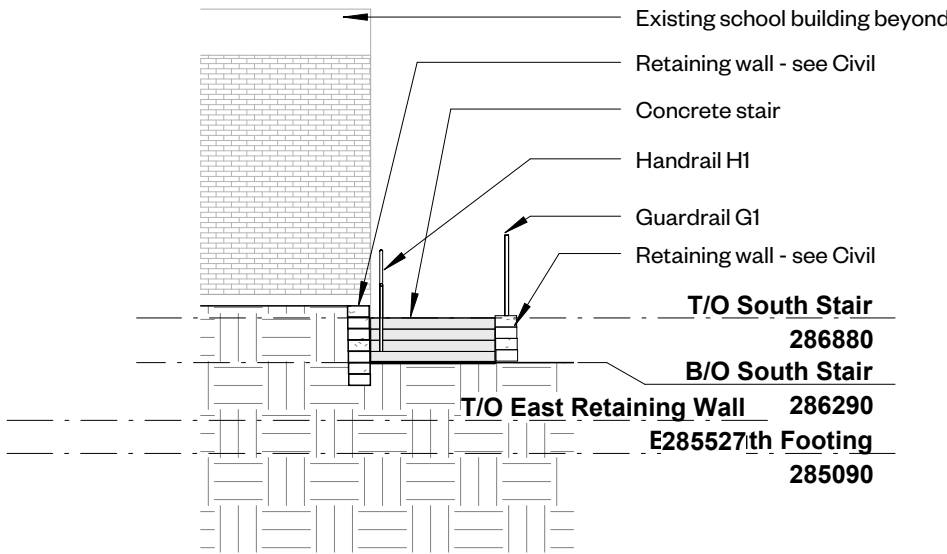
#### Demolition & Proposed Plans









① Exterior Elevation - North Stair  
1 : 100




② Exterior Elevation - South Stair  
1 : 100

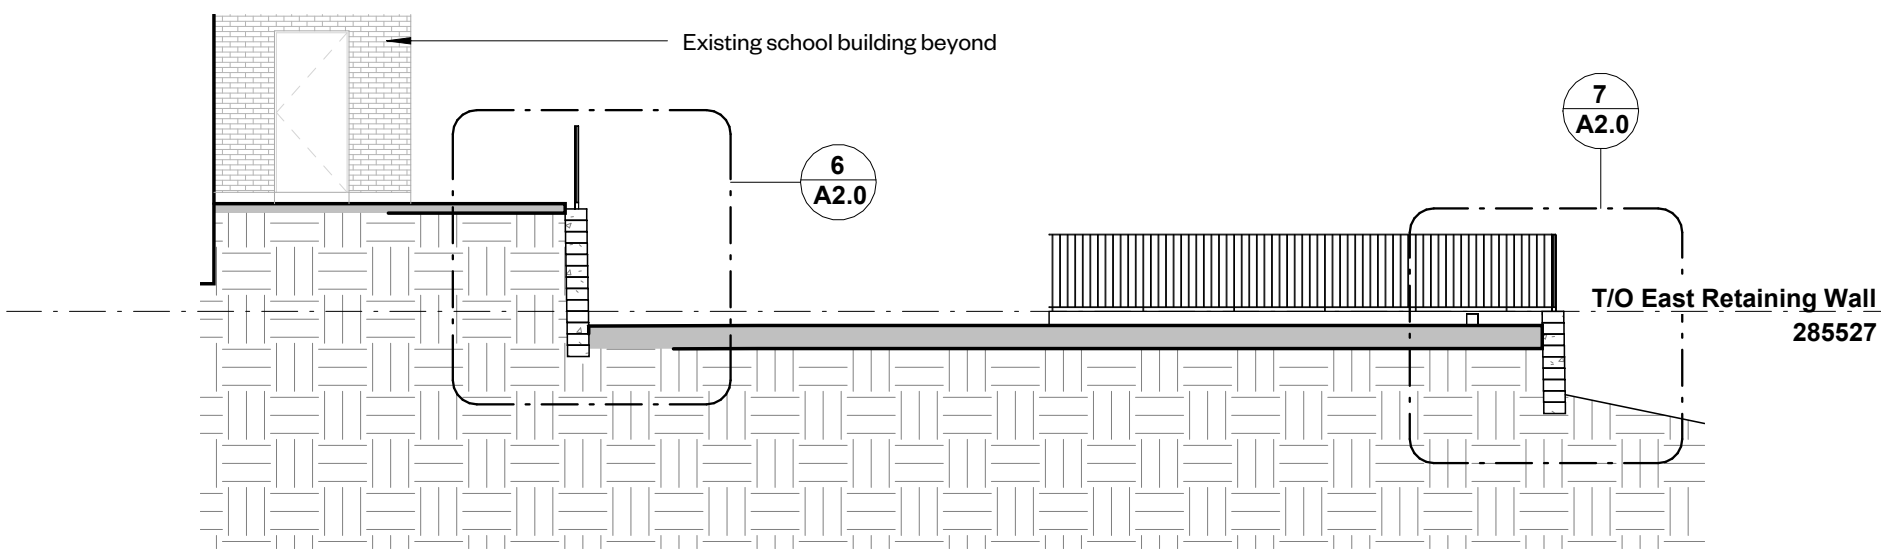


③ Site Section - East and West Retaining Walls  
1 : 100

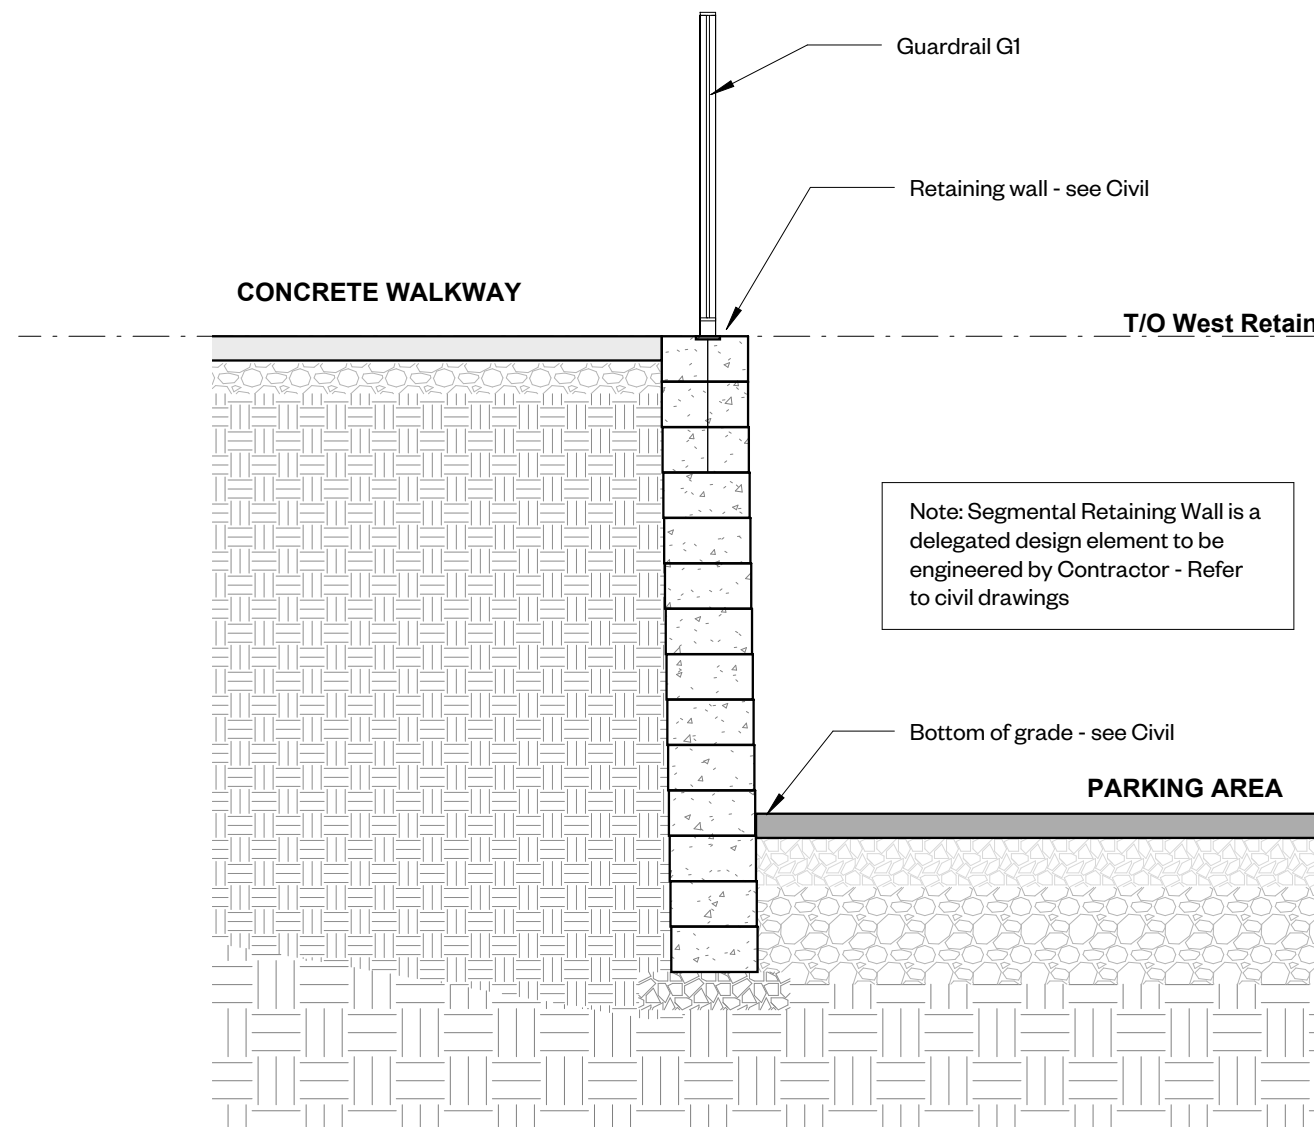


⑥ Section Detail - West Retaining Wall  
1 : 25

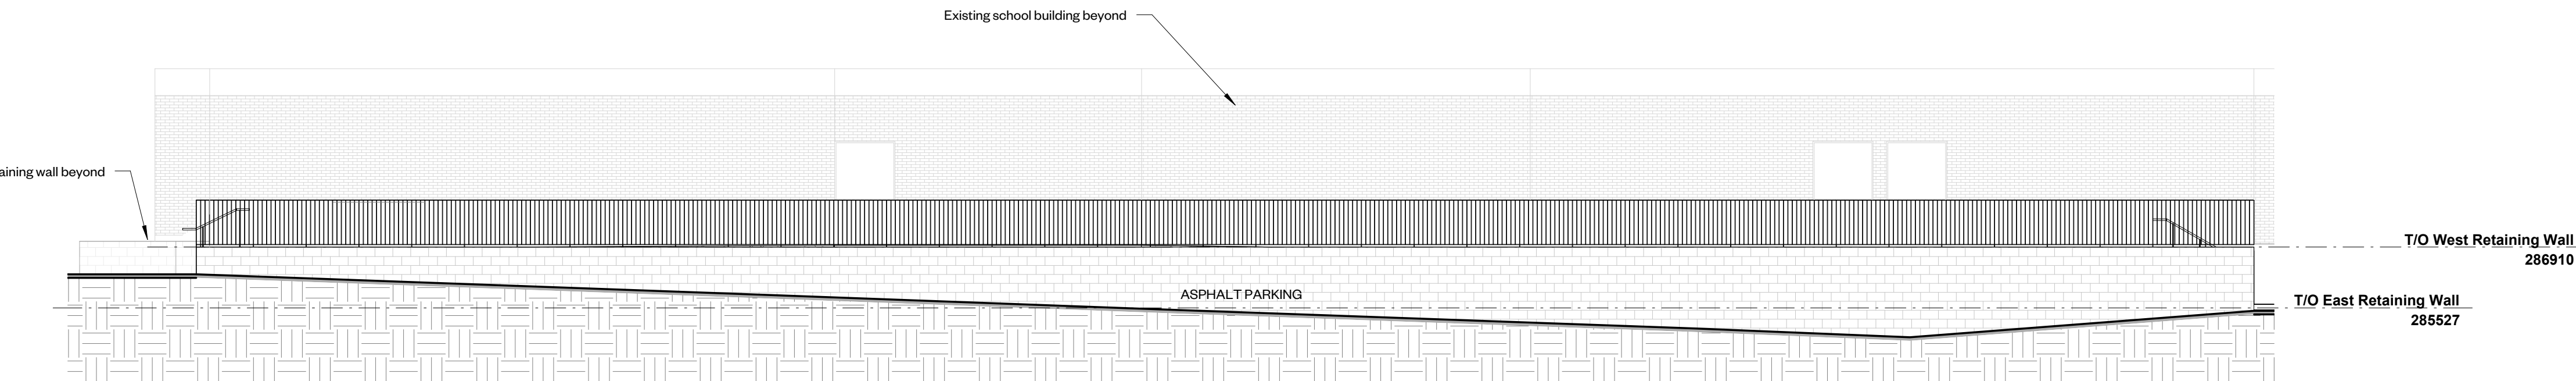


④ Exterior Elevation - West Retaining Wall  
1 : 100

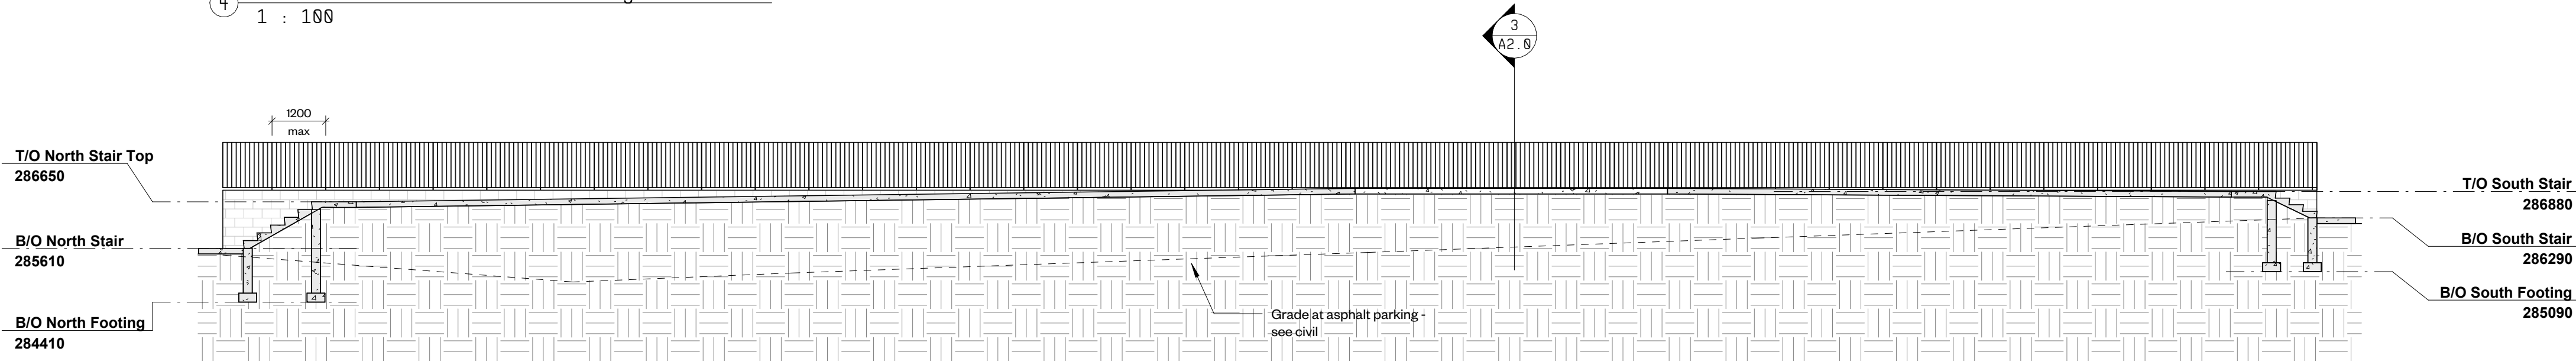

⑤ Site Section - Guardrail at Concrete Walkway and Stairs  
1 : 100

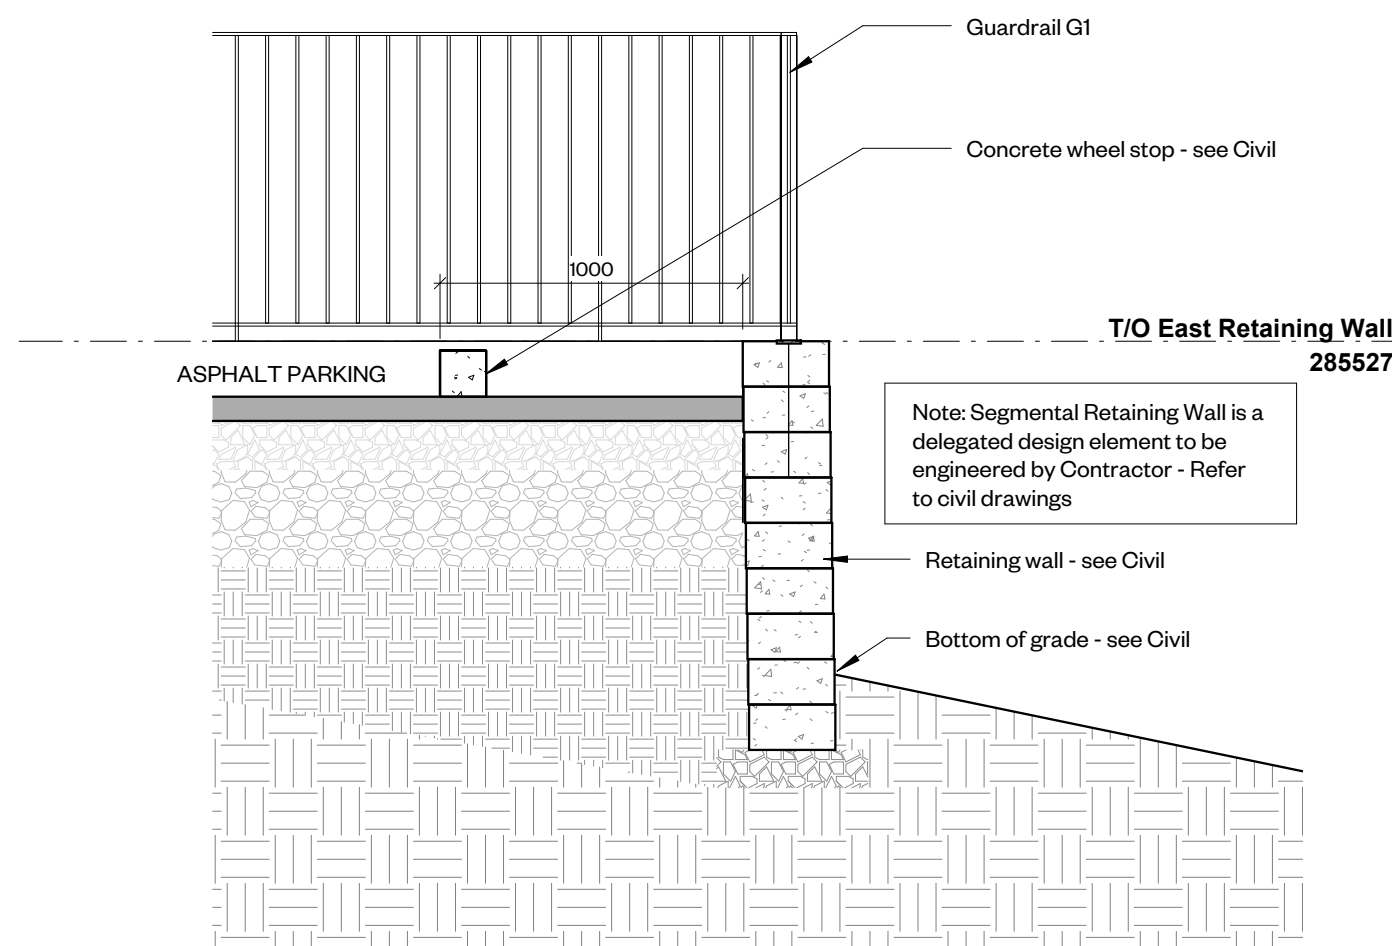


⑦ Section Detail - East Retaining Wall  
1 : 25

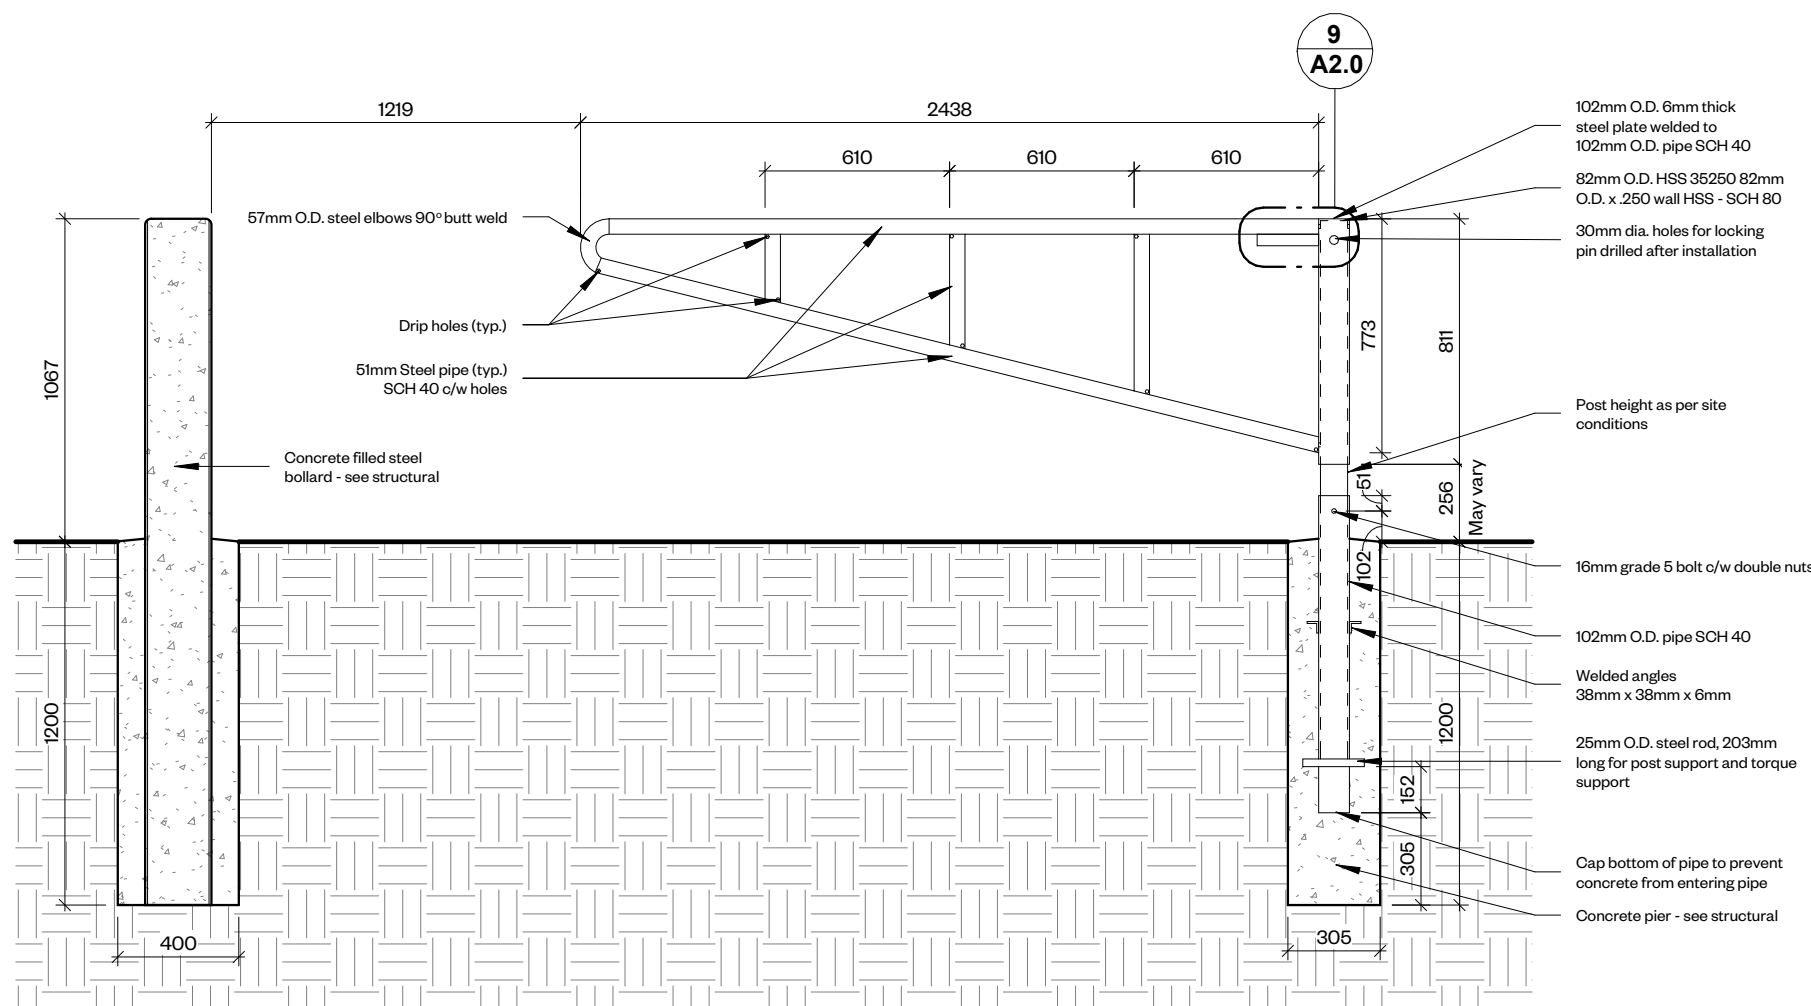

⑧ Section Detail - Gate Post and bollard  
1 : 25

#### Notes:

1. All connections are welded with complete solid weld
2. 13mm holes to be drilled in top and bottom of vertical support members and main gate supports
3. Dry fit assembly before galvanizing
4. Gates to be hot dipped Galvanized after fabrication
5. Drill 13mm holes to drain pipes during hot drip process
6. Lock pin not to be galvanized
7. Two post locking pin holes to be drilled in each gate support post in a location approved by plant maintenance and construction department to allow for site conditions  
Ensure concrete does not fill lower end of pipe
8. Gate height and method of adjustment to be approved by plant maintenance and construction department for variances in height due to site conditions

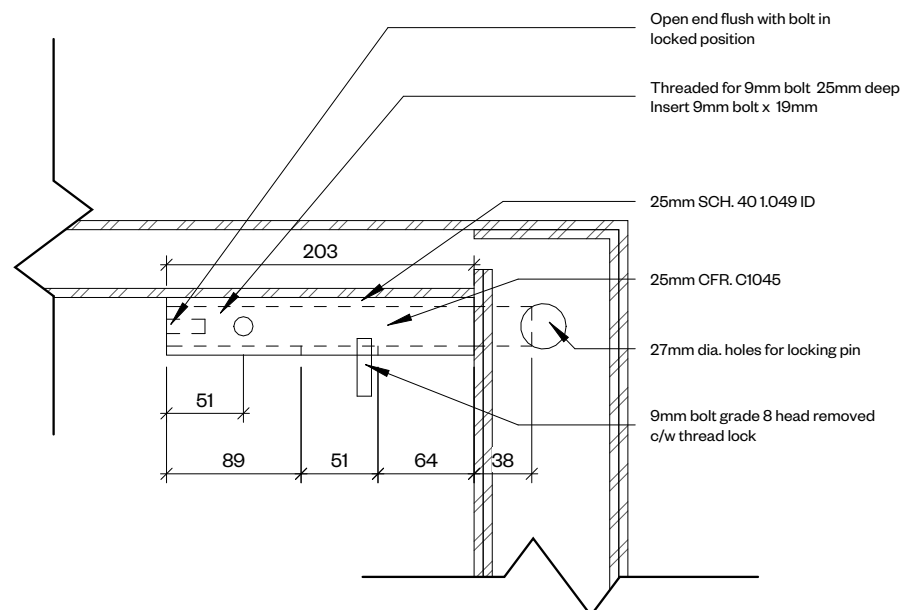

⑨ Detail - Gate Post Locking Mechanism  
1 : 5

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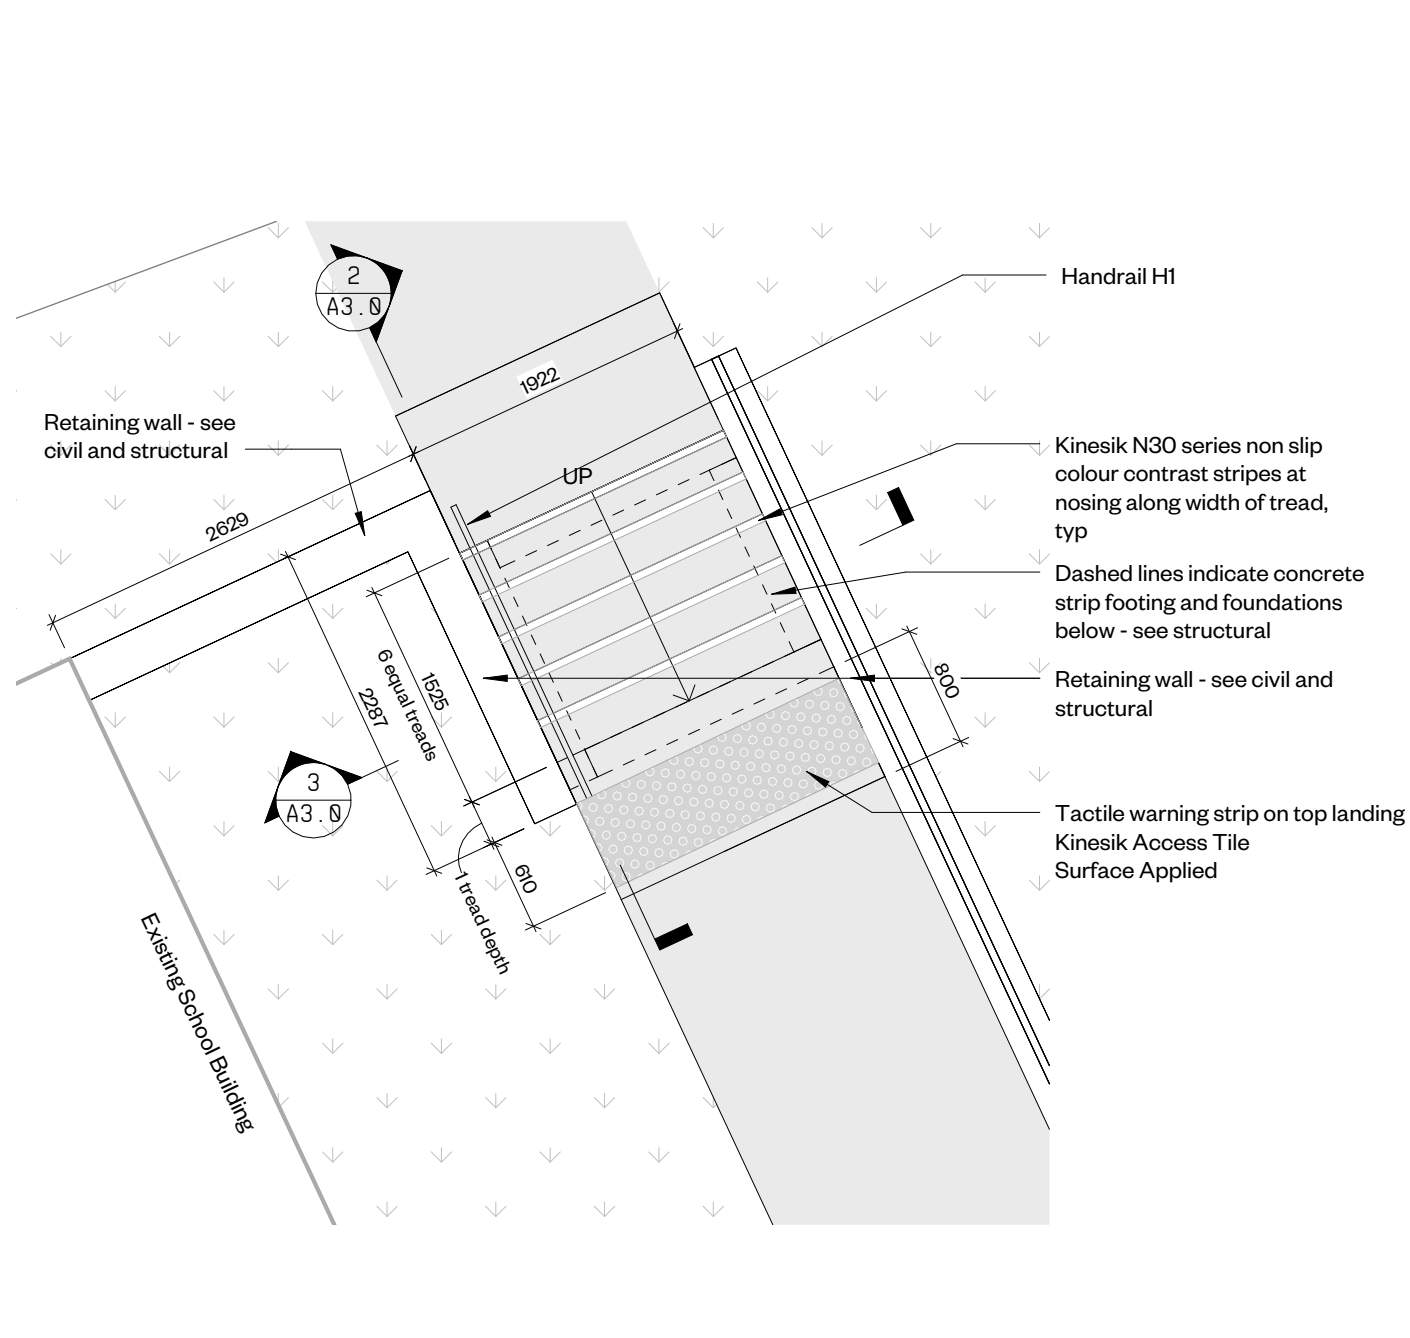
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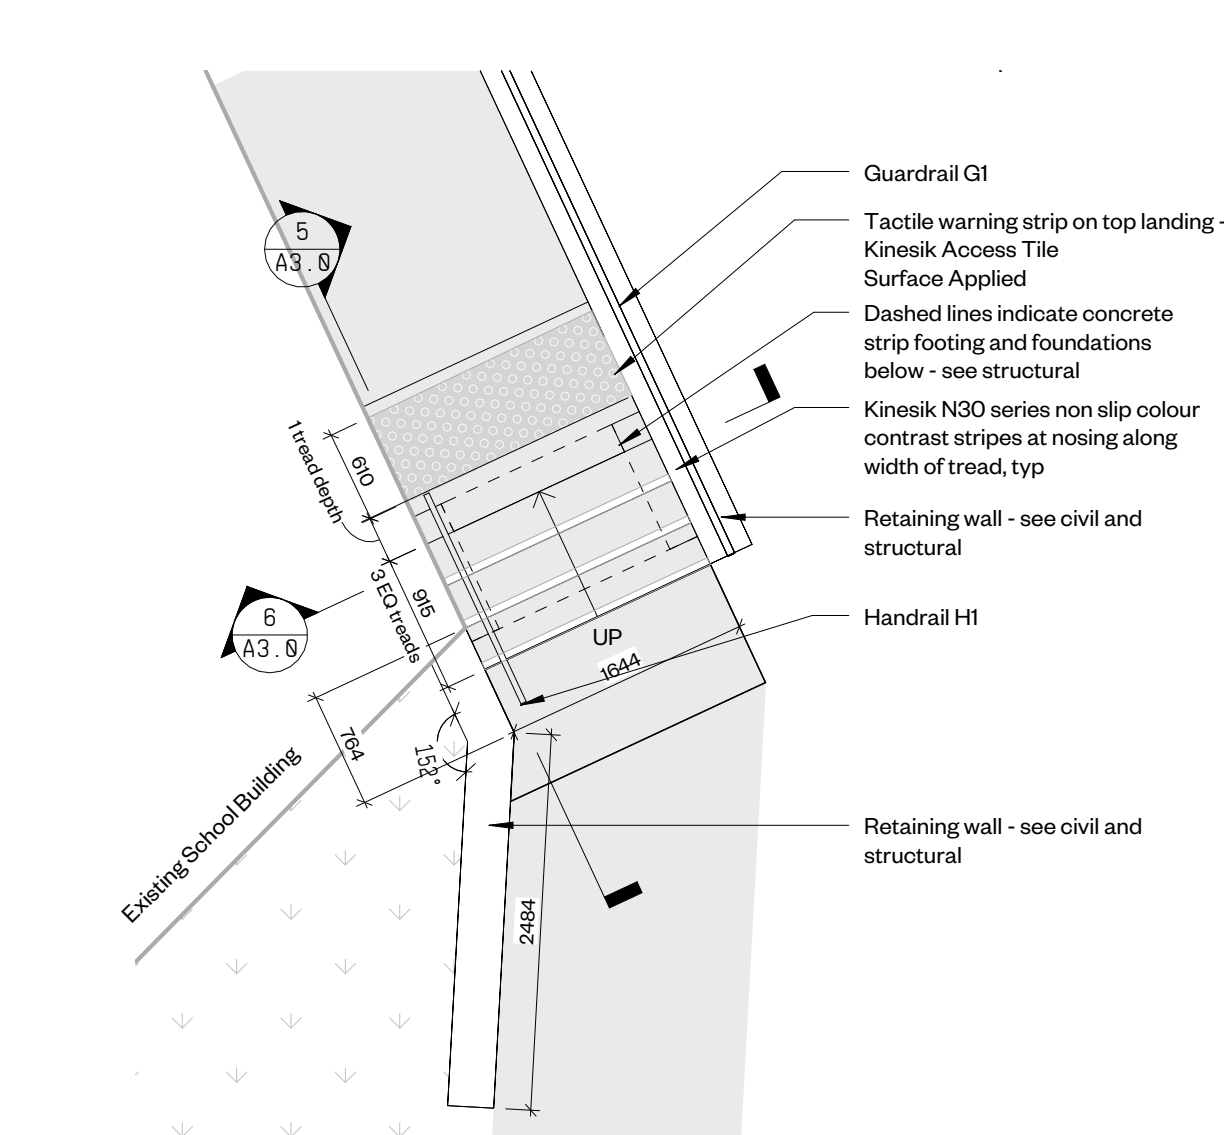
#### Exterior Elevations & Sections

drawing number


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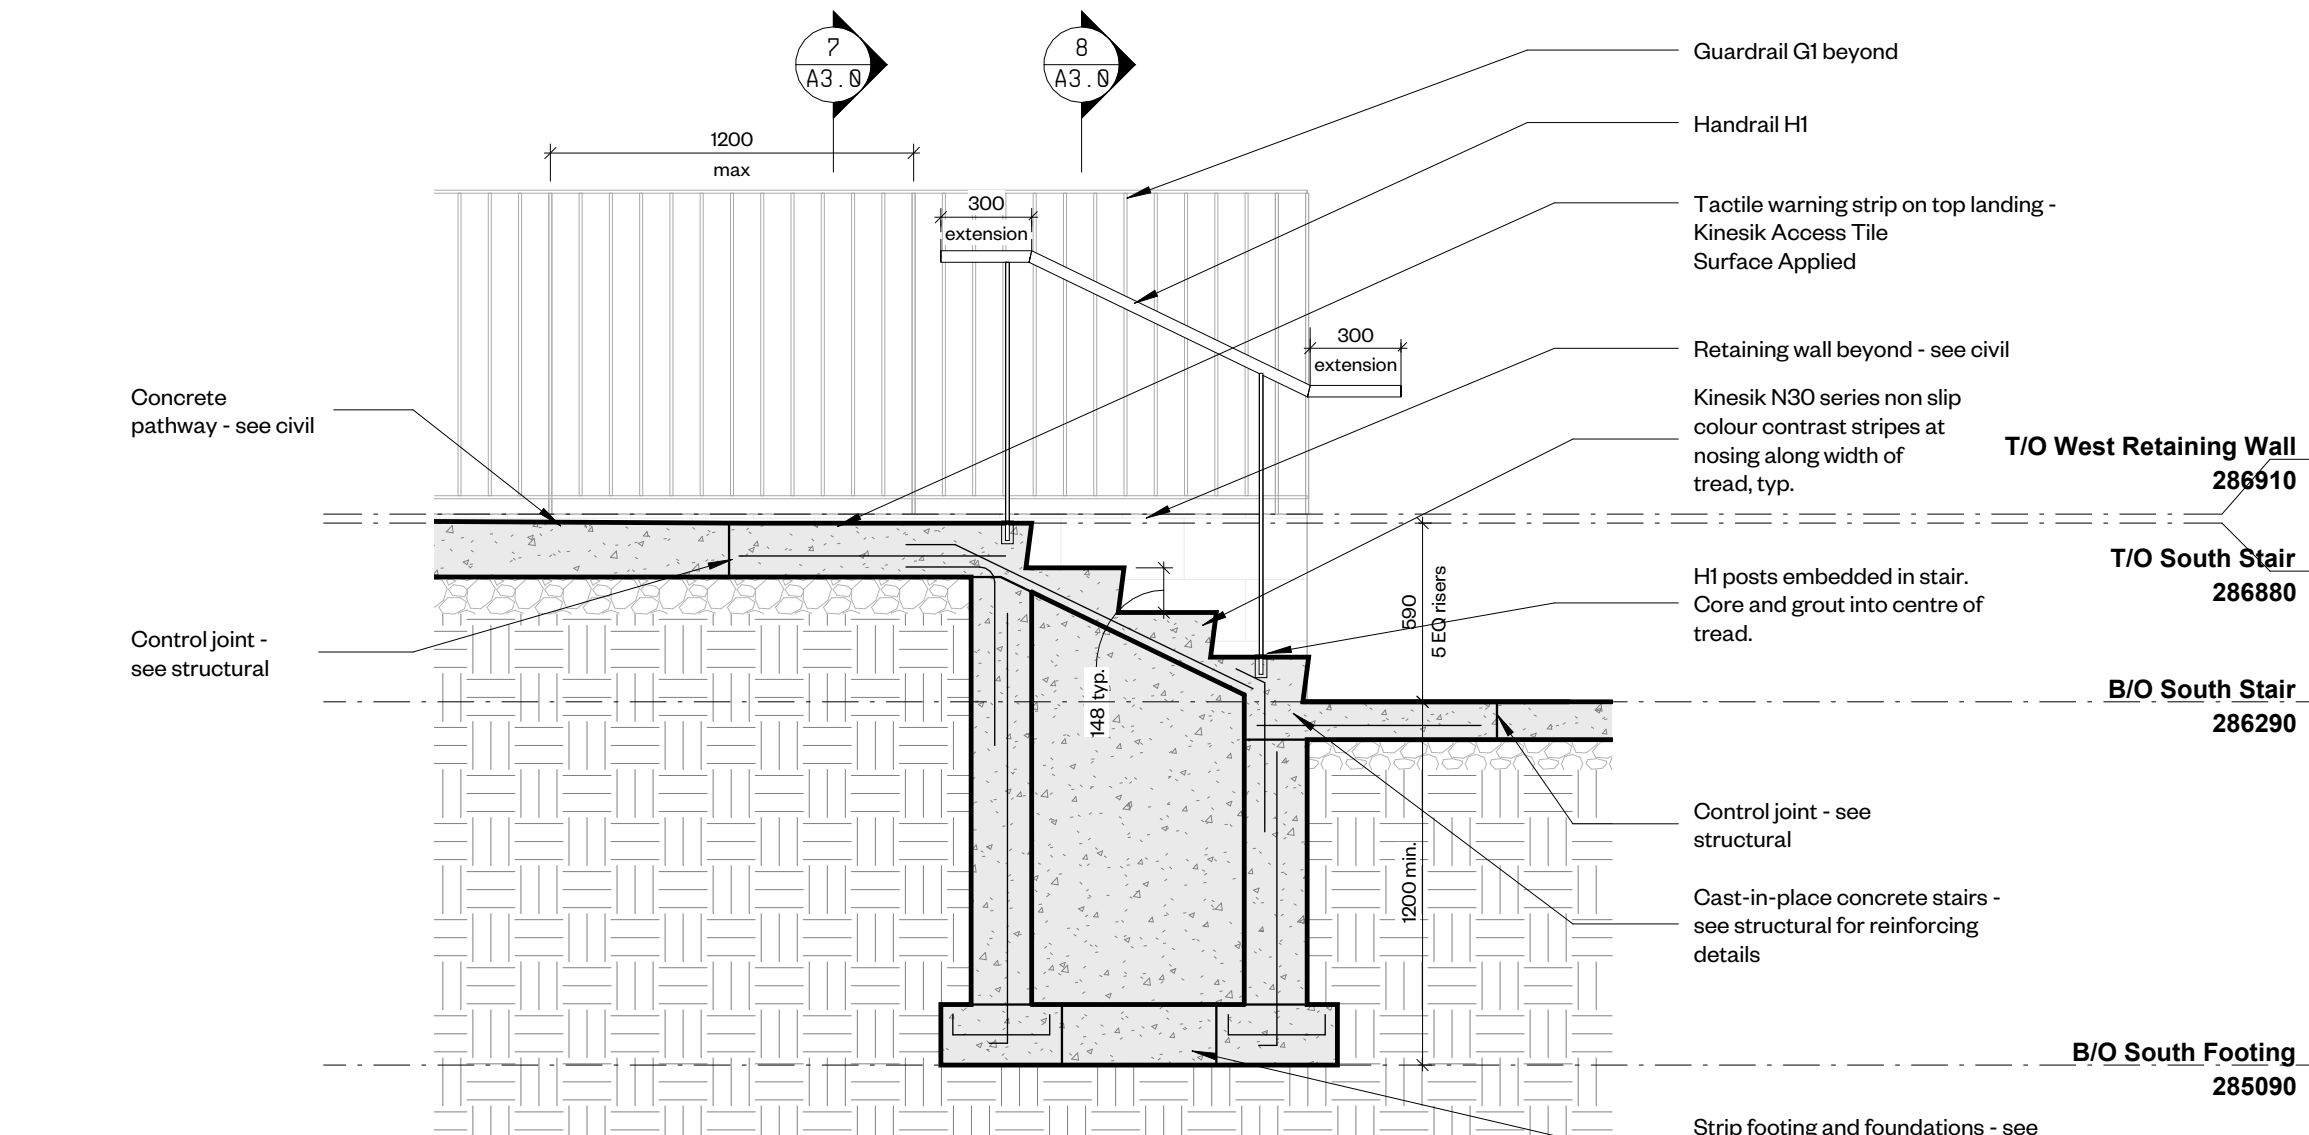
① Detail Plan - North Stair  
1 : 50




④ Detail Plan - South Stair  
1 : 50




② Section Detail - North Stair 1  
1 : 25

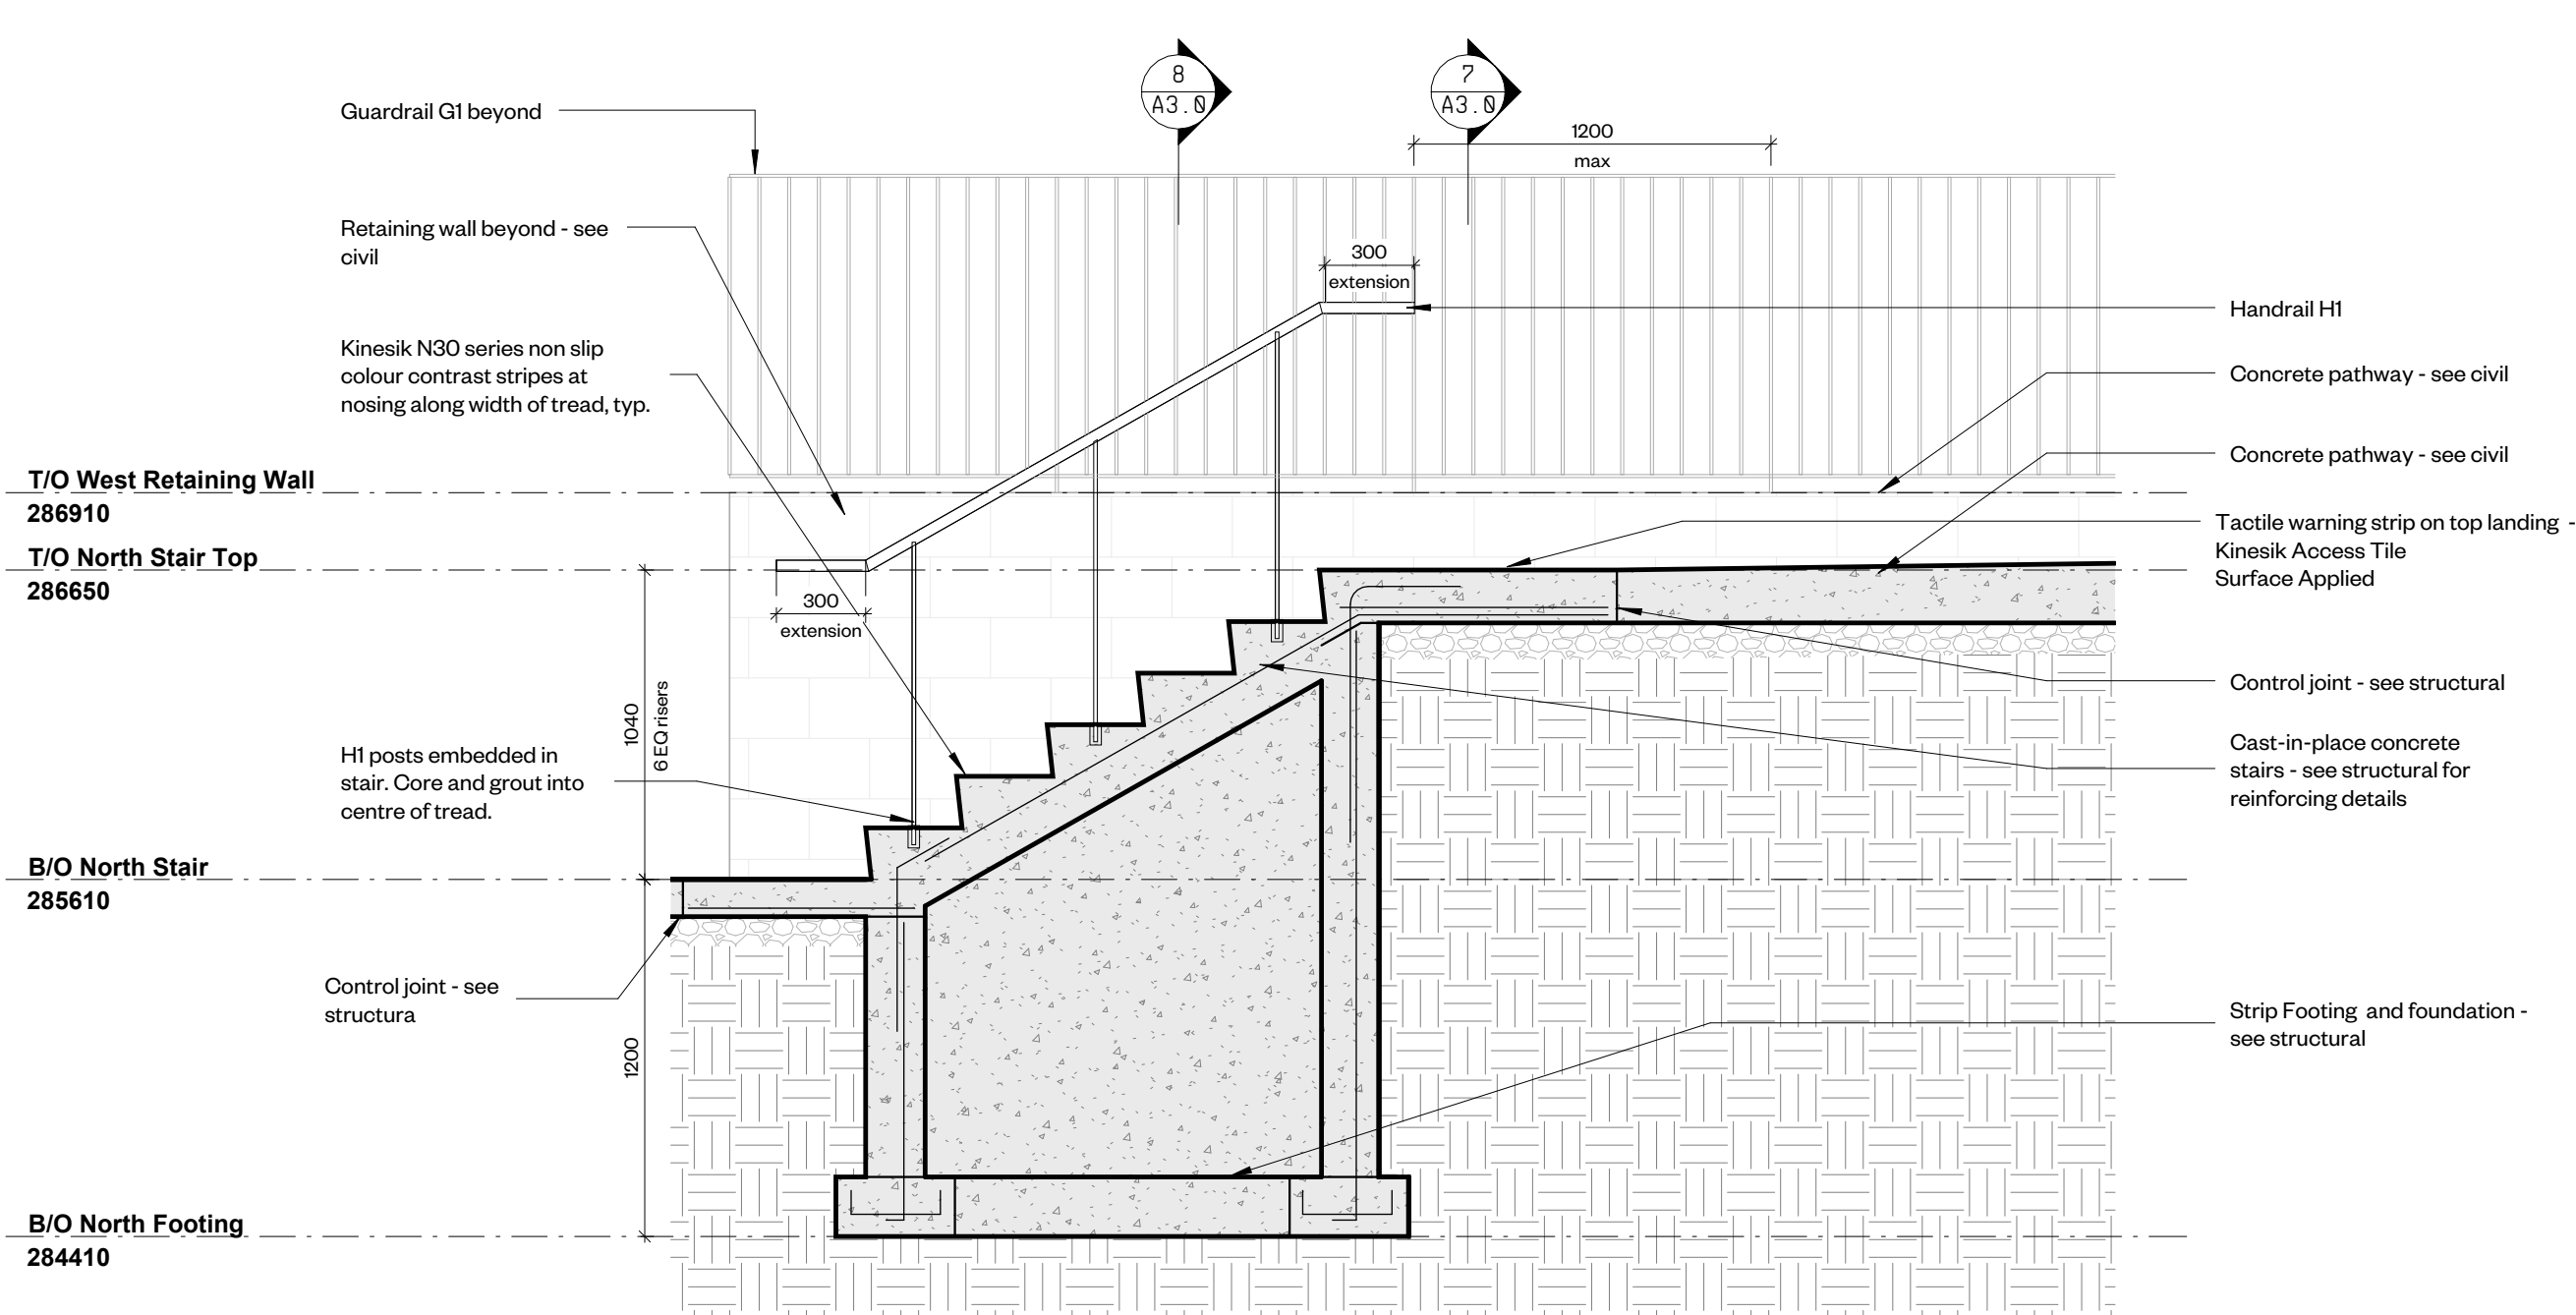


⑤ Section Detail - South Stair 1  
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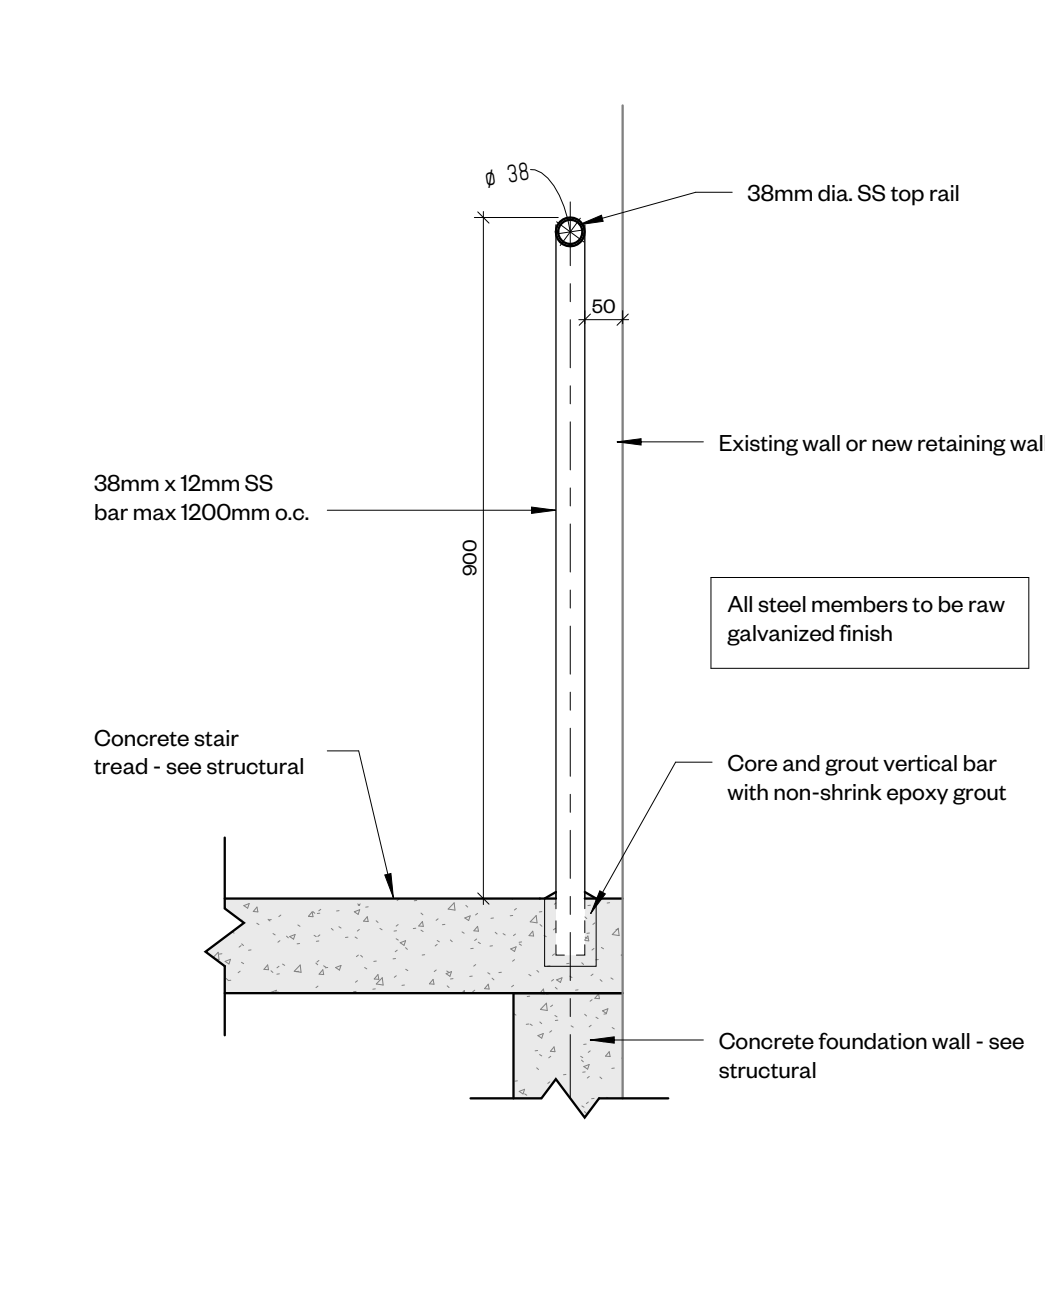
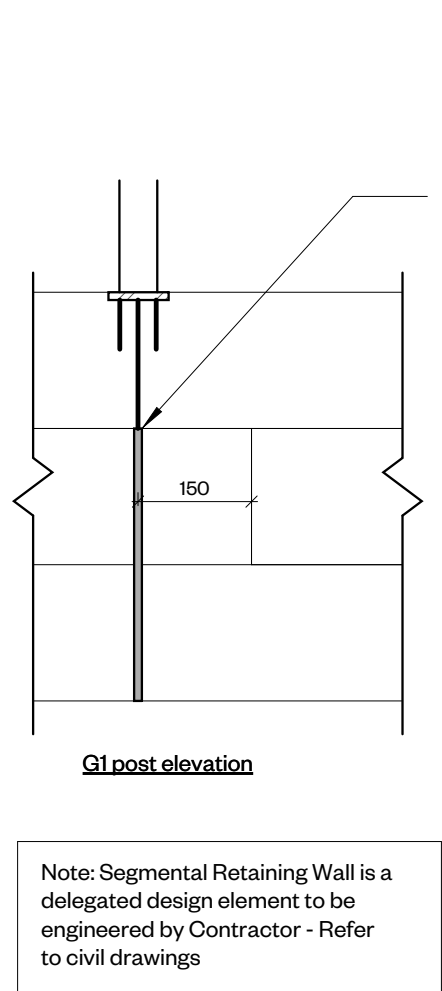
③ Section Detail - North Stair 2  
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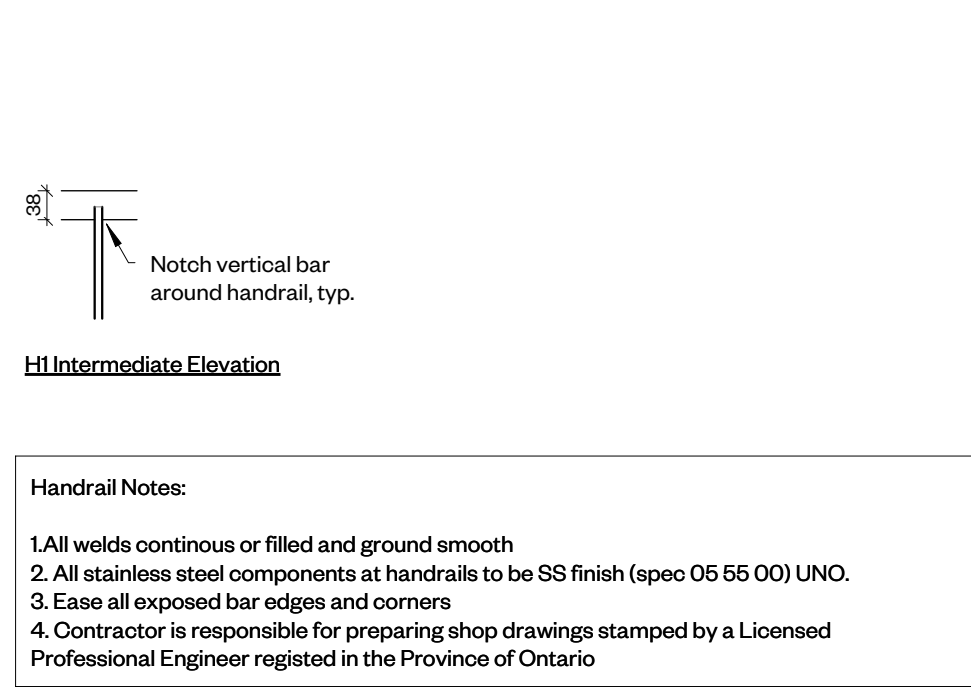
⑥ Section Detail - South Stair 2  
1 : 25

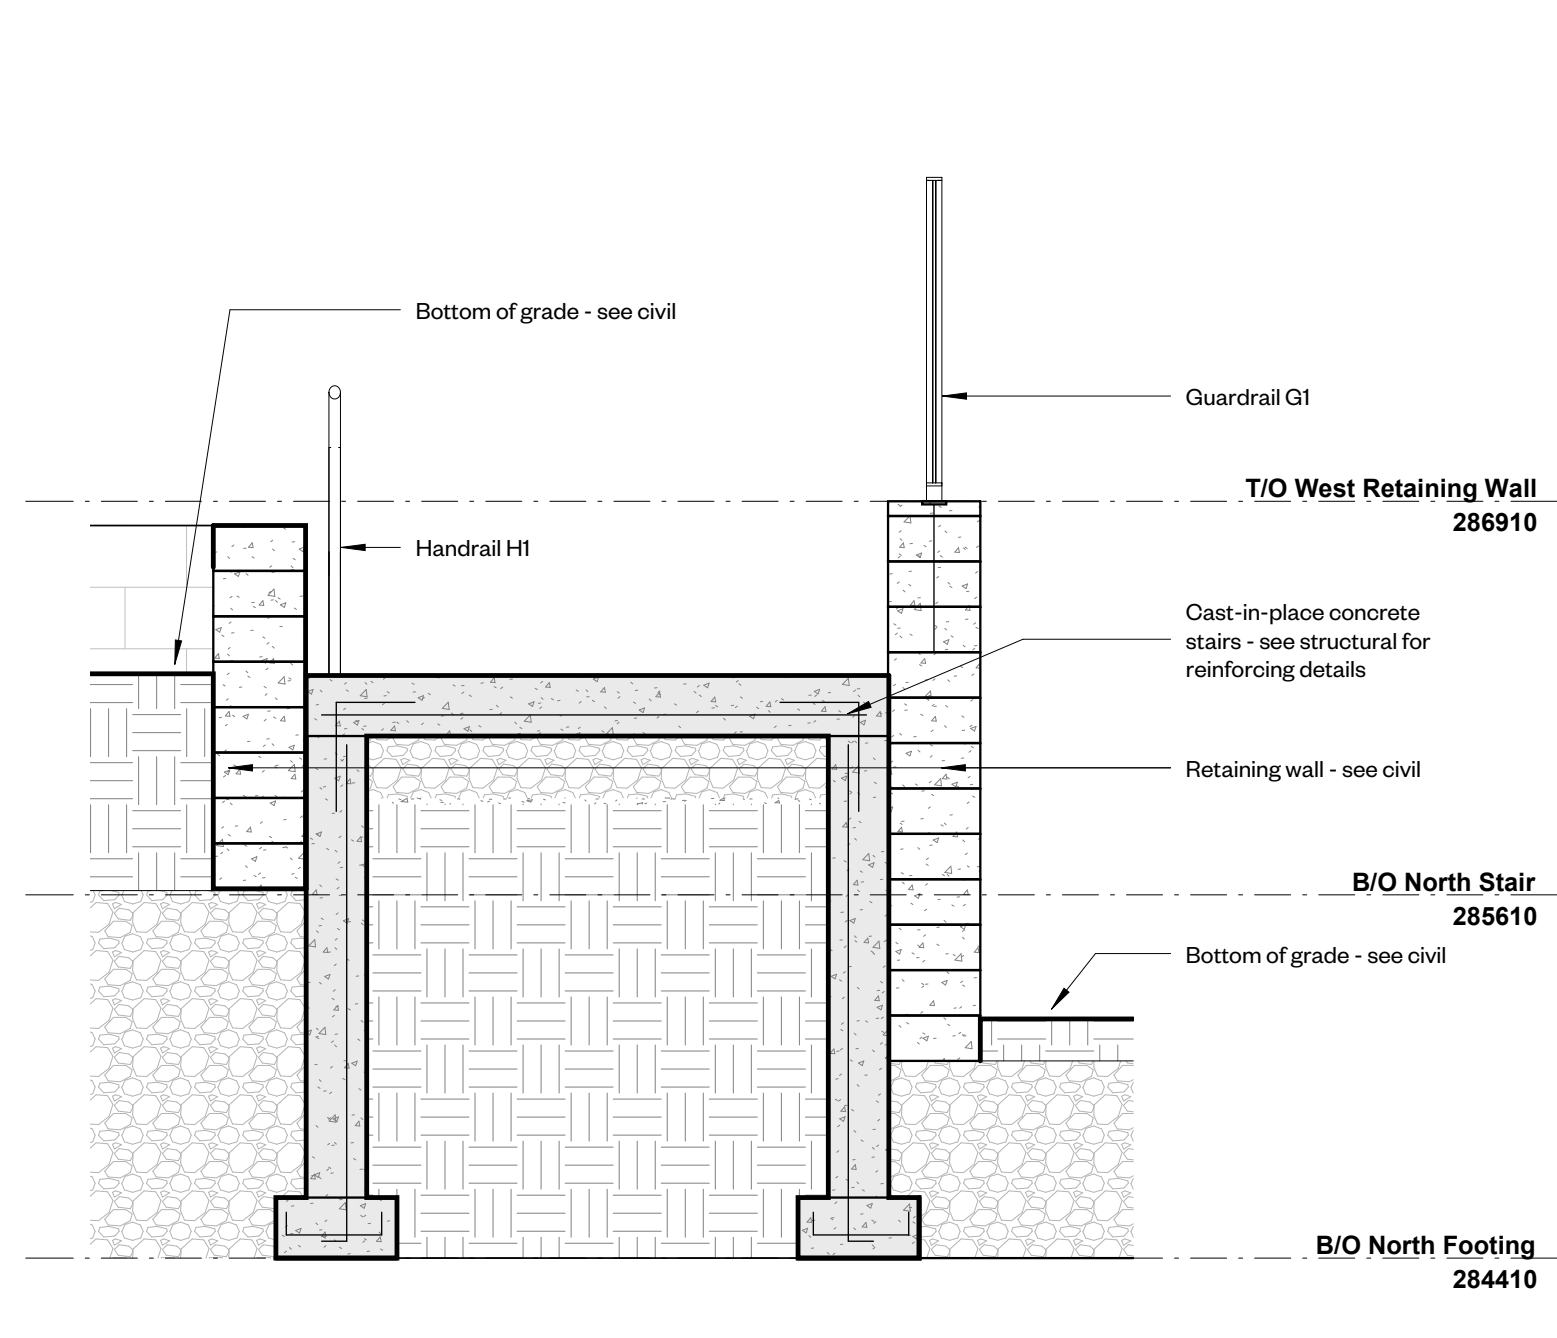

⑦ Section Detail - Guardrail G1  
1 : 10

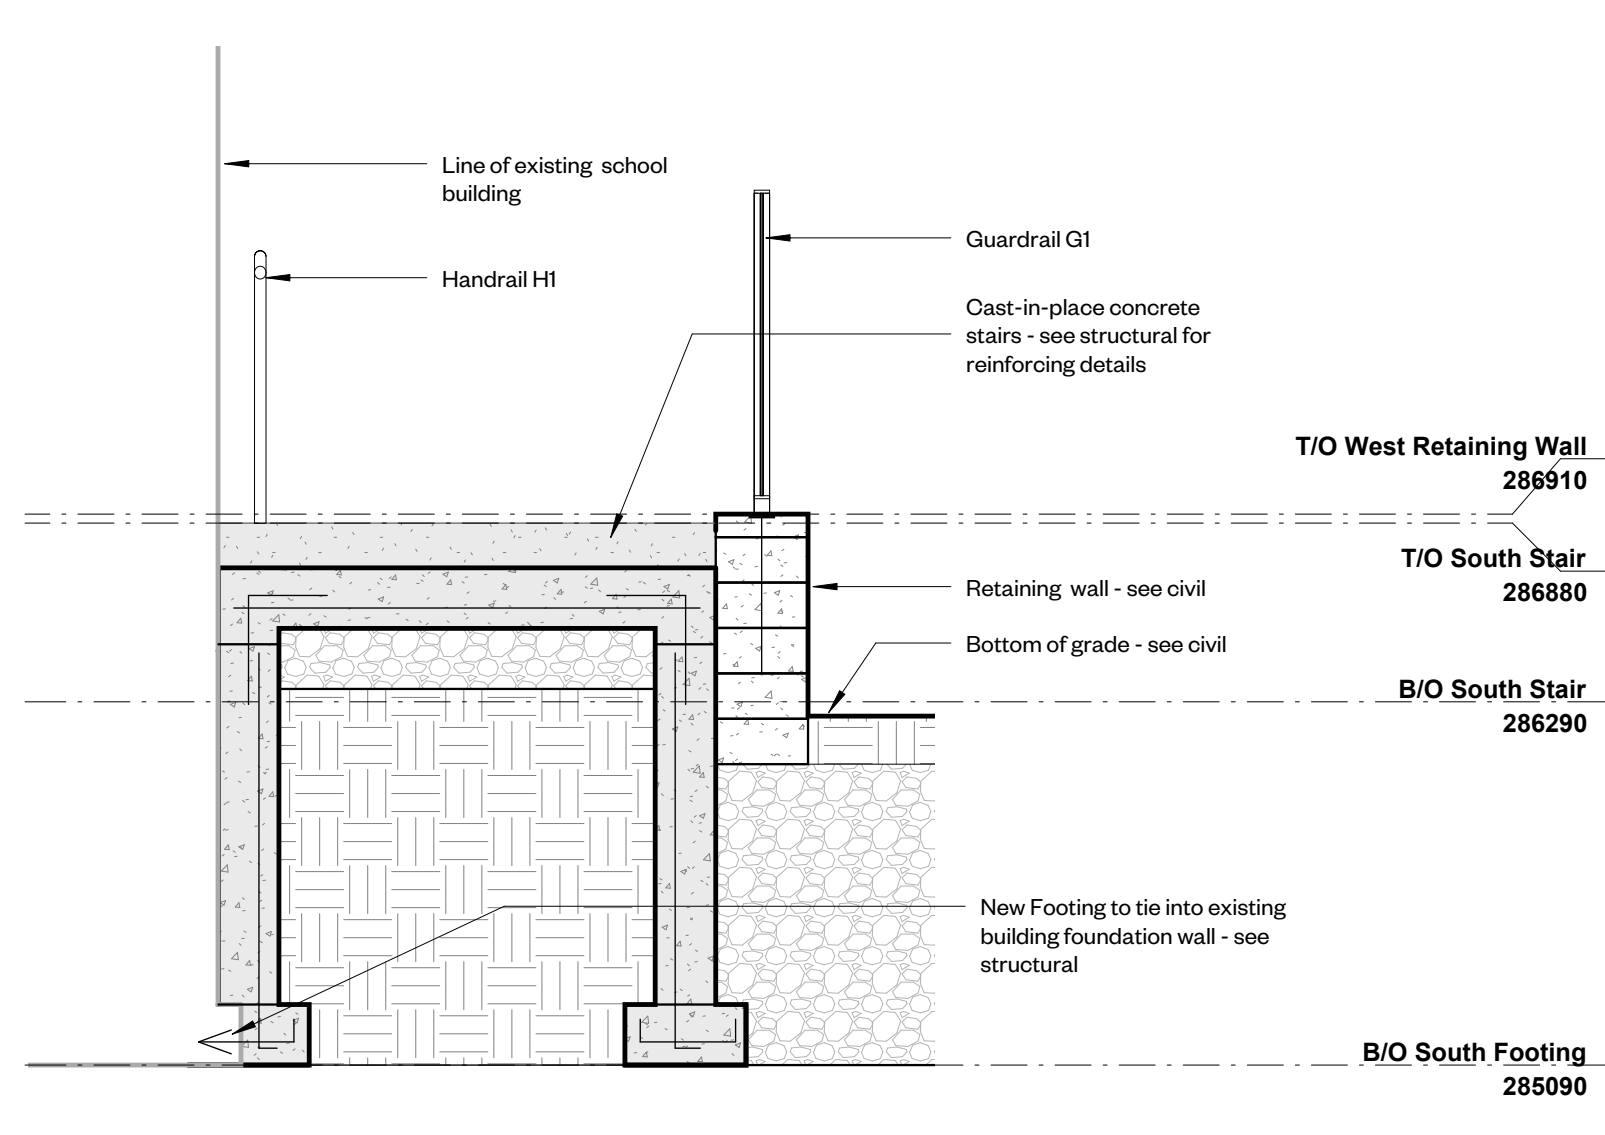

⑧ Section Detail - Handrail HI  
1 : 10

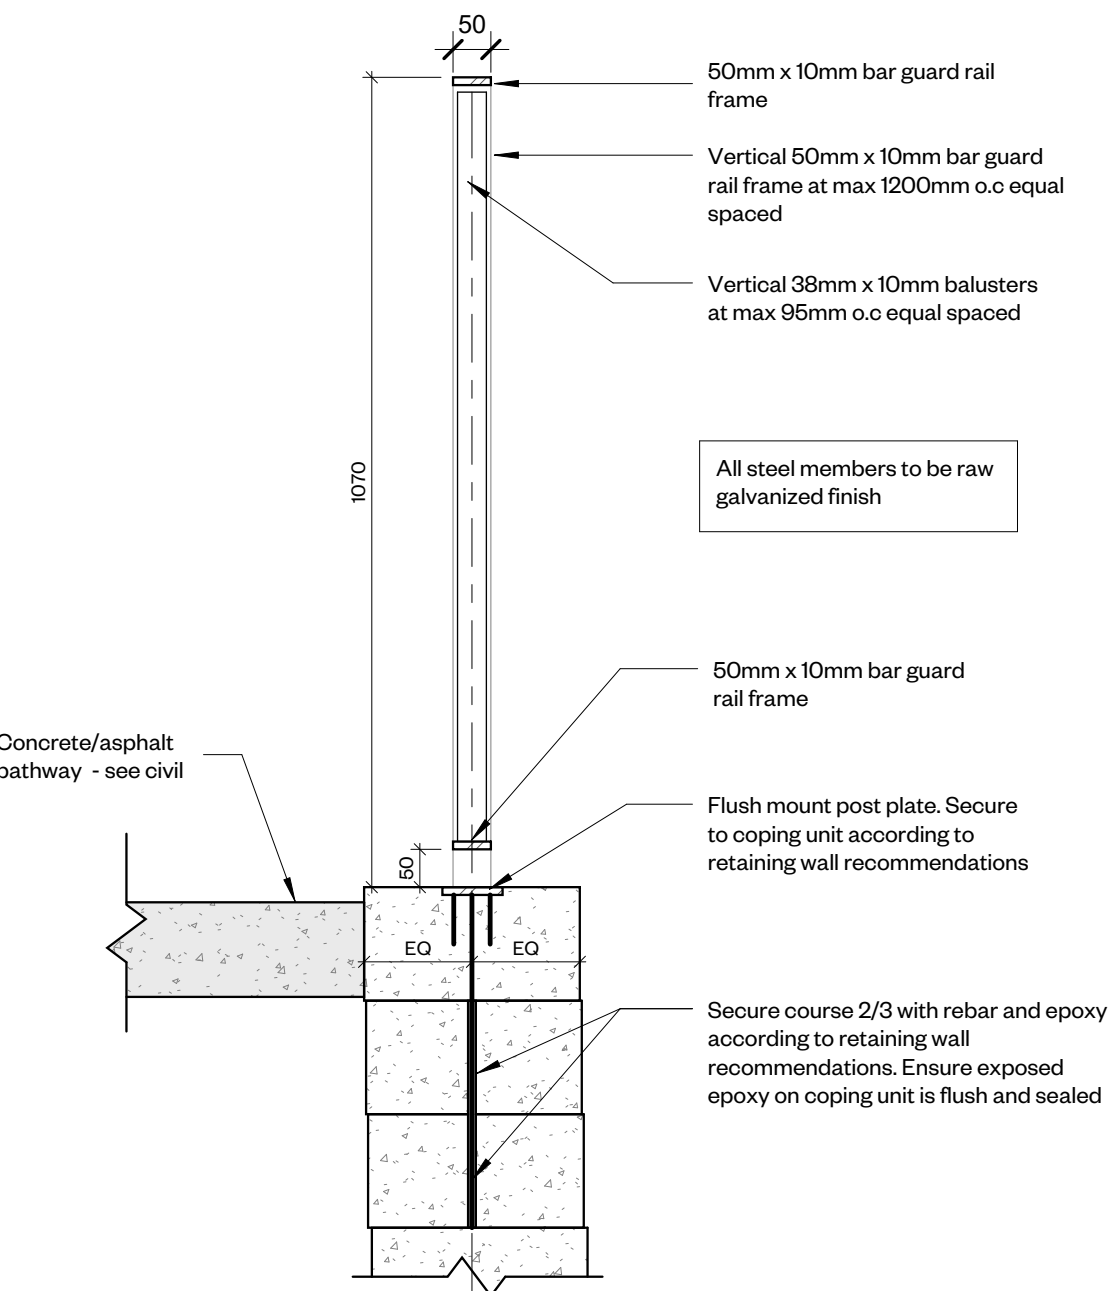

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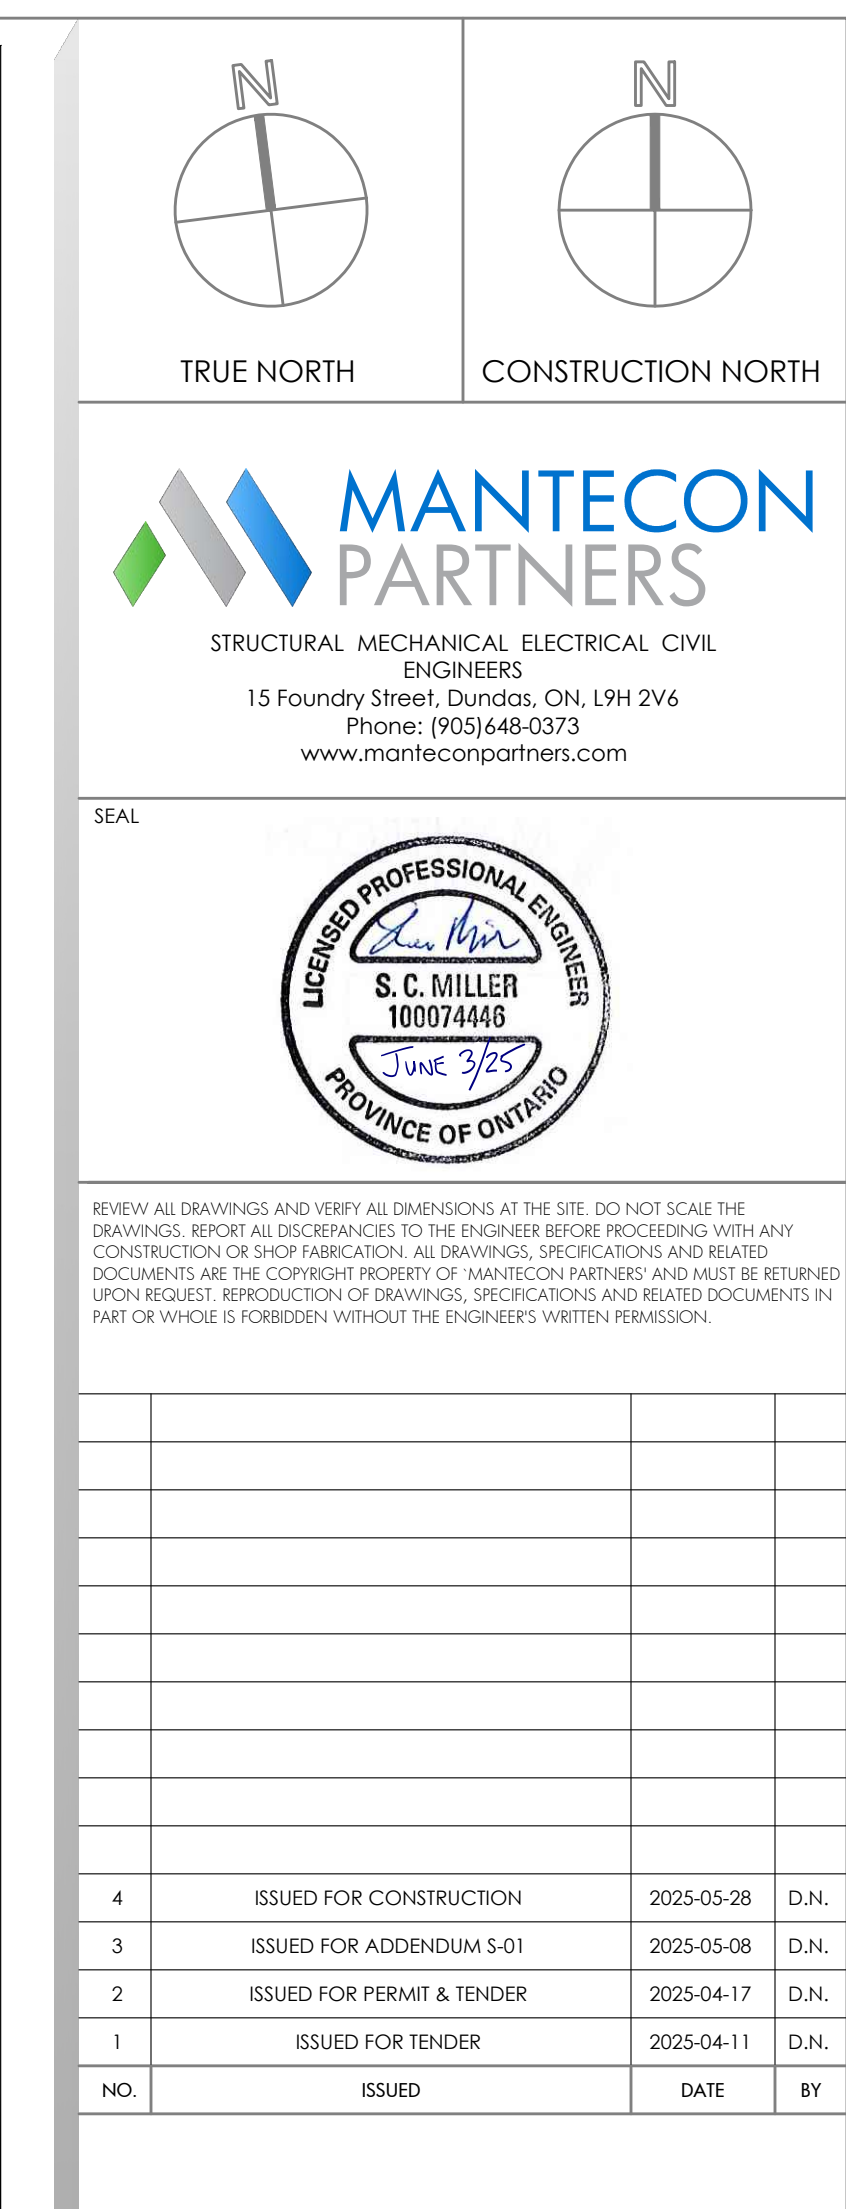
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### Stair and Guardrail Details







HORIZONTALLY IN WALLS.

- e) CONDUITS WITHIN SLABS MUST NOT HAVE A (OUTER) DIAMETER GREATER THAN ONE-QUARTER OF THE SLAB THICKNESS. SPACING BETWEEN CONDUITS MUST BE AT LEAST 3 TIMES THE OUTER DIAMETER [CLEAR SPACING]. CONDUITS MUST BE PLACED WITHIN MIDDLE THIRD OF SLAB. CONDUITS SHALL BE LAID SUCH THAT ONLY SINGLE CROSS OVERS OCCUR WITHIN MAXIMUM 500mm OF ONE ANOTHER. ALL CONDUITS WITHIN SLAB ARE SUBJECT TO APPROVAL BY STRUCTURAL CONSULTANT.
- f) REFER TO DESIGN DRAWINGS FOR TYPICAL DETAILS OF CONTROL JOINTS, EXPANSION JOINTS AND CONSTRUCTION JOINTS. UNLESS OTHERWISE NOTED ON THE DESIGN DRAWINGS, THE FOLLOWING MAXIMUM DISTANCE BETWEEN JOINTS MUST BE FOLLOWED:
  - a) CONTROL JOINTS IN WALLS 6m (20') MAXIMUM
  - b) MAXIMUM POUR LENGTH FOR SLAB ON GRADE IS 30m (100').
  - c) ALL SAWCUTS MUST BE MADE WITHIN 24 HRS. FROM PLACING OF CONCRETE. THE DEPTH OF THE SAWCUT MUST BE 1/3 THE DEPTH OF THE SLAB.

## TESTING AND INSPECTION


1. THE FOLLOWING ITEMS REQUIRE TESTING OR INSPECTION BY A CERTIFIED INDEPENDENT TESTING OR INSPECTION AGENCY UNLESS NOTED OTHERWISE. THE AGENCY SHALL SEND COPIES OF ALL STRUCTURAL TESTING AND INSPECTION REPORTS TO THE ENGINEER FOR REVIEW.

ITEMS	REQ'D?	COMMENTS
REINF. STEEL PLACEMENT	YES	INSPECT FINAL PLACEMENT
CONC. COMPRESSIVE TESTS	YES	
CONC. SLUMP	YES	


\* CONCRETE POURS IN WINTER MONTHS TO HAVE MIN. 2 SETS LAB CURED AND 2 SETS FIELD CURED.

2025-02	30.00
PROJECT NUMBER: 25-013	




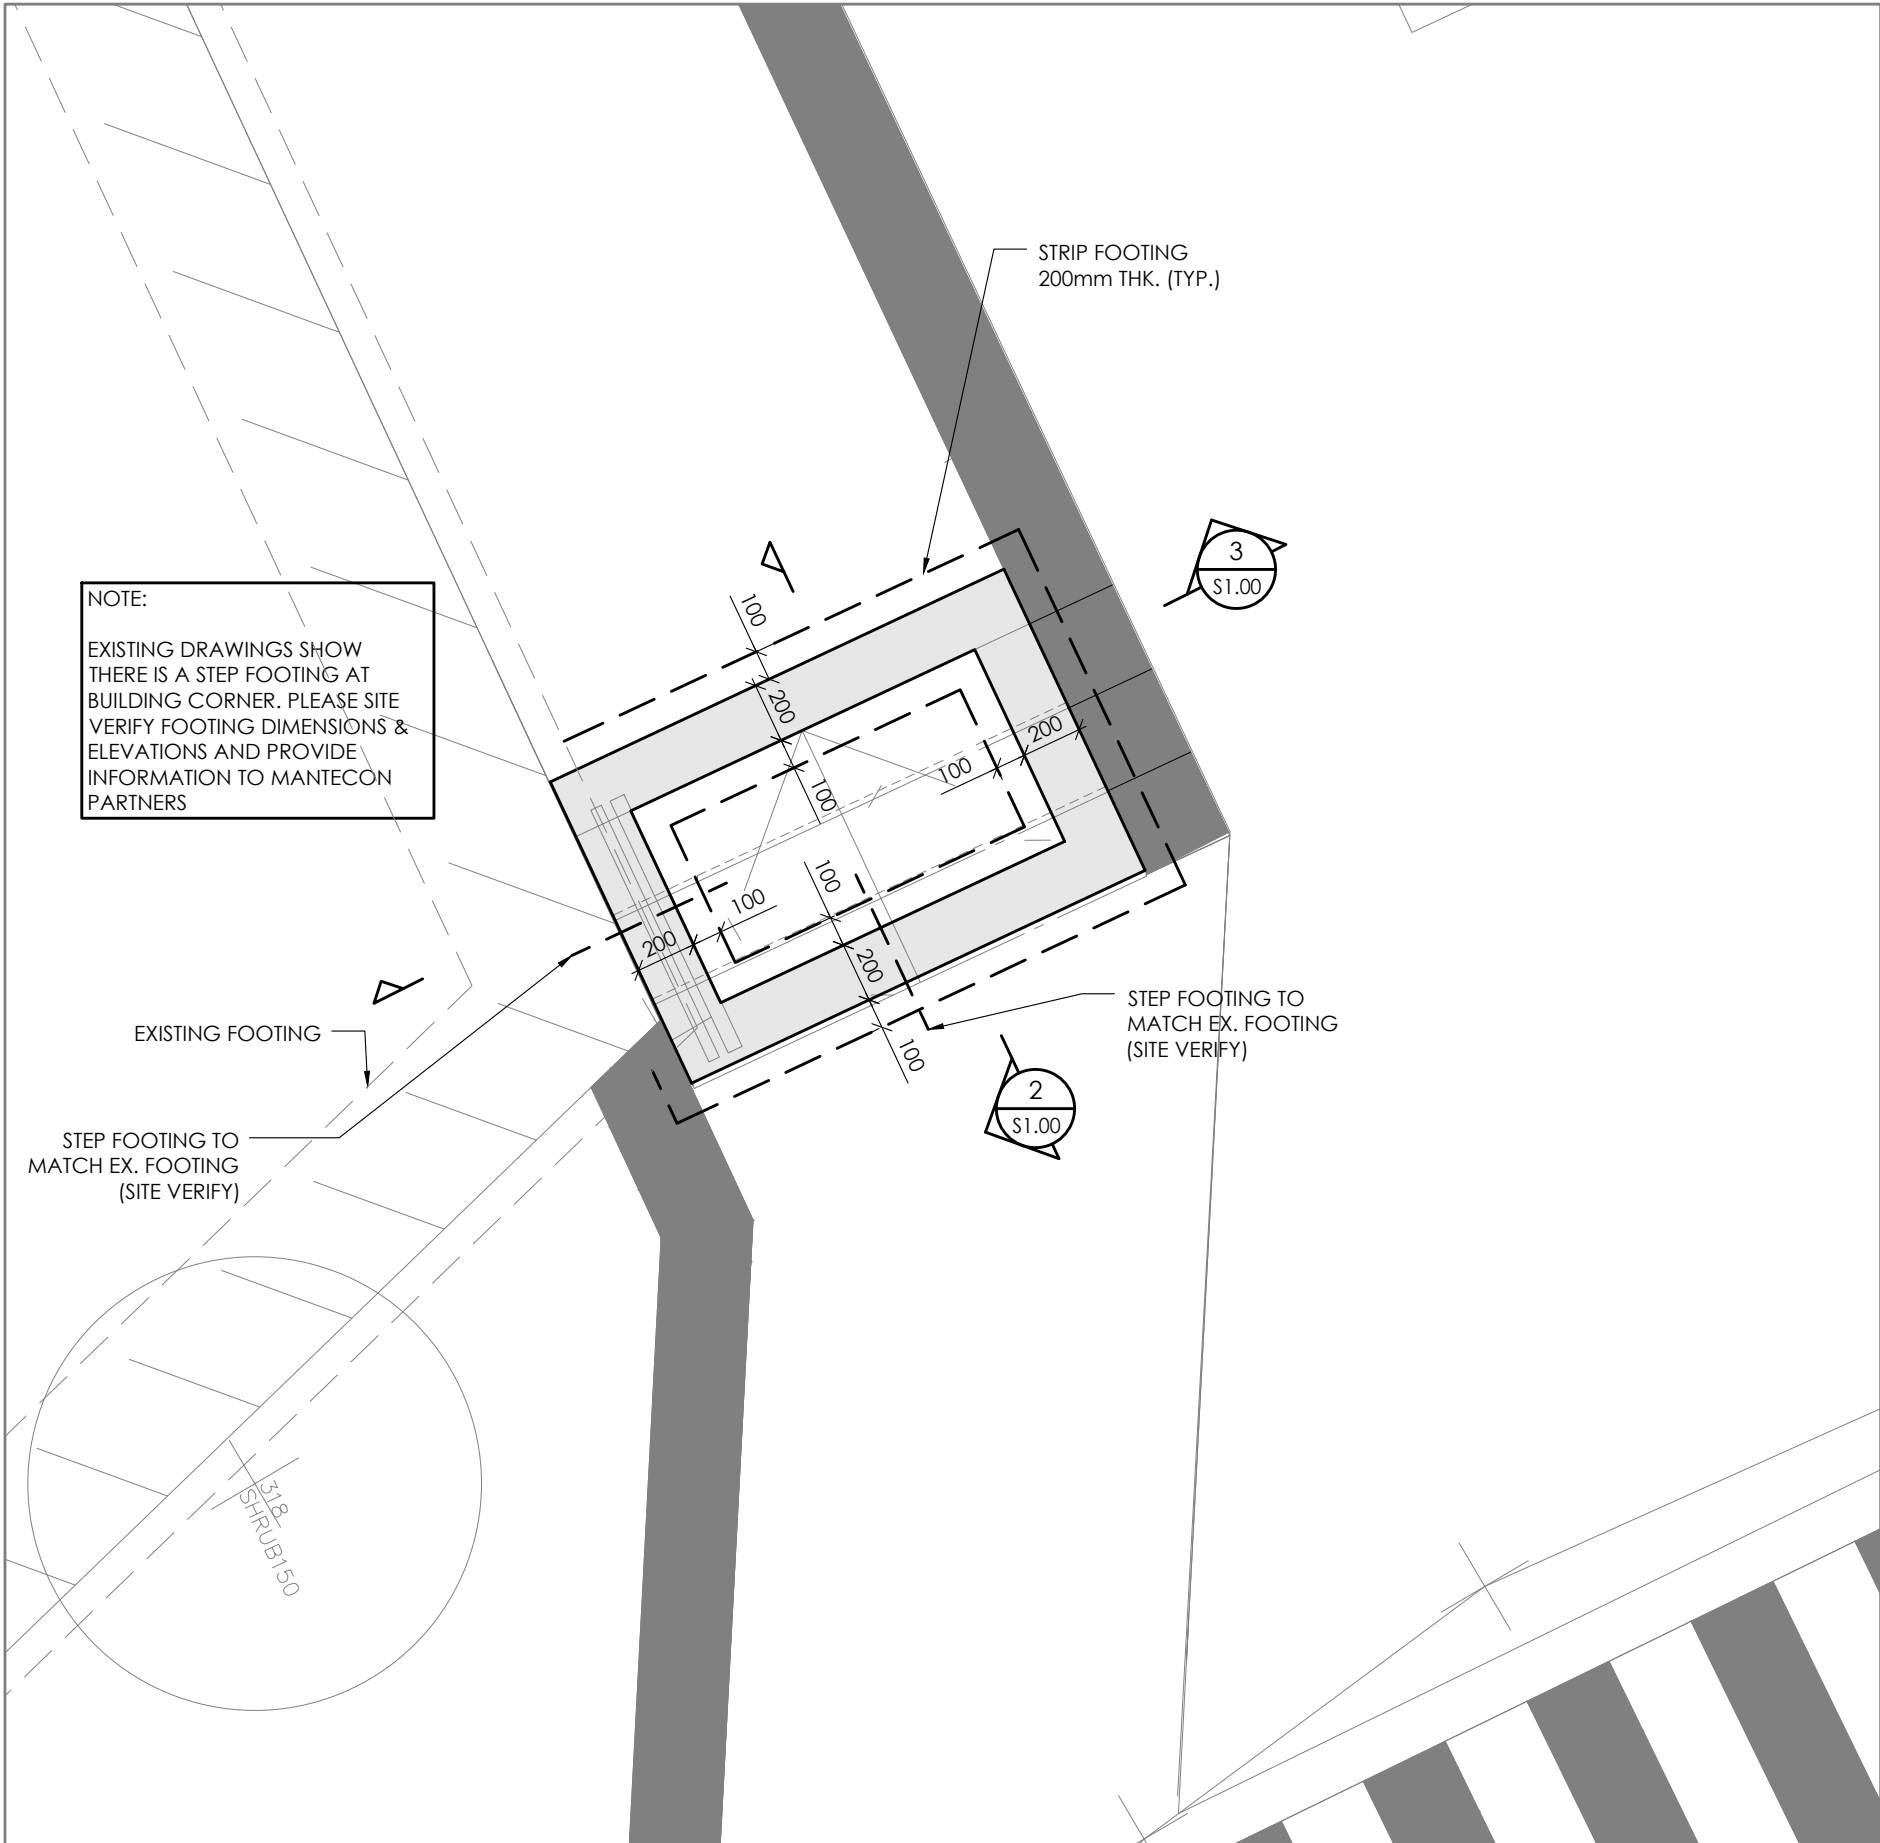


1 FOUNDATION PLAN 1  
SCALE: 1:25

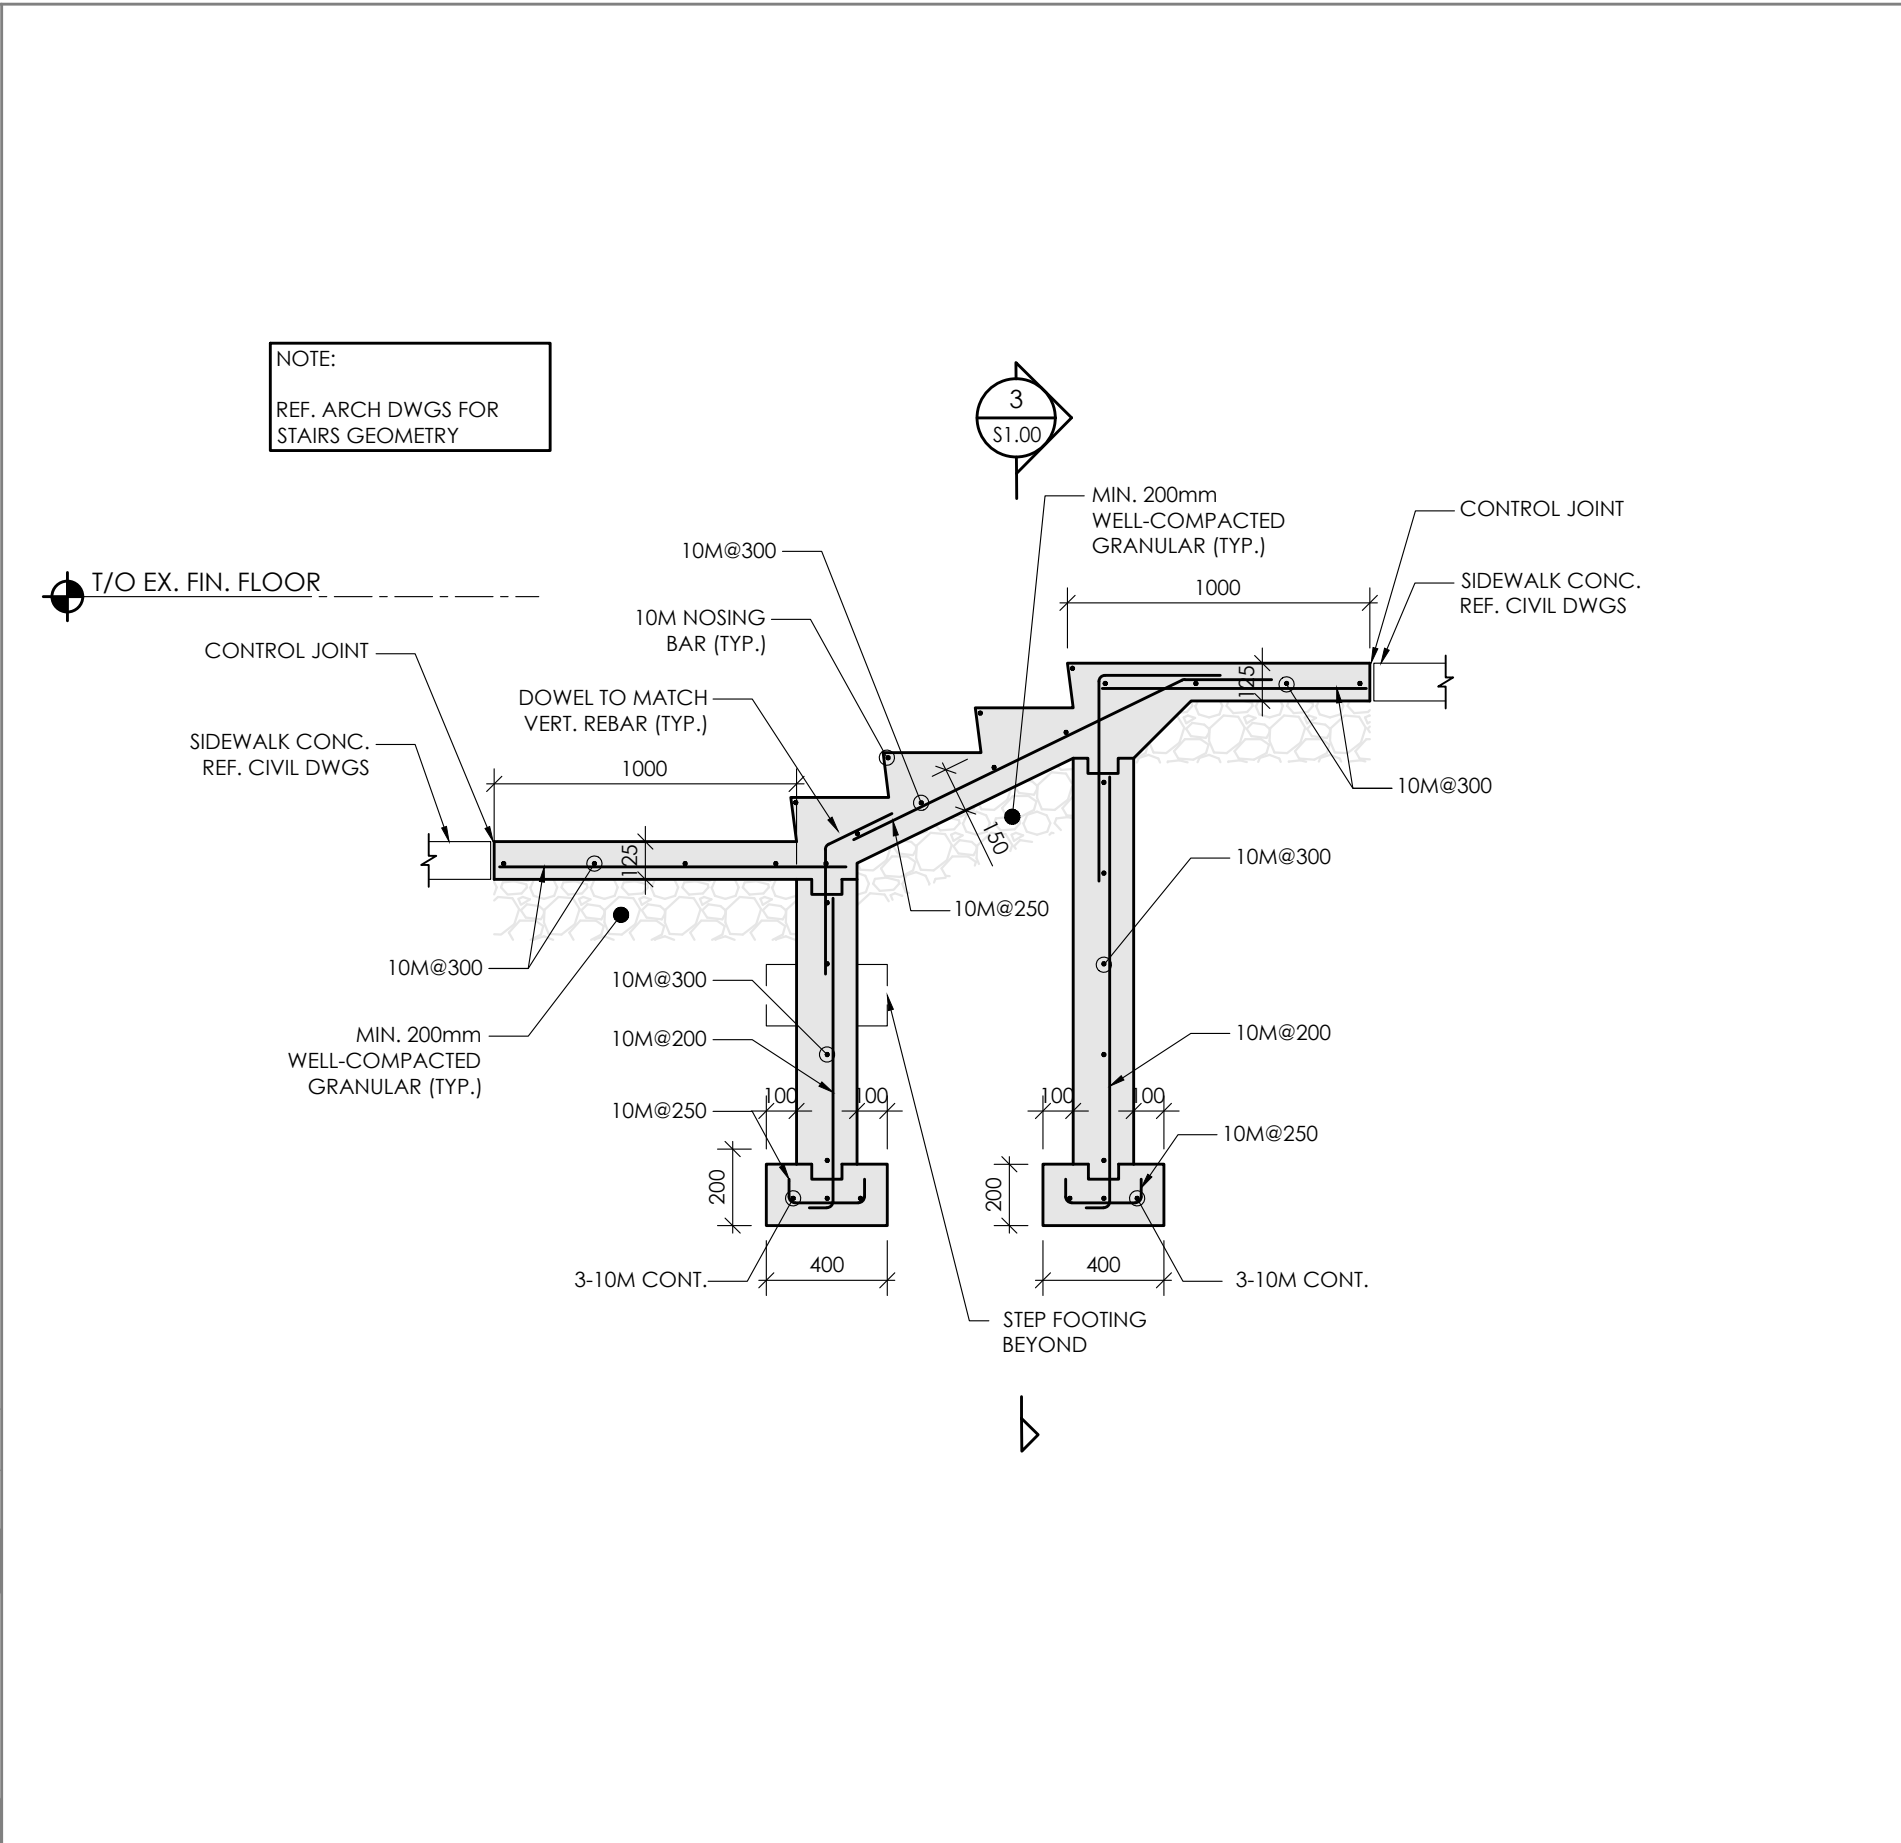


2 SECTION  
SCALE: 1:25

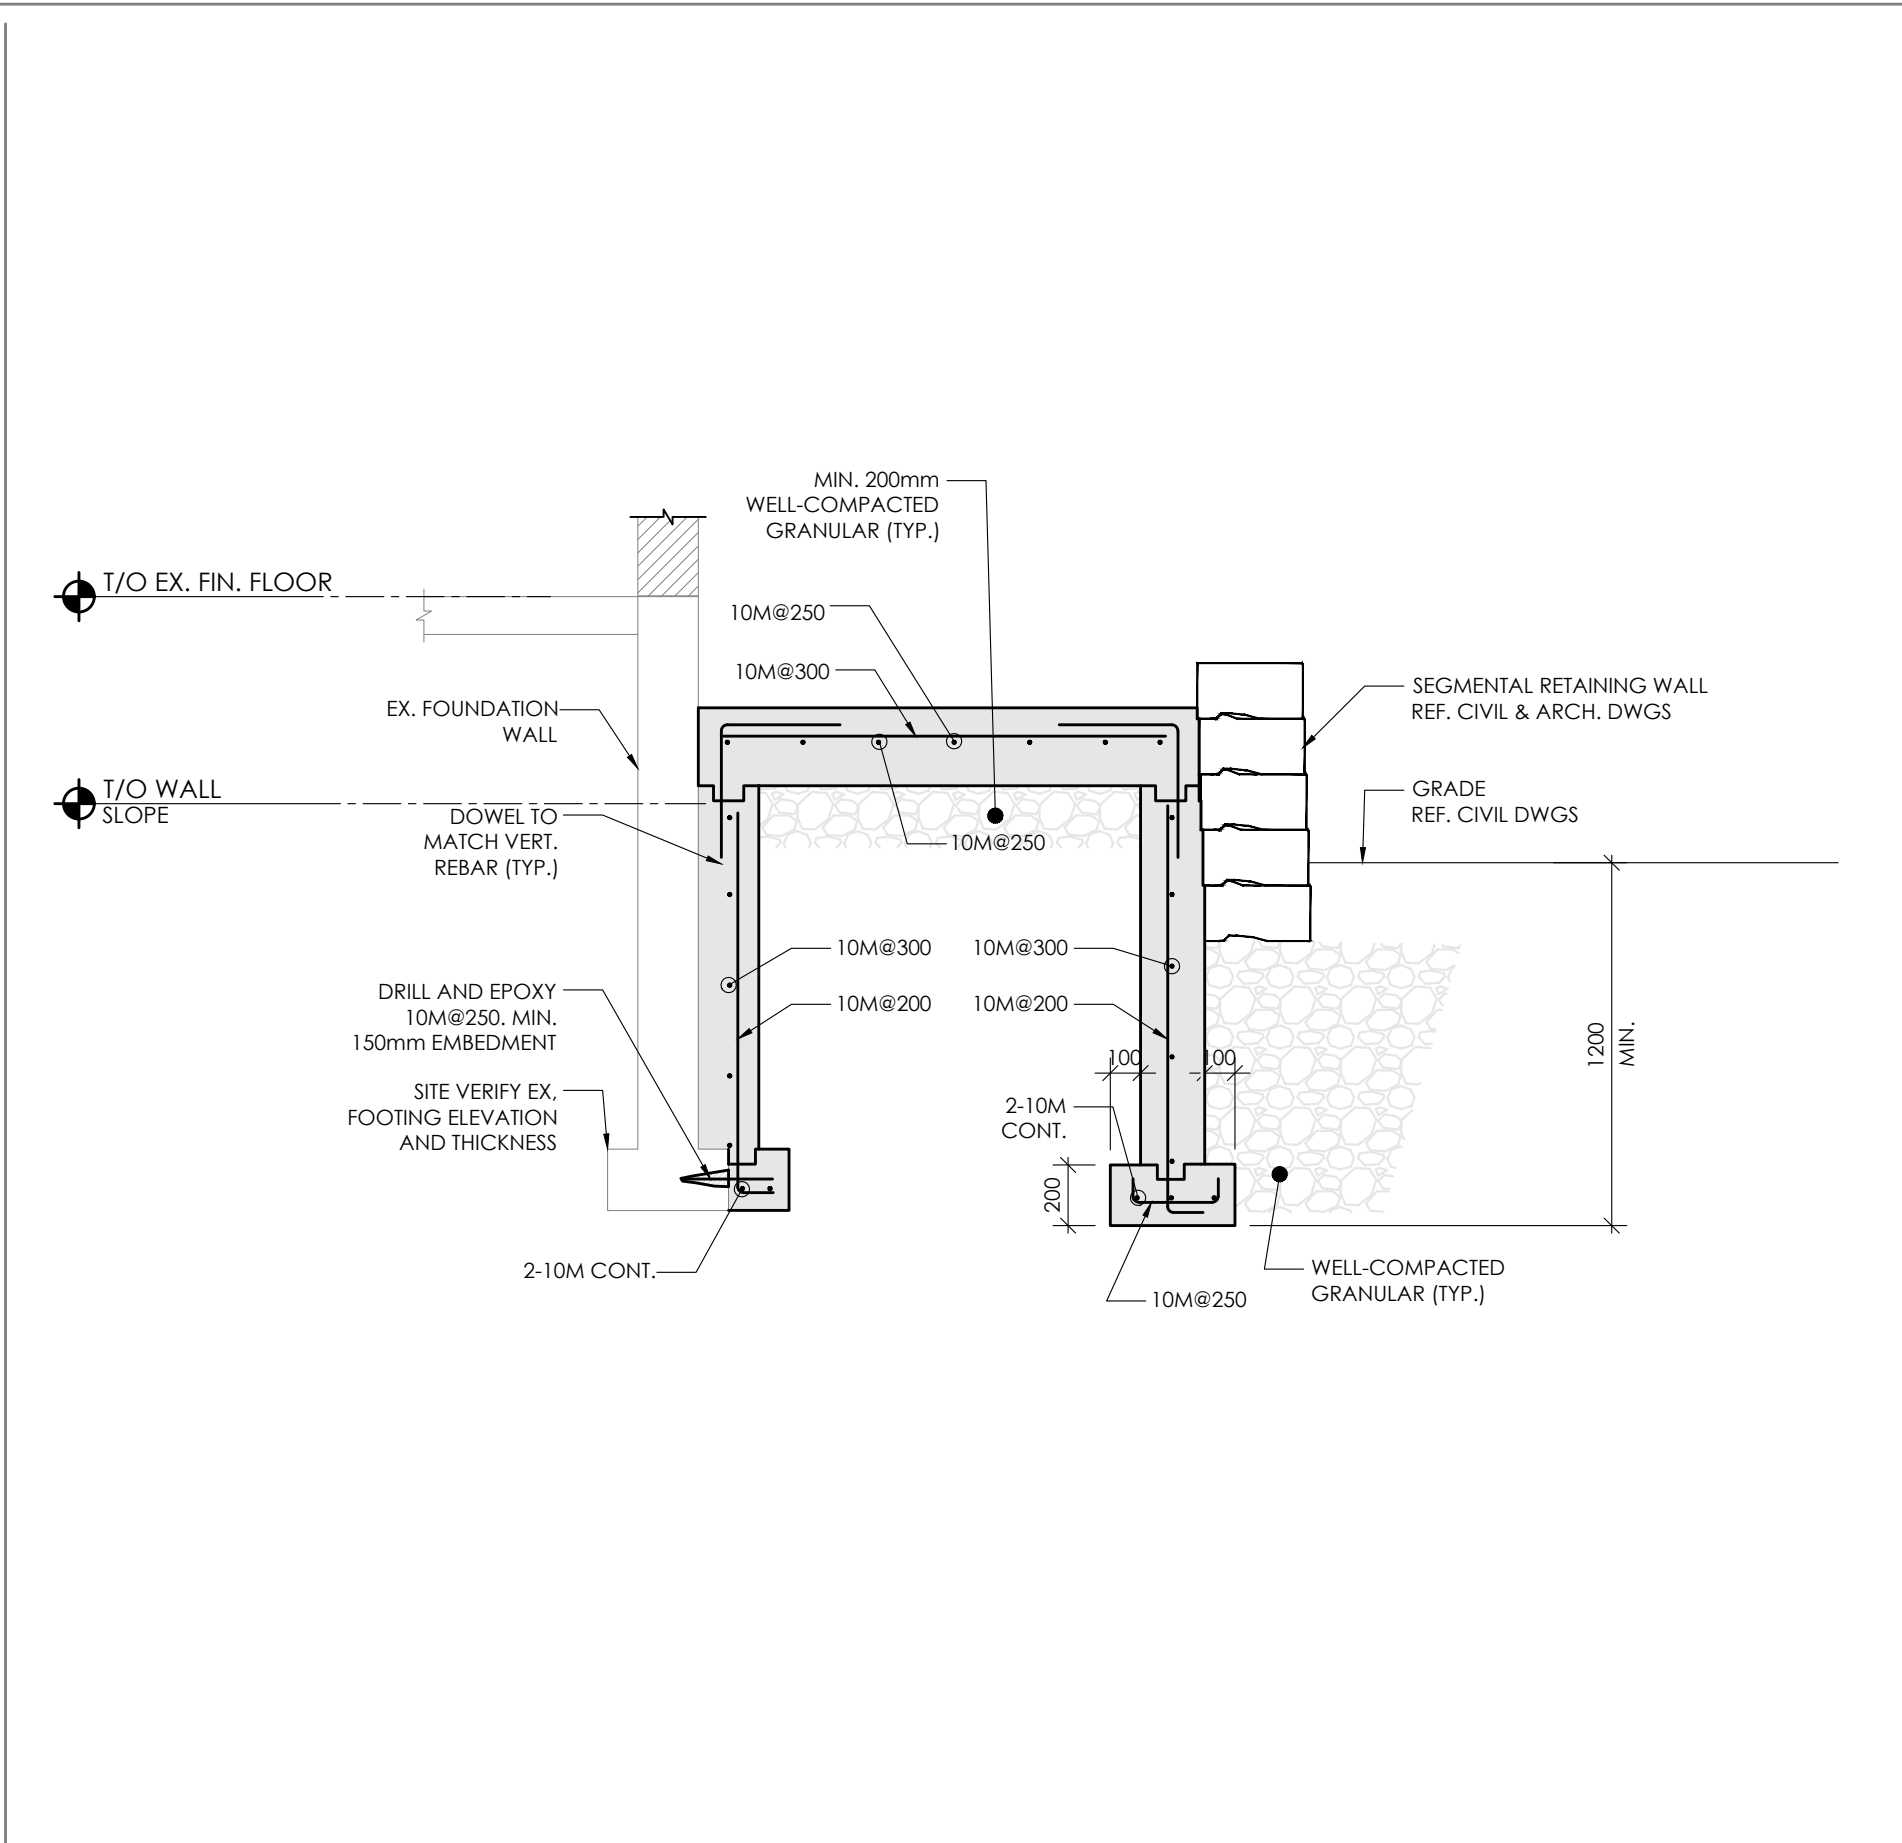


3 SECTION  
SCALE: 1:25

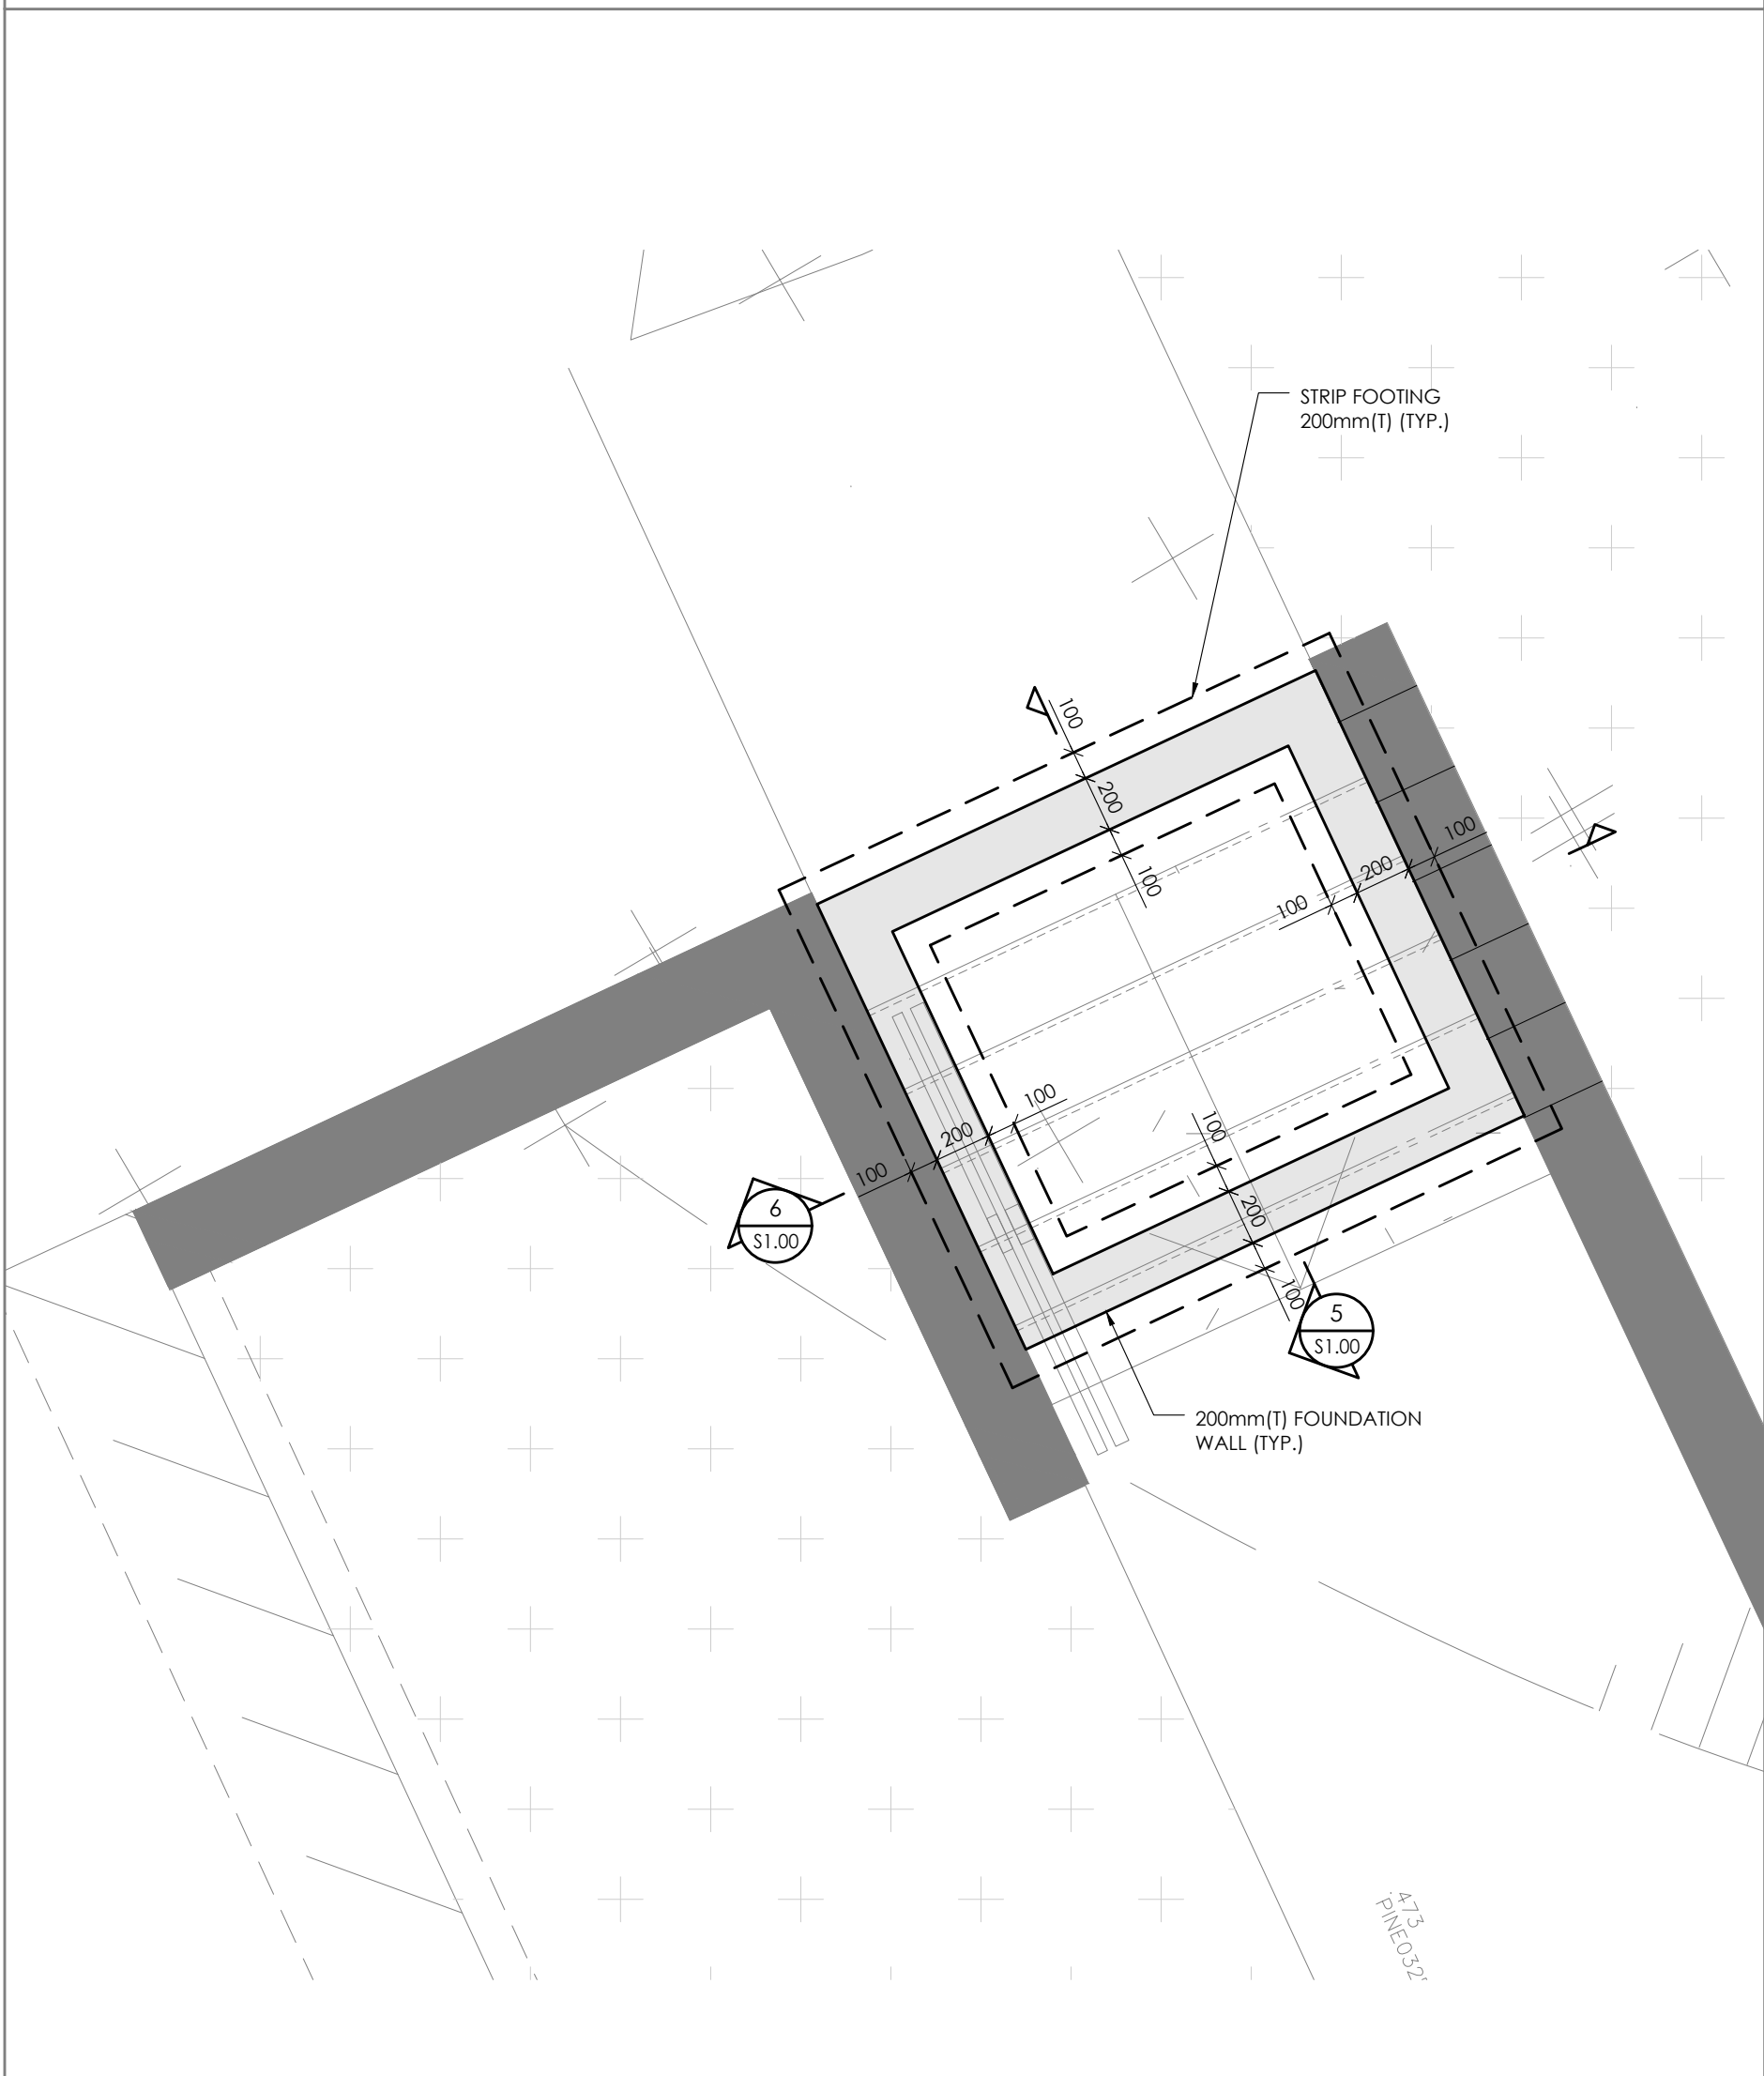

4 FOUNDATION PLAN 2  
SCALE: 1:25

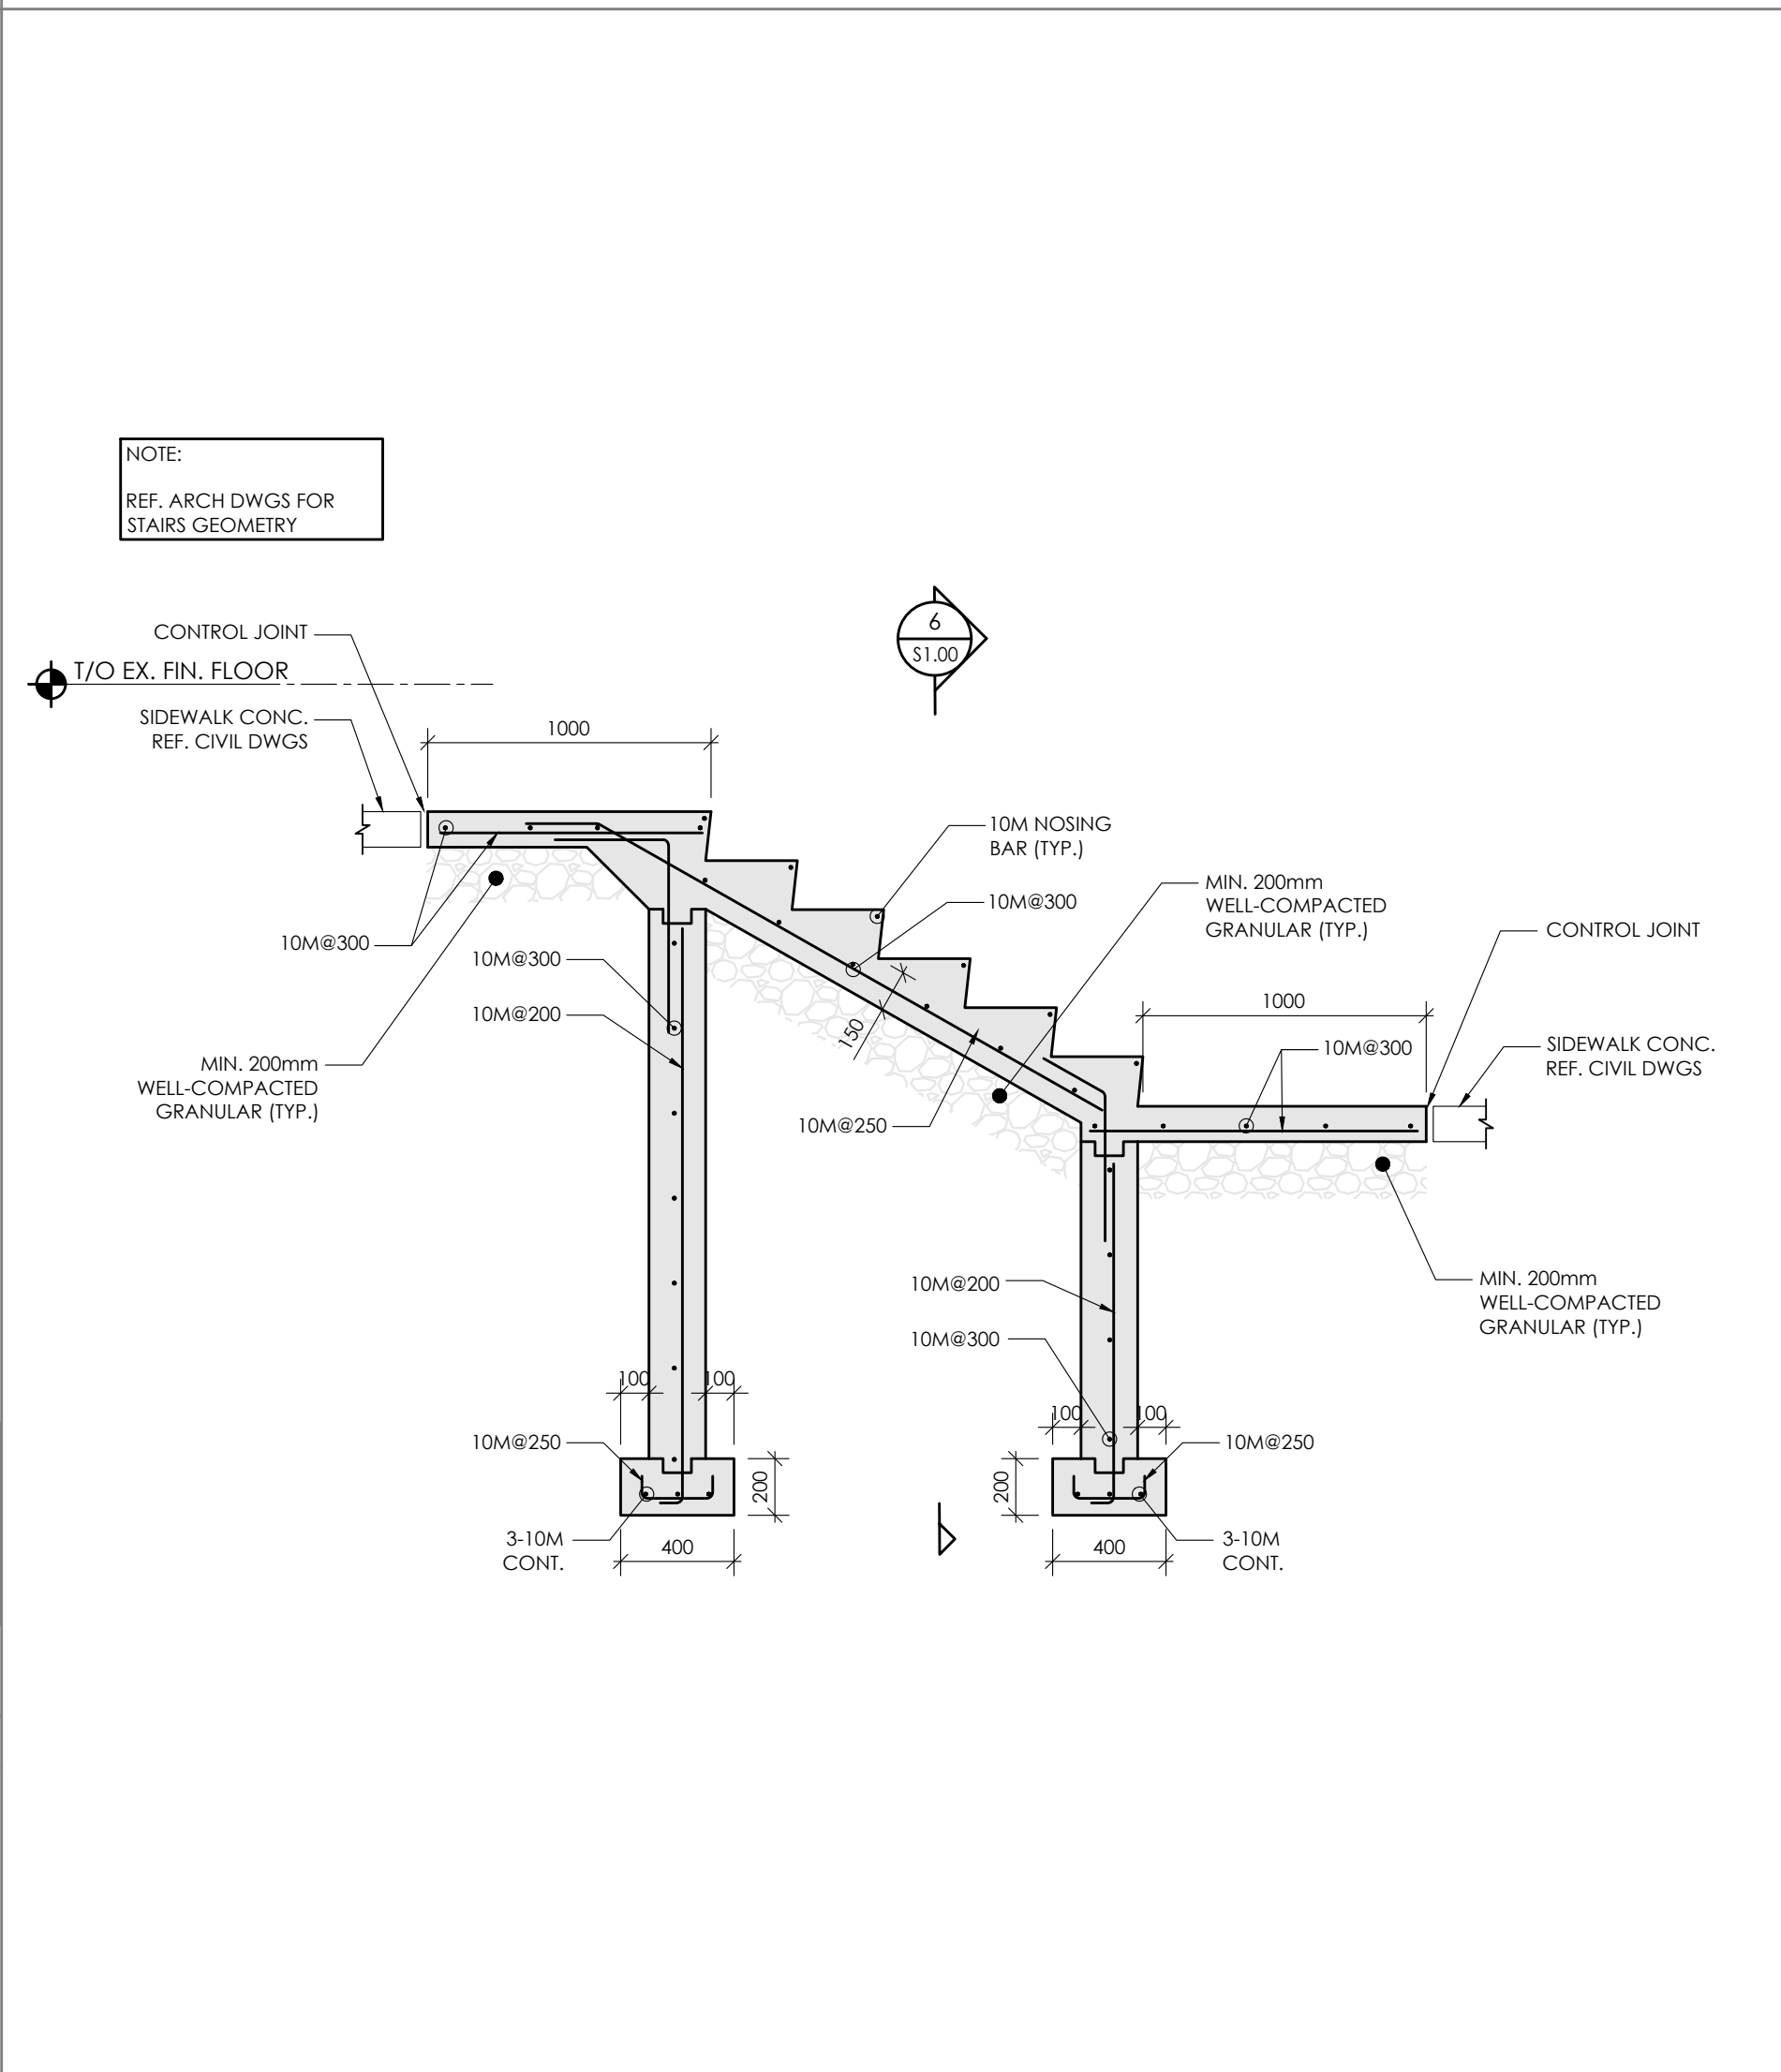

5 SECTION  
SCALE: 1:25

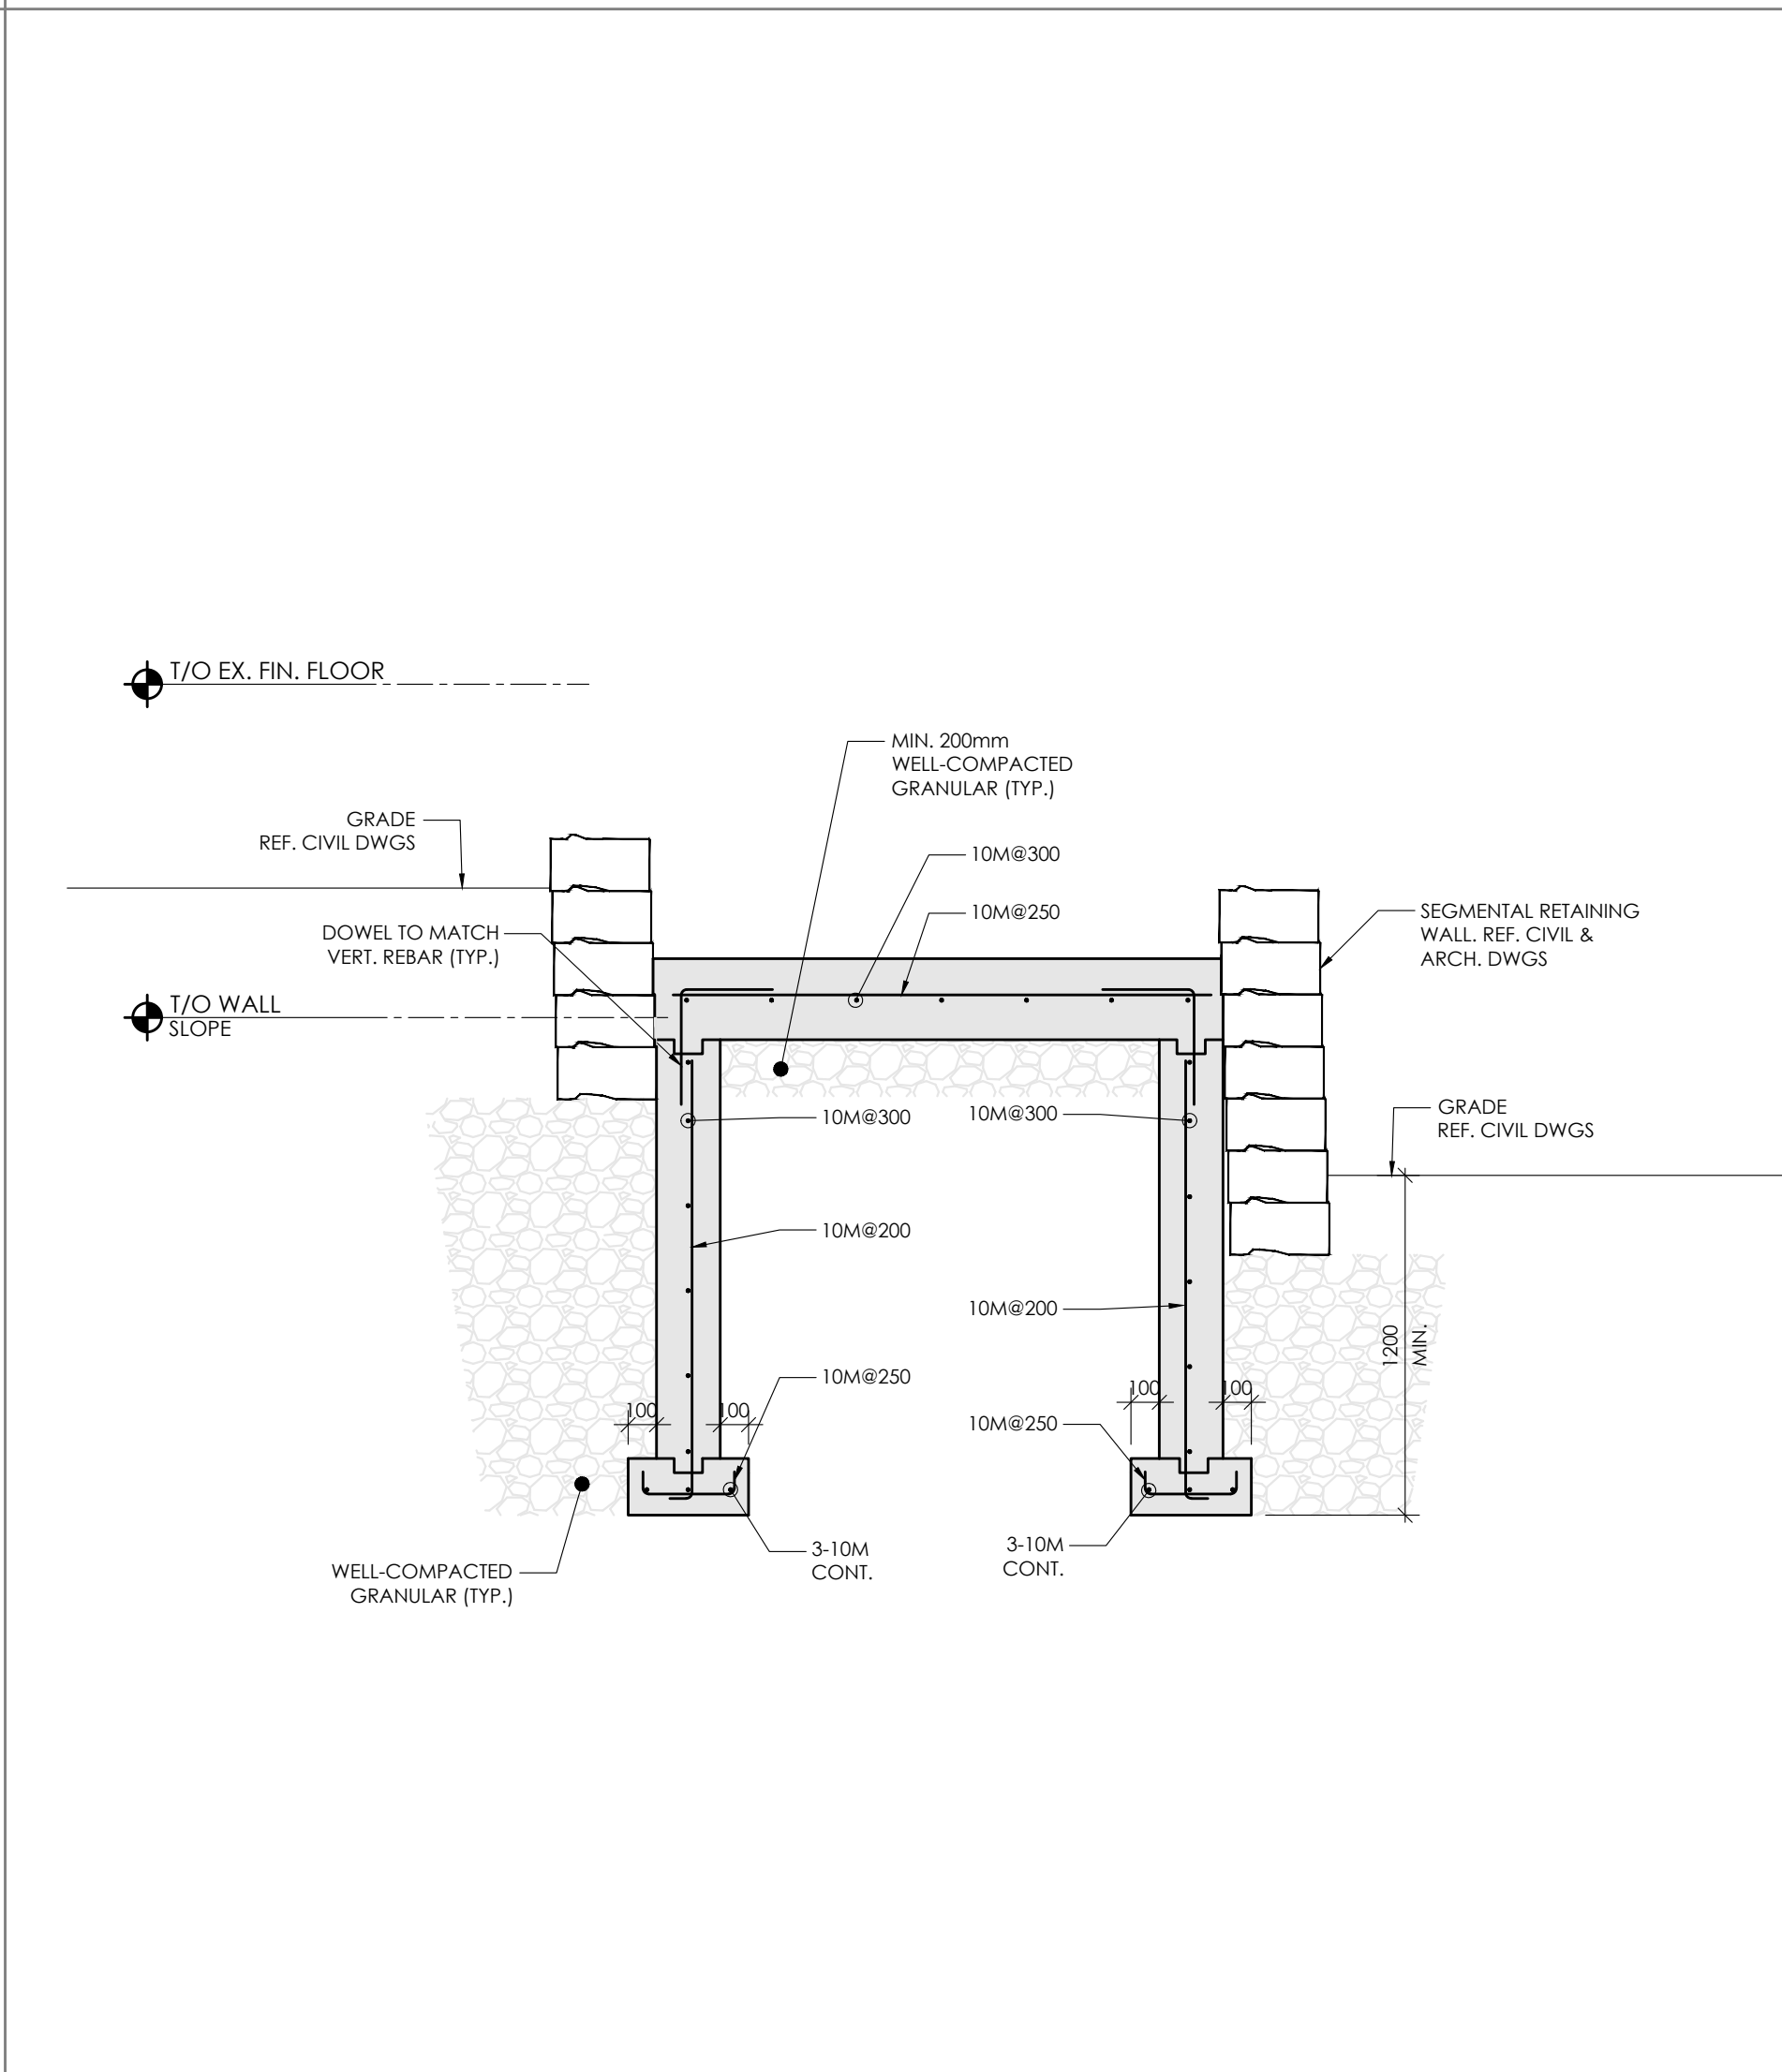

6 SECTION  
SCALE: 1:25

TRUE NORTH

CONSTRUCTION NORTH

MANTECON

PARTNERS

STRUCTURAL MECHANICAL ELECTRICAL CIVIL  
ENGINEERS  
15 Foundry Street, Dundas, ON, L9H 2V6  
Phone: (905) 648-0373  
www.manteconpartners.com

SEAL

LICENSED PROFESSIONAL ENGINEER

S. C. MILLER

10007446

JUNE 3/25

PROVINCE OF ONTARIO

REVIEW ALL DRAWINGS AND VERIFY ALL DIMENSIONS AT THE SITE. DO NOT SCALE THE DRAWINGS. REPORT ALL DISCREPANCIES TO THE ENGINEER BEFORE PROCEEDING WITH ANY CONSTRUCTION OR SHOP FABRICATION. ALL DRAWINGS, SPECIFICATIONS AND RELATED DOCUMENTS ARE THE COPYRIGHT PROPERTY OF "MANTECON PARTNERS" AND MUST BE RETURNED UPON REQUEST. REPRODUCTION OF DRAWINGS, SPECIFICATIONS AND RELATED DOCUMENTS IN PART OR WHOLE IS FORBIDDEN WITHOUT THE ENGINEER'S WRITTEN PERMISSION.

NO.	ISSUED	DATE	BY
3	ISSUED FOR CONSTRUCTION	2025-05-28	D.N.
2	ISSUED FOR PERMIT & TENDER	2025-04-17	D.N.
1	ISSUED FOR TENDER	2025-04-11	D.N.

WORKSHOP

CLIENT:  
BLAIR ROAD PUBLIC SCHOOL

PROJECT:  
BLAIR ROAD PUBLIC SCHOOL  
PARKING LOT EXPANSION

85 SUNSET BLVD, CAMBRIDGE  
ONTARIO, N1S 1A9

DRAWING TITLE:  
FOUNDATION PLANS &  
SECTIONS

DRAWN BY:  
D.N.

CHECKED BY:  
S.M.

DATE:  
2025-02

PROJECT NUMBER:  
25-013

SCALE:  
AS INDICATED

DRAWING NUMBER:  
S1.00

May 26, 2025 - 10:41am Plotted by: dnguyen

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C0.00	GENERAL NOTES
C0.01	TYPICAL DETAILS
C1.00	SITE GRADING PLAN
C1.01	RETAINING WALL SECTION DETAILS
C2.00	SITE SERVICING PLAN
C3.00	SEDIMENT AND EROSION CONTROL PLAN

1. EXISTING UNDERGROUND SERVICE INFORMATION IS DERIVED FROM EXISTING DRAWINGS AND HAS NOT BEEN LOCATED BY THE UTILITY COMPANIES. MANTECON PARTNERS ASSUME NO RESPONSIBILITY AS TO THE ACCURACY, CORRECTNESS AND COMPLETENESS OF THE UNDERGROUND SERVICE INFORMATION SHOWN ON THIS PLAN.
2. THE CONTRACTOR IS RESPONSIBLE FOR RESTORATION OF ALL DAMAGED AND/OR DISTURBED PROPERTY WITHIN THE LIMIT OF MUNICIPAL RIGHT-OF-WAY TO CITY OF CAMBRIDGE STANDARDS.
3. ALL WORK AND MATERIALS SHALL BE IN COMPLIANCE WITH CITY OF CAMBRIDGE, LOCAL UTILITY, MINISTRY OF THE ENVIRONMENT, AND ONTARIO PROVINCIAL STANDARDS AND SPECIFICATIONS, CURRENT PROVINCIAL BUILDING CODE, AS WELL AS ALL APPLICABLE HEALTH AND SAFETY ACT AND REGULATIONS FOR CONSTRUCTION PROJECTS.
4. EXISTING ELEVATIONS AND LOCATION OF EXISTING SERVICES ARE NOT GUARANTEED. CONTRACTOR TO NOTIFY ENGINEER OF ANY DISCREPANCIES MINIMUM 48 HOURS PRIOR TO THE COMMENCEMENT OF ANY WORK. ALL EXISTING UTILITIES SHOWN ON THE DRAWINGS ARE FOR INFORMATION PURPOSES ONLY. THE CONTRACTOR SHALL CONTACT THE UTILITY COMPANIES FOR UTILITY STAKEOUTS, IF REQUESTED BY THE CITY, MINISTRY OF TRANSPORTATION AND/OR ENGINEER. THE CONTRACTOR TO EXPOSE EXISTING SERVICES TO VERIFY EXACT LOCATION, PRIOR TO STARTING CONSTRUCTION.
5. THE CONTRACTOR SHALL BE RESPONSIBLE FOR ANY DAMAGE CAUSED TO THE EXISTING UTILITIES DURING CONSTRUCTION, OR DUE TO ITS CONSTRUCTION ACTIVITIES.
6. DEWATERING, IF REQUIRED, SHALL BE THE RESPONSIBILITY AND SOLE EXPENSE OF THE CONTRACTOR. REFER TO THE GEOTECHNICAL REPORT EXISTING SITE CONDITIONS.
7. PERMITS REQUIRED FOR ROADWORK AND RIGHT-OF-WAYS SHALL BE OBTAINED FROM THE LOCAL GOVERNING MUNICIPALITIES PUBLIC WORKS DEPARTMENT 48 HOURS PRIOR TO COMMENCING ANY WORK WITHIN CITY RIGHT-OF-WAYS. THE CONTRACTOR IS TO PAY AND COORDINATE ALL REQUIRED PERMITS FOR ROADWORK WITH THE CITY.
8. ROAD OCCUPANCY PERMIT IS REQUIRED FROM THE PUBLIC WORKS DEPARTMENT 48 HOURS PRIOR TO WORKING WITHIN ANY CITY RIGHT-OF-WAY.
9. THE CONTRACTOR IS RESPONSIBLE FOR COORDINATING ALL WORK ON SITE WITH OTHER CONTRACTORS TO PREVENT CONFLICTS.
10. ALL AREAS ON PLAN, INCLUDING EXISTING CONCRETE SIDEWALKS, WHICH ARE DISTURBED DURING CONSTRUCTION SHALL BE RESTORED TO ORIGINAL CONDITION OR BETTER. GRASSED AREAS SHALL BE RESTORED WITH SOD ON MINIMUM 150mm OF TPOFILL.
11. POSITIVE DRAINAGE SHALL BE PROVIDED THROUGHOUT THE SITE AT ALL TIMES DURING CONSTRUCTION ACTIVITIES.
12. THE CONTRACTOR IS RESPONSIBLE FOR ALL REMOVALS AND SHALL ENSURE THEIR OFFSITE DISPOSAL.
13. THE GENERAL NOTES MUST BE READ IN CONJUNCTION WITH THE DESIGN DRAWINGS AND SPECIFICATIONS OF ENGINEERING AND ARCHITECTURAL DISCIPLINES WHICH FORM PART OF THIS CONTRACT. THIS INCLUDES DRAWING SPECIFICATIONS AND SKETCHES. SHOULD THERE BE CONTRADICTORY INFORMATION BETWEEN DRAWINGS, SKETCHES AND/OR SPECIFICATIONS, THE MOST STRINGENT GOVERNS.
14. THE CONTRACTOR SHALL BE RESPONSIBLE FOR PROVIDING AN AS BUILT TOPOGRAPHIC SURVEY UPON COMPLETION OF THE CONSTRUCTION WORK TO VERIFY COMPLIANCE WITH THE DESIGN AND LOCAL REGULATIONS. THE TOPOGRAPHIC SURVEY SHALL BE CONDUCTED BY A PROFESSIONAL LAND SURVEYOR.
15. THE FOLLOWING ITEMS SHALL BE SUBMITTED TO THE ENGINEER FOR REVIEW PRIOR TO FABRICATION.

ITEMS	REQUIRED SUBMITTAL?	ENGINEER'S STAMP REQUIRED?	NOTES
CONCRETE MIX DESIGNS	YES		
ASPHALT MIX DESIGNS	YES		
AGGREGATE GRADATION	YES		
SEWER APPURTENANCES	YES		

1. NATIVE BACKFILL MATERIAL SHOULD BE COMPACTED TO 98% STANDARD PROCTOR DENSITY. GRANULAR BACKFILL MATERIAL SHALL BE PLACED IN LAYERS 150mm IN DEPTH AND COMPACTED TO 98% STANDARD PROCTOR DENSITY.
2. PAVEMENT SHALL BE AS FOLLOW:

<u>PAVEMENT COMPONENT</u>	<u>THICKNESS (mm)</u>
ASPHALT SURFACING -HL3	40mm
ASPHALT SURFACING -HL8	50mm
GRANULAR "A" BASE	175mm
GRANULAR "B" TYPE II SUBBASE	350mm

4. SUBMIT ASPHALT MIX DESIGN AND TRIAL MIX TEST RESULTS TO CONSULTANT FOR APPROVAL.
5. 4. PROOF ROLLING OF SUBGRADE SHALL BE INSPECTED BY THE GEOTECHNICAL CONSULTANT.
6. PLACE GRANULAR BASE TO COMPACTED THICKNESS AS INDICATED, DO NOT PLACE FROZEN MATERIAL.
7. ASPHALT MATERIALS SHALL BE ROLLED AND COMPACTED TO A MINIMUM OF 97% MRD.
8. PROOF ROLLING OF ASPHALT SHALL BE INSPECTED BY THE GEOTECHNICAL CONSULTANT.
9. IF PAVEMENT CONSTRUCTION OCCURS IN WET, INCLEMENT WEATHER THE CONTRACTOR SHALL DISCUSS ADDITIONAL SUBGRADE SUPPORT WITH THE GEOTECHNICAL CONSULTANT AND PROVIDE ADDITIONAL GRANULAR SUB-BASE BASED ON THE GEOTECHNICAL CONSULTANT'S RECOMMENDATIONS.
10. BACKFILL MATERIAL AND COMPACTON SHOULD BE IN CONFORMANCE WITH THE GEOTECHNICAL REPORT.
11. THE CONTRACTOR SHALL BE RESPONSIBLE FOR PROVIDING AN AS BUILT TOPOGRAPHIC SURVEY UPON THE COMPLETION OF CONSTRUCTION WORK TO VERIFY COMPLIANCE WITH THE DESIGN LOCAL REGULATIONS. THE TOPOGRAPHIC SURVEY SHALL BE CONDUCTED BY A PROFESSIONAL LAND SURVEYOR.

1. ALL BARRIER CURB WITHIN SITE TO BE OPSD 600,110, ALL CURB DEPRESSIONS ACROSS ENTRANCE TRANSVERSE TO BE AS PER CITY STANDARD DRAWING OR MUNICIPAL STANDARDS.
2. CURBS AT ALL PEDESTRIAN CONNECTIONS/CROSSING TO BE RECESSED CURBS, FLUSH WITH PAVEMENT SURFACE.
3. CONCRETE TO BE 35MPa COMPRESSIVE AT 28 DAYS WITH 5% TO 7% AIR ENTRAINMENT.
4. EXPANSION JOINTS SHALL BE LOCATED AT A MAXIMUM 4.5m ON CENTRE AND WHERE CONCRETE MEETS OTHER HARD SURFACES AND STRUCTURES. (COORDINATE WITH LANDSCAPE/ARCHITECT DRAWINGS)
5. CONSTRUCTION JOINTS WITH DOUBLE EDGER IN FRESH CONCRETE THEN SAWCUT TO A DEPTH OF 30mm. JOINTS SHALL BE SPACED AT MAXIMUM 1.5 METRES ON CENTRE. (COORDINATE WITH LANDSCAPE/ARCHITECT DRAWINGS)
6. SLUMP OF CONCRETE SHALL BE 80mm.
7. CONCRETE CURB TO BE AS PER OPSD 600,110.

1. CONCRETE MATERIALS AND METHODS OF CONCRETE CONSTRUCTION, TESTING AND STANDARD PRACTICES FOR CONCRETE SHALL BE IN ACCORDANCE WITH CSA STANDARD A23.1/A23.2 (LATEST EDITION).
2. CONCRETE DESIGN SHALL BE IN THE DESIGN OF CONCRETE STRUCTURES CSA STANDARD A23.3 (LATEST EDITION).
3. SUPPLY AND PLACE CONCRETE IN ACCORDANCE TO TABLE 1:

LOCATION	MINIMUM COMPRESSIVE STRENGTH (f <sub>c</sub> ) AT 28 DAYS MPa (PSI)	SLUMP mm (in)	EXPOSURE CLASS	AIR CONTENT (%)
SIDEWALK/CURBS PAVING SLABS, EXTERIOR CONCRETE	35 (5000)	40 ± 20 (1-1/2 ± 3/4)	C-2	5-8

4. PAVEMENT SHALL BE:

PAVEMENT COMPONENT	THICKNESS (mm)
CONCRETE PAVERS	AS NOTED
CONCRETE SLAB	125 (UNLESS OTHERWISE NOTED)
GRANULAR "A" BASE	100
GRANULAR "B" BASE	200 (UNLESS OTHERWISE NOTED)

5. GRANULAR BASE LAYERS SHALL BE COMPACTED TO MIN. 98% STANDARD PROCTOR DENSITY.
6. THE COMPRESSIVE STRENGTH OF THE CONCRETE IS BASED ON THE FOLLOWING CONDITIONS:
  - a. TYPE GU NORMAL PORTLAND CEMENT UNLESS OTHERWISE NOTED OR APPROVED.
  - b. MAXIMUM SIZE OF AGGREGATE 20mm (3/4") WASHED IRREGULAR CUL CLEAR STONE, EXCEPT FOR CONCRETE TOPPING WHICH SHALL HAVE MAXIMUM SIZE OF AGGREGATE 10mm (3/8") WASHED IRREGULAR CUL CLEAR STONE.
  - c. SLUMP SHOWN ON THE TABLE IS SLUMPED WITHOUT SLUMP AD MIXTURE. WHERE THE USE OF AN AD MIXTURE IS REQUIRED TO INCREASE THE SLUMP, THE SUPERPLASTICIZED CONCRETE SLUMP MUST REMAIN BELOW THE POINT AT WHICH SEGREGATION WILL OCCUR.

1. THE FOLLOWING ITEMS REQUIRE TESTING OR INSPECTION BY A CERTIFIED INDEPENDENT TESTING OR INSPECTION AGENCY PAID BY OWNER. THE AGENCY SHALL SEND COPIES OF ALL STRUCTURAL TESTING AND INSPECTION REPORTS TO THE ENGINEER FOR REVIEW.

ITEMS	REQUIRED?	COMMENTS
SOIL BEARING CAPACITY	YES	BY SOILS ENGINEER
SOIL COMPACTION	YES	BY SOILS ENGINEER
CONCRETE COMPRESSIVE TESTS	YES	MINIMUM 2 SETS PER EACH 50m³
CONCRETE SLUMP	YES	

1. ALL BEDDING AND BACKFILL MATERIAL, ROAD SUB-GRADES AND GENERALLY ALL MATERIAL USED FOR LOT GRADING AND FILL SECTIONS, ETC., SHALL BE COMPACTED TO MIN. 95% SPD (UNLESS OTHERWISE RECOMMENDED BY THE GEOTECHNICAL ENGINEER). ALL MATERIAL SHALL BE PLACED IN LAYERS NOT EXCEEDING 300mm LIFTS.
2. ALL GRANULAR ROAD BASE MATERIALS SHALL BE COMPACTED TO 98% SPD.
3. FOR ALL SEWERS AND WATERMAINS IN FILL SECTIONS, THE COMPACTION SHALL BE CERTIFIED BY A GEOTECHNICAL ENGINEER PRIOR TO LAYING OF PIPE.

1. ALL SERVICES TO BE INSTALLED AS PER THE LATEST CITY STANDARDS AND SPECIFICATIONS MANUAL.
2. MINIMUM AND MAXIMUM DESIGN REQUIREMENT FOR VELOCITIES 0.80 to 6.0m/s FOR STORM SERVICE.
3. MINIMUM BEDDING REQUIREMENTS FOR ALL SINGLE STORM AND SANITARY SEWER MAINS AND ALL RELATED CONNECTIONS SHALL BE CLASS B BEDDING AS PER THE REGION OF WATERLOO STANDARD DRAWING 55MS E-01.
4. THE TRENCH ABOVE THE SPECIFIED BEDDING SHALL BE BACKFILLED WITH APPROVED NATIVE MATERIAL EXCAVATED FROM THE TRENCH OR OBTAINED ELSEWHERE ON THE PROJECT, AND SHALL BE PLACED IN LAYERS NOT EXCEEDING 300 mm. AND SHALL BE COMPACTED TO 98% STANDARD PROCTOR MAXIMUM DRY DENSITY.
5. ALL MANHOLE AND CATCH BASIN EXCAVATIONS TO BE BACKFILLED WITH GRANULAR MATERIAL WITHIN 300mm OF THE STRUCTURE AND COMPACTED TO 98% STANDARD PROCTOR DENSITY.
6. SEWER BEDDING, COVER AND BACKFILL SHALL BE WITH GRANULAR A COMPACTED TO 100% SPMD AND IN ACCORDANCE WITH THE REGION OF WATERLOO GUIDELINES.
7. STORM AND SANITARY TO BE INSTALLED WITH A MINIMUM 275m COVER AT THE PROPERTY LINE BELOW THE FINAL ROAD GRADE OR AT SUCH HIGHER ELEVATION ONLY AS MAY BE NECESSITATED BY THE LEVEL OF THE MAIN SEWER. ON PRIVATE PROPERTY, THE MINIMUM COVER TO BE NOT TO LESS THAN 1.2m.
8. CONNECTIONS TO MANHOLES SHALL BE IN ACCORDANCE WITH OPS# 407 CONSTRUCTION SPECIFICATIONS PART 1000 MAINTENANCE HOLE, CATCH BASIN, DITCH INLET, AND VALVE CHAMBER INSTALLATION - SECTION 407.07.13 INSTALLATION OF INLET AND OUTLET PIPES INTO CONCRETE STRUCTURES C) RESILIENT CONNECTOR
9. MAINTENANCE HOLE FRAMES AND LIDS SHALL BE ADJUSTED SO THAT WHEN TESTED WITH A 3m STRAIGHT EDGE IN ANY DIRECTION OF THE SURFACE, THE GAP SHALL NOT EXCEED 7mm BETWEEN THE BOTTOM OF THE STRAIGHT EDGE AND THE SURFACE OF THE ASPHALT OR FRAME AND APPROPRIANCE.
10. ALL NEW MAINTENANCE HOLES SHALL BE FITTED WITH SELF-ADJUSTING MANHOLE FRAME AND COVER. THE FIRST DRAINAGE IRON WORKS (PRODUCT NO. 00320221), BIBBY-STE-CROX (AUTO STABLE C-50M-ON) OR STAR PIPE PRODUCTS (MH24SI, OR APPROVED EQUIVALENT ON REGION OF WATERLOO, ALL SELF-LEVELERS TO BE SUPPLIED WITH RUBBER GASKETS.
1. FOR MAINTENANCE HOLE DEPTHS BETWEEN 5.0 AND 10.0 m, A SAFETY GRATE MUST BE INSTALLED AT THE MID-POINT, FOR MAINTENANCE HOLE DEPTHS BETWEEN 10.0 AND 15.0 m, A SAFETY GRATE MUST BE INSTALLED AT THE THIRD POINTS, REFER TO OPSD 40.02.
2. STORM SEWERS SHALL BE PVC, BEL SPIGOT JOINTS, RUBBER GASKET, LUBRICANT AND ALL OTHER NECESSARY APPURTENANCES SHALL BE MANUFACTURED IN CONFORMANCE WITH OPS# 1841 AND SHALL BE CERTIFIED TO CSA B182/ FOR PVC SEWER PIPE AND FITTINGS OR CSA B182.4 FOR POLYESTER PVC SEWER PIPE AND FITTINGS; PVC PIPE SHALL HAVE A MINIMUM PIPE STIFFNESS OF 3 KPA.
3. ALL PVC STORM PIPES TO BE SDR-35 FOR 200mm DIAMETER AND OVER, AND SDR-26 FOR 150mm AND SMALLER TO CSA SPECIFICATIONS B182.2, PVC SANITARY PIPES TO BE SDR-35 FOR 150mm DIAMETER AND OVER, AND SDR-26 FOR 150mm AND SMALLER TO CSA SPECIFICATIONS B182.2.
4. WHERE SANITARY OR STORM CROSSING OCCURS WITH EXISTING OR PROPOSED WATERMAIN, ENSURE A MINIMUM OF 2.5m HORIZONTAL SEPARATION AND 0.5m VERTICAL SEPARATION BY INSTALLING A VERTICAL BEND IN WATERMAIN IF REQUIRED. WATERMAIN TO CROSS BELOW OTHER PIPE AT BENDS ARE PREVENTED. A MINIMUM SEPARATION OF 0.1m BETWEEN SANITARY AND STORM SEWER PIPES TO BE REQUIRED WHERE ONE SEWER PIPE CROSSES OVER THE OTHER.
5. ANY CHANGES IN GRADES AND CATCH BASINS REQUIRE THE APPROVAL OF THE DIRECTOR, DEVELOPMENT DIVISION, PLANNING AND DEVELOPMENT DEPARTMENT.
6. EXISTING SEWERS TO BE KEPT IN GOOD WORKING CONDITION AND OF ADEQUATE CAPACITY TO MEET THE REQUIREMENTS OF THE SITE. THE APPLICANT/OWNER OR THEIR CONTRACTOR IS RESPONSIBLE FOR HAVING THE SEWER TO BE REVISED VIDEO INSPECTED WHILE THE CITY OF WATERLOO CONDUCTS A BENCH MARK, CONCEPT PLAN, AND ECONOMIC AND ENVIRONMENTAL DEVELOPMENT DEPARTMENT, GROWTH MANAGEMENT DIVISION, DEVELOPMENT ENGINEERING CONSTRUCTION SECTION AT (905) 546-2424 X 7860 TO ARRANGE FOR AN INSPECTION.
7. ALL SEWERS TO BE VIDEO INSPECTED.

1. ALL SILT FENCING TO BE INSTALLED PRIOR TO COMMENCEMENT OF ANY AREA GRADING, EXCAVATING, OR DEMOLITION.
2. PROTECT ALL EXPOSED SURFACES AND CONTROL ALL RUNOFF DURING CONSTRUCTION.
3. PROTECT ALL MANHOLES, AND PIPE ENDS (EXISTING AND NEW) FROM SEDIMENT INTRUSION WITH GEOTEXTILE CLOTH (TERRAFIX 270), ALL CATCHBASINS TO HAVE SILTSACK AS PER THE ATTACHED DETAILS.
4. PREVENT WIND-BLOWN DUST.
5. ADDITIONAL EROSION CONTROL MEASURES MAY BE REQUIRED AS SITE DEVELOPMENT PROGRESSES. CONTRACTOR TO PROVIDE ALL ADDITIONAL EROSION CONTROL STRUCTURES.
6. EROSION CONTROL STRUCTURES TO BE MONITORED REGULARLY BY CONTRACTOR AND ANY DAMAGE REPAIRED IMMEDIATELY. SEDIMENTS TO BE REMOVED WHEN ACCUMULATIONS REACH A MAXIMUM OF ONE THIRD (1/3) THE HEIGHT OF THE SILT FENCE.
7. SEDIMENT CONTROL FENCE TO BE AS PER OPD 219.130
8. ALL EROSION CONTROL STRUCTURES TO REMAIN IN PLACE UNTIL ALL DISTURBED GROUND SURFACES HAVE BEEN RE-STABILIZED EITHER BY PAVING OR RESTORATION OF VEGETATIVE GROUND COVER.
9. THE CONTRACTOR IS RESPONSIBLE FOR REMOVING SEDIMENTS FROM THE MUNICIPAL ROADWAY AND SIDEWALKS AS REQUIRED TO SATISFY THE AUTHORITIES HAVING JURISDICTION AND AT THE END OF EACH WORK DAY.
10. MUD MATS OF 150MM RIP RAP, (15 METRES LONG, 7.5 METRES WIDE, 300MM DEEP) SHALL BE PROVIDED ON ALL SITE CONSTRUCTION ENTRANCES. CONTRACTOR TO ENSURE ALL VEHICLES LEAVE THE SITE WITH MUD MATS AND THAT THE MAT IS MAINTAINED IN A MANNER TO MAXIMIZE ITS EFFECTIVENESS AT ALL TIMES. REFERENCE SHOULD BE DRAWN TO LOCATIONS ON DRAWING.
11. CONSULTANT TO MONITOR THE SITE DEVELOPMENT TO ENSURE ALL EROSION CONTROLS ARE INSTALLED AND MAINTAINED TO CITY REQUIREMENTS.

STRUCTURAL MECHANICAL ELECTRICAL CIVIL  
ENGINEERS  
15 Foundry Street, Dundas, ON, L9H 2V6  
Phone: (905)648-0373  
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SEAL



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3.	ISSUED FOR CONSTRUCTION	2025-05-28	Y.T.
2.	ISSUED FOR PERMIT & TENDER	2025-04-17	Y.T.
1.	ISSUED FOR PROGRESS REVIEW	2025-03-28	A.A.
NO.	ISSUED	DATE	BY

# WORKSHOP

CLIENT:

BLAIR ROAD PUBLIC SCHOOL

PROJECT:

# BLAIR ROAD PUBLIC SCHOOL PARKING LOT EXPANSION

85 SUNSET BLVD, CAMBRIDGE  
ONTARIO, N1S 1A9

DRAWING TITLE:


## GENERAL NOTES

DRAWN BY: A.A.	SCALE: AS NOTED
CHECKED BY: Y.T.	DRAWING NUMBER:
DATE: 2025-02	C0.00
PROJECT NUMBER: 25-013	








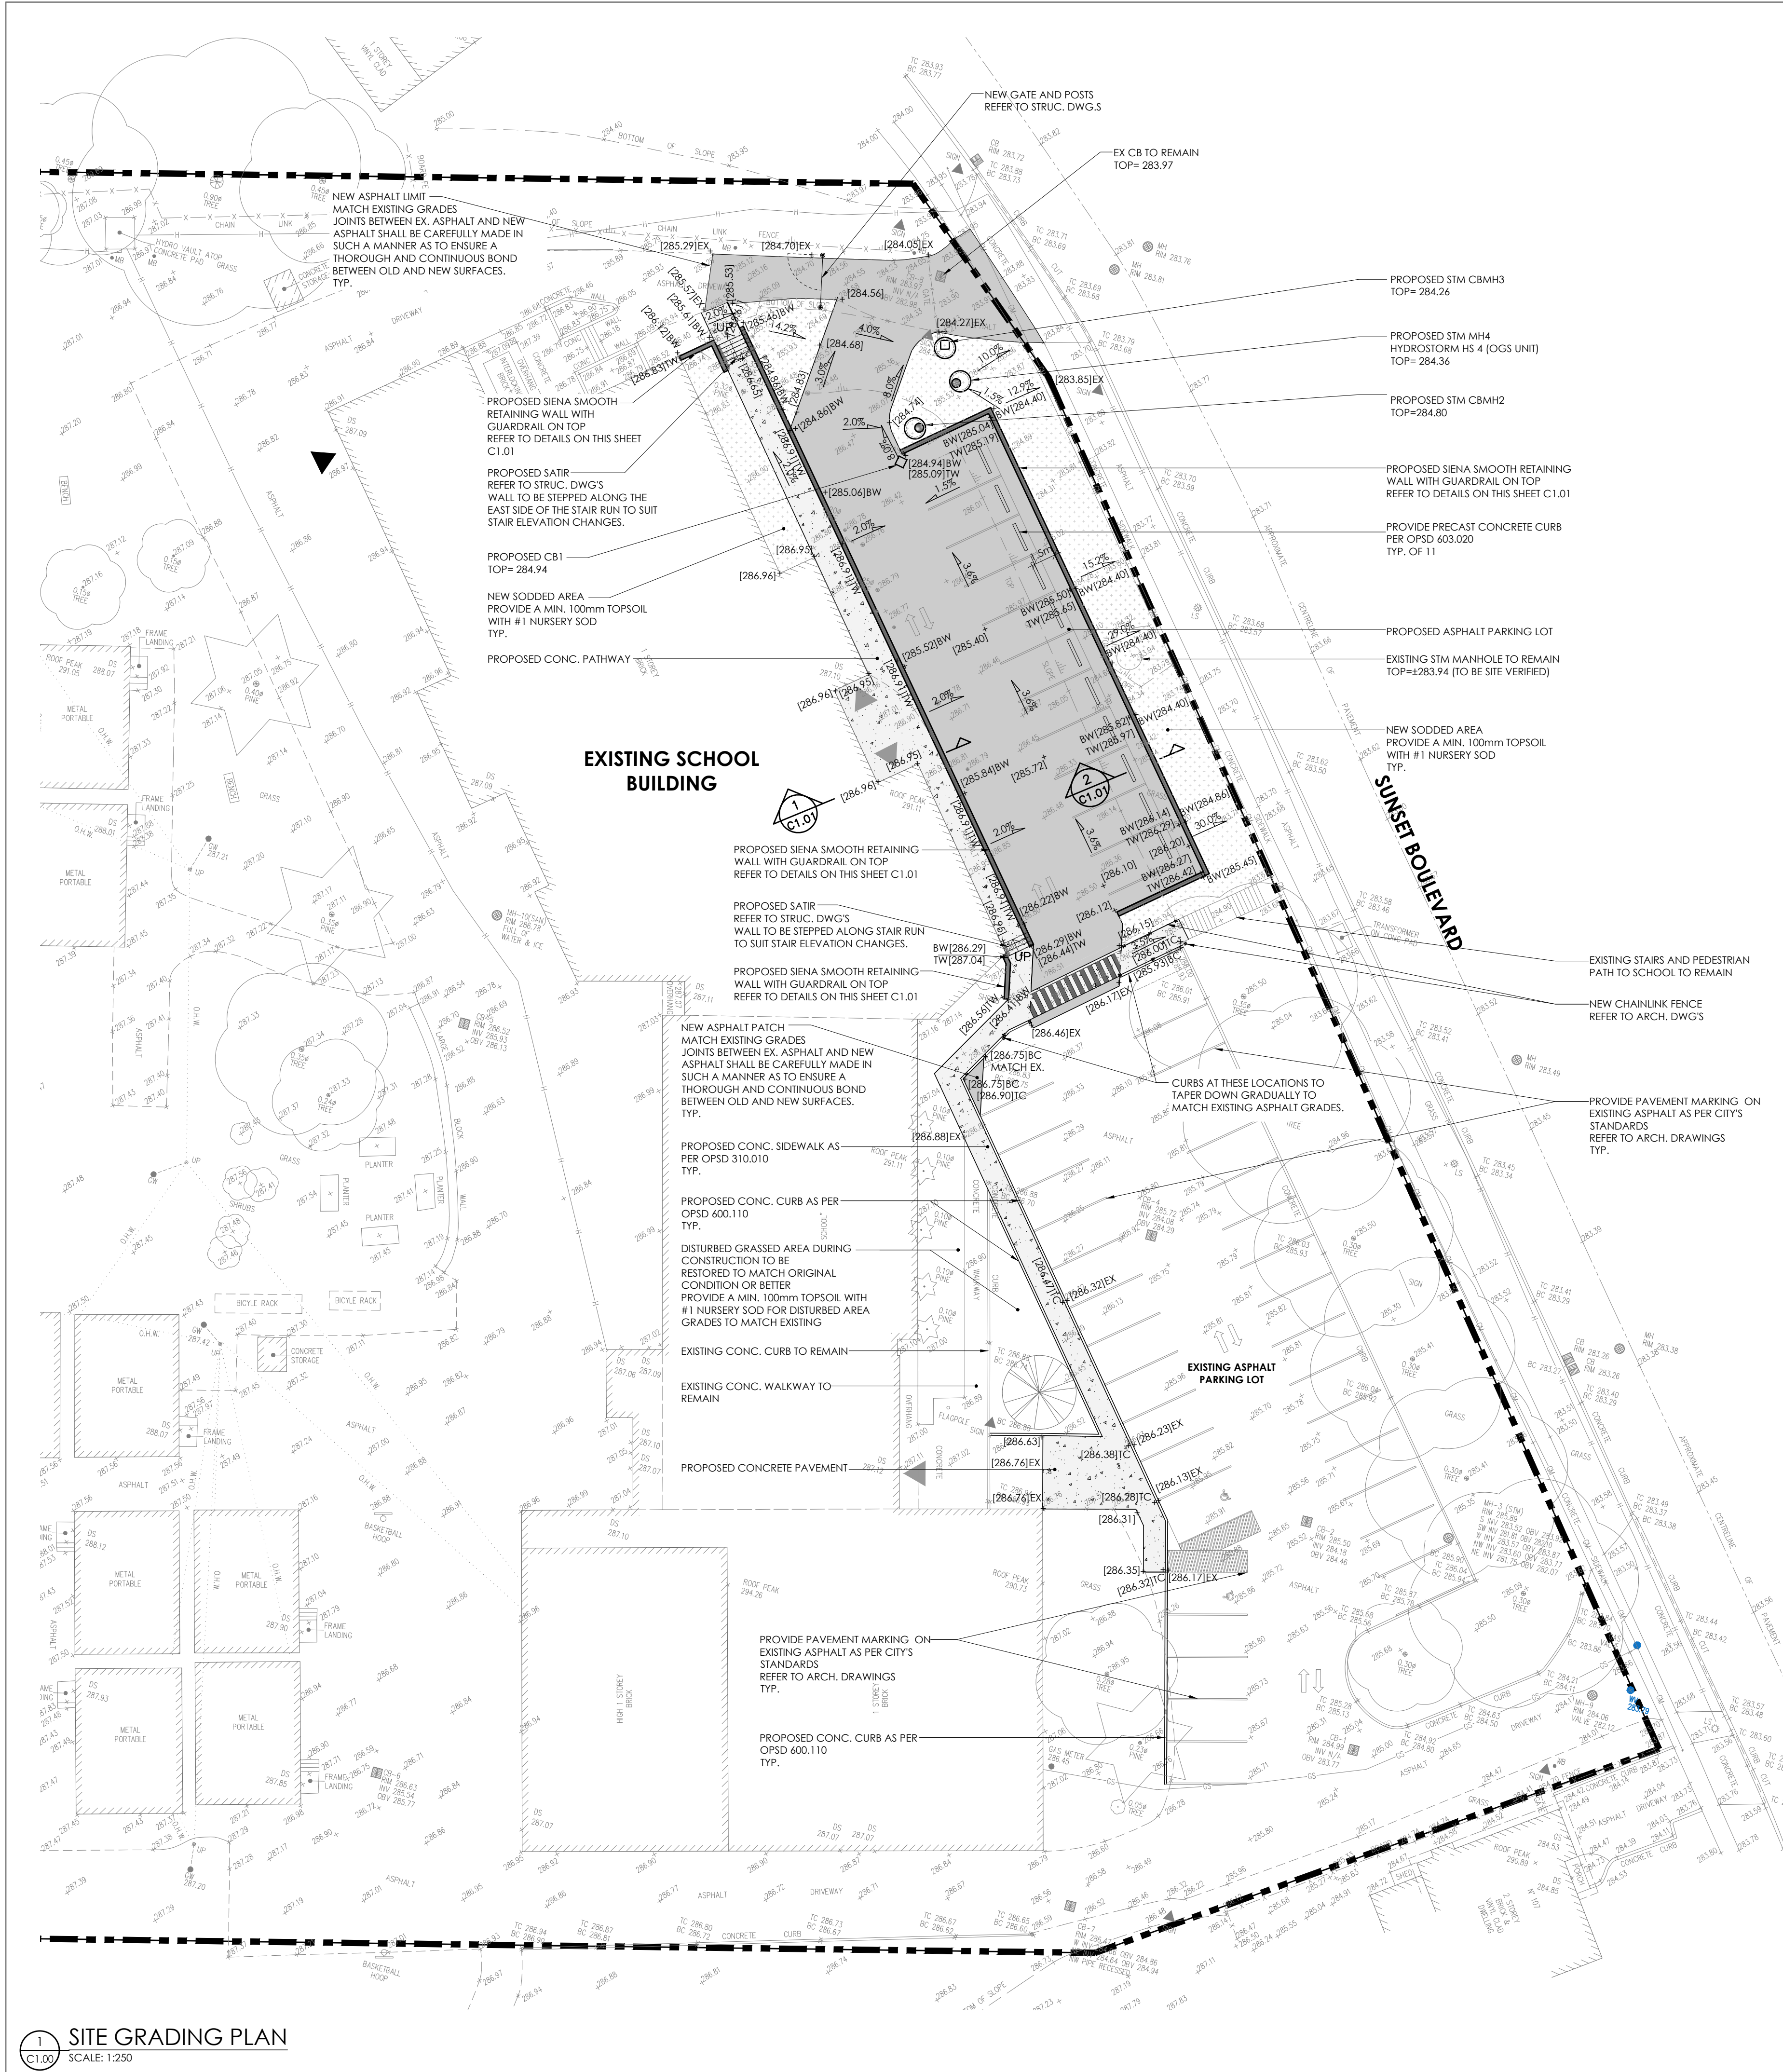

**1 SITE GRADING PLAN**  
SCALE: 1:250

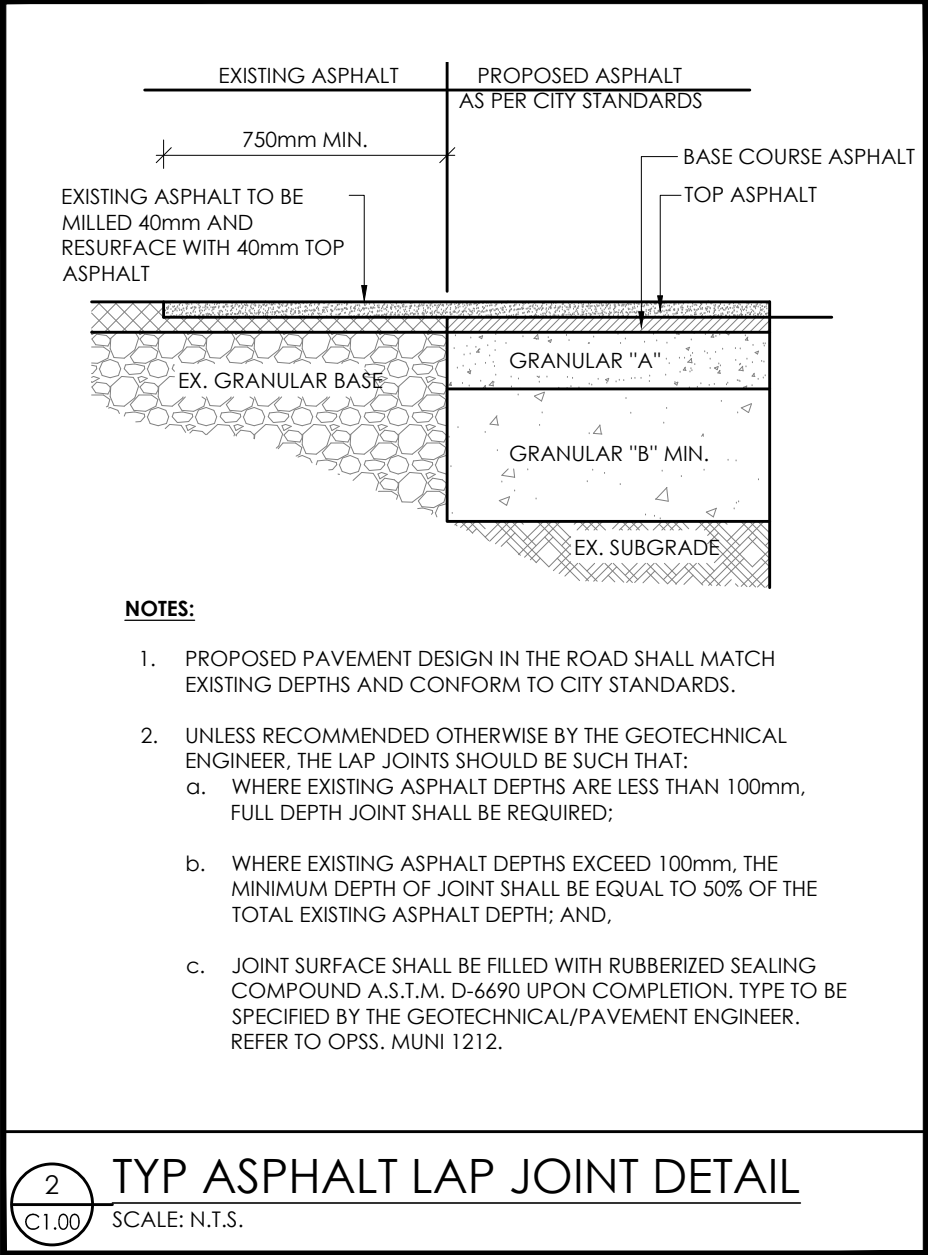


**2 TYP ASPHALT LAP JOINT DETAIL**  
SCALE: N.T.S.

LEGEND - SITE GRADING	
THIS LEGEND OF SYMBOLS REPRESENTS MANTECON PARTNERS INC. STANDARD/Generic LEGEND. ALL SYMBOLS MAY NOT APPEAR ON DRAWINGS.	
REFER	DESCRIPTION
---	PROPERTY LINE
[Hatched Box]	EXISTING BUILDING
[Diagonal Lines Box]	PROPOSED ASPHALT
[Dotted Box]	PROPOSED CONCRETE
[Stippled Box]	PROPOSED SOD
XXXX.XX	EXISTING ELEVATION
+ [XXX.XX]	PROPOSED ELEVATION
[CB Symbol]	PROPOSED CATCH BASIN
[CBMH Symbol]	PROPOSED CATCH BASIN MANHOLE
[SMMH Symbol]	PROPOSED STORM MANHOLE
METRIC: DISTANCES SHOWN ON THIS PLAN ARE IN METRES AND CAN BE CONVERTED TO FEET BY DIVIDING BY 0.3048	

SITE PLAN	
PLAN OF TOPOGRAPHICAL SURVEY OF BLAIR ROAD PUBLIC SCHOOL BEING N° 85 SUNSET BOULEVARD, CITY OF CAMBRIDGE REGIONAL MUNICIPALITY OF WATERLOO	
INFORMATION ON THIS SITE PLAN TAKEN FROM SURVEY / TOPOGRAPHY PREPARED BY:	
GENESIS LAND SURVEYING INC. 10 FOUR SEASONS PLACE 10TH FLOOR TORONTO, M9B 6H7 T 905-499-2956 - T 1 800-262-9784	
THE SURVEY WAS COMPLETED ON DECEMBER 30, 2024	

BENCHMARK	
ELEVATIONS ARE GEODETIC AND ARE REFERRED TO CITY OF CAMBRIDGE BENCHMARK N° 0011963308 WITH A PUBLISHED ELEVATION OF 300.480 METRES (CGVD-1928/POST-1978).	
UTILITY NOTE	
THE LOCATION OF UNDERGROUND UTILITIES SHOWN HAS BEEN LOCATED BY MARK-IT LOCATES INC. ON JANUARY 6, 2025 AND IS FOR DESIGN PURPOSES ONLY. IT IS NOT TO BE USED AS A SUBSTITUTE FOR NEW LOCATES PRIOR TO EXCAVATION. AND IS CERTIFIED BY MARK-IT LOCATES INC. ONLY. ANY DISCREPANCIES ARE TO BE REPORTED. READ WITH CORRESPONDING LOCATE REPORT.	
SNOW NOTE	
THE FIELDWORK WAS COMPLETED DURING HEAVY SNOW CONDITIONS AND EVERY ATTEMPT HAS BEEN MADE TO ACCURATELY CAPTURE ALL RELEVANT TOPOGRAPHIC DETAILS, ANY OMISSIONS SHOULD BE REPORTED TO THE UNDERSIGNED.	

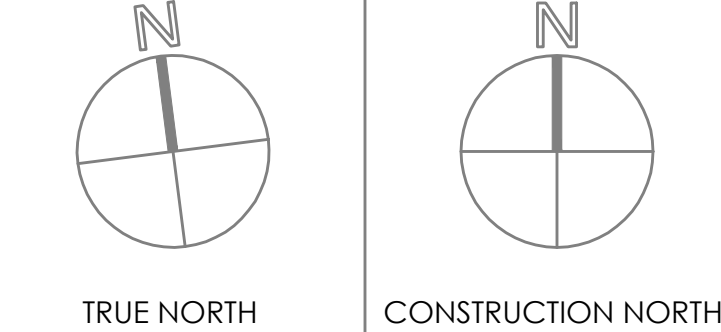

**MANTECON PARTNERS**  
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NO.	ISSUED	DATE	BY
4.	ISSUED FOR CONSTRUCTION	2025-05-28	Y.T.
3.	ISSUED FOR ADDENDUM C-01	2025-05-08	A.A.
2.	ISSUED FOR PERMIT & TENDER	2025-04-17	Y.T.
1.	ISSUED FOR PROGRESS REVIEW	2025-03-28	A.A.

# WORKSHOP

CLIENT:  
**BLAIR ROAD PUBLIC SCHOOL**


PROJECT:  
**BLAIR ROAD PUBLIC SCHOOL PARKING LOT EXPANSION**

85 SUNSET BLVD, CAMBRIDGE ONTARIO, N1S 1A9

DRAWING TITLE:  
**SITE GRADING PLAN**

DRAWN BY: <b>A.A.</b>	SCALE: <b>AS NOTED</b>
CHECKED BY: <b>C.B.</b>	DRAWING NUMBER:
DATE: <b>2025-02</b>	<b>C1.00</b>
PROJECT NUMBER: <b>25-013</b>	




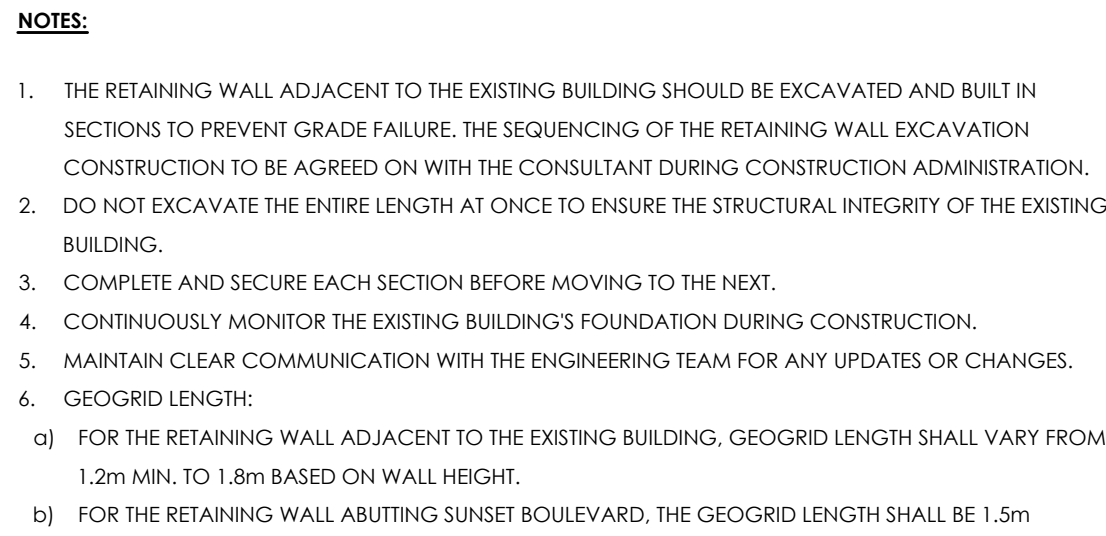

1  
C1.01

TYP RISISTONE SIENA SMOOTH RETAINING WALL SECTION DETAIL

SCALE: N.T.S.

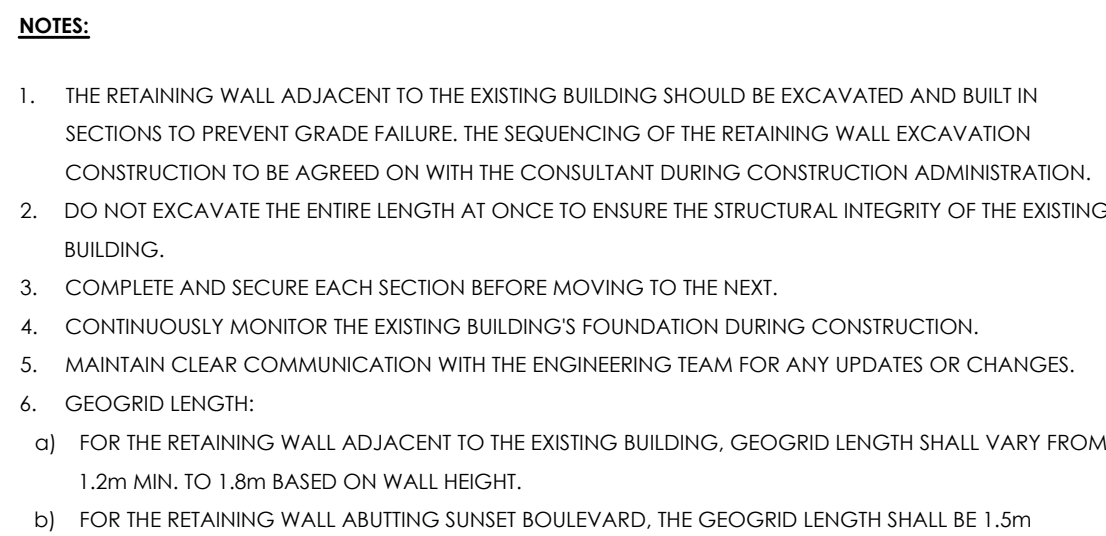


2  
C1.01

TYP RISISTONE SIENA SMOOTH RETAINING WALL SECTION DETAIL

SCALE: N.T.S.



**NOTES:**  
A Class of concrete shall be C2 according to CSA A23.1.  
B All dimensions are in millimetres unless otherwise shown.

ONTARIO PROVINCIAL STANDARD DRAWING	Nov 2012	Rev 2	
PRECAST CONCRETE CURB			
	OPSD 603.020		

NOTES:

1. THE RISISTONE SUPPLIER ENGINEER SHALL STAMP THE RETAINING WALL ON THIS PROJECT TO INSURE GRADE STABILITY.



SEAL



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2.	ISSUED FOR CONSTRUCTION	2025-05-28	Y.T.
1.	ISSUED FOR PERMIT & TENDER	2025-04-17	Y.T.
NO.	ISSUED	DATE	BY






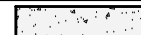











1 SITE SERVICING PLAN  
C2.00 SCALE: 1:250

## DRAWING NOTES

1. THE CONSTRUCTION OF THE PARKING LOT INVOLVES LOWERING THE GRADES BY APPROXIMATELY 1.5 METERS IN AREAS WITH EXISTING SANITARY AND STORM PIPES. CONTRACTOR SHALL ENSURE THAT THESE PIPES ARE PROTECTED DURING EXCAVATION TO PREVENT DAMAGE.
2. THE CONTRACTOR SHALL ACCURATELY LOCATE AND MARK ALL EXISTING UTILITIES BEFORE EXCAVATION.
3. THE CONTRACTOR SHALL CONFIRM THE DEPTH AND LOCATION OF ALL EXISTING PIPES AND STRUCTURES TO AVOID INTERFERENCE DURING THE WORK AND NOTIFY THE ENGINEER (ONCE DEPTHS ARE CONFIRMED).
4. THE CONTRACTOR SHALL USE PROPER PROTECTION METHODS TO PREVENT PIPE EXPOSURE OR DAMAGE.
5. IF ANY RISK OF DAMAGE OCCURS, THE CONTRACTOR MUST HALT WORK IMMEDIATELY AND NOTIFY THE PROJECT MANAGER OR ENGINEER.
6. THE CONTRACTOR SHALL ENSURE ALL NECESSARY INSPECTIONS, PERMITS, AND APPROVALS ARE OBTAINED BEFORE EXCAVATION IN AREAS WITH UTILITIES.
7. THE CONTRACTOR IS RESPONSIBLE FOR ANY DAMAGE TO EXISTING UTILITIES DURING CONSTRUCTION AND MUST REPAIR OR REPLACE THEM AT THEIR OWN COST.

**LEGEND - SITE SERVICING/UTILITIES**

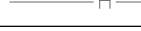THIS LEGEND OF SYMBOLS REPRESENTS MANTECON PARTNERS INC.  
STANDARD/GENERIC LEGEND. ALL SYMBOLS MAY NOT APPEAR ON DRAWINGS.

REFER	DESCRIPTION
	PROPERTY LINE
	EXISTING BUILDING
	PROPOSED ASPHALT
	PROPOSED CONCRETE
	PROPOSED SOD
	EXISTING WATER SERVICE
	EXISTING STORM SERVICE
	EXISTING SANITARY SERVICE
	EXISTING GAS SERVICE
	EXISTING HYDRO SERVICE
	EXISTING COMMUNICATION SERVICE
	PROPOSED SERVICES - STORM SEWER
	PROPOSED CATCH BASIN
	PROPOSED CATCH BASIN MANHOLE
	PROPOSED STORM MANHOLE

METRIC: DISTANCES SHOWN ON THIS PLAN ARE IN METRES AND CAN BE CONVERTED TO FEET BY DIVIDING BY 0.3048

## SITE PLAN

PLAN OF TOPOGRAPHICAL SURVEY OF  
BLAIR ROAD PUBLIC SCHOOL  
BEING N° 85 SUNSET BOULEVARD,  
CITY OF CAMBRIDGE  
REGIONAL MUNICIPALITY OF WATERLOO

INFORMATION ON THIS SITE PLAN  
TAKEN FROM SURVEY / TOPOGRAPHY  
PREPARED BY:

GENESIS LAND SURVEYING INC.  
10 FOUR SEASONS PLACE  
10TH FLOOR TORONTO, M9B 6H7  
T 905-499-2956 - T 1800-262-9784

THE SURVEY WAS COMPLETED ON DECEMBER 30, 2024

## BENCHMARK



ELEVATIONS ARE GEODETIC AND ARE REFERRED TO CITY OF CAMBRIDGE BENCHMARK N° 00119663308 WITH A PUBLISHED ELEVATION OF 300.480 METRES (CGVD-1928:POST-1978).

### UTILITY NOTE


THE LOCATION OF UNDERGROUND UTILITIES SHOWN HAS BEEN LOCATED BY MARK-IT LOCATES INC. ON JANUARY 6, 2025 AND IS FOR DESIGN PURPOSES ONLY. IT IS NOT TO BE USED AS A SUBSTITUTE FOR NEW LOCATES PRIOR TO EXCAVATION, AND IS CERTIFIED BY MARK-IT LOCATES INC ONLY. ANY DISCREPANCIES ARE TO BE REPORTED. READ WITH CORRESPONDING LOCATE REPORT.

## SNOW NOTE

THE FIELDWORK WAS COMPLETED DURING HEAVY SNOW CONDITIONS AND EVERY ATTEMPT HAS BEEN MADE TO ACCURATELY CAPTURE ALL RELEVANT TOPOGRAPHIC DETAILS. ANY OMISSIONS SHOULD BE REPORTED TO THE UNDERSIGNED.

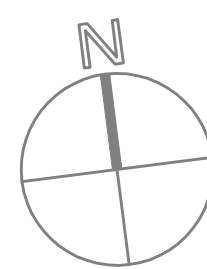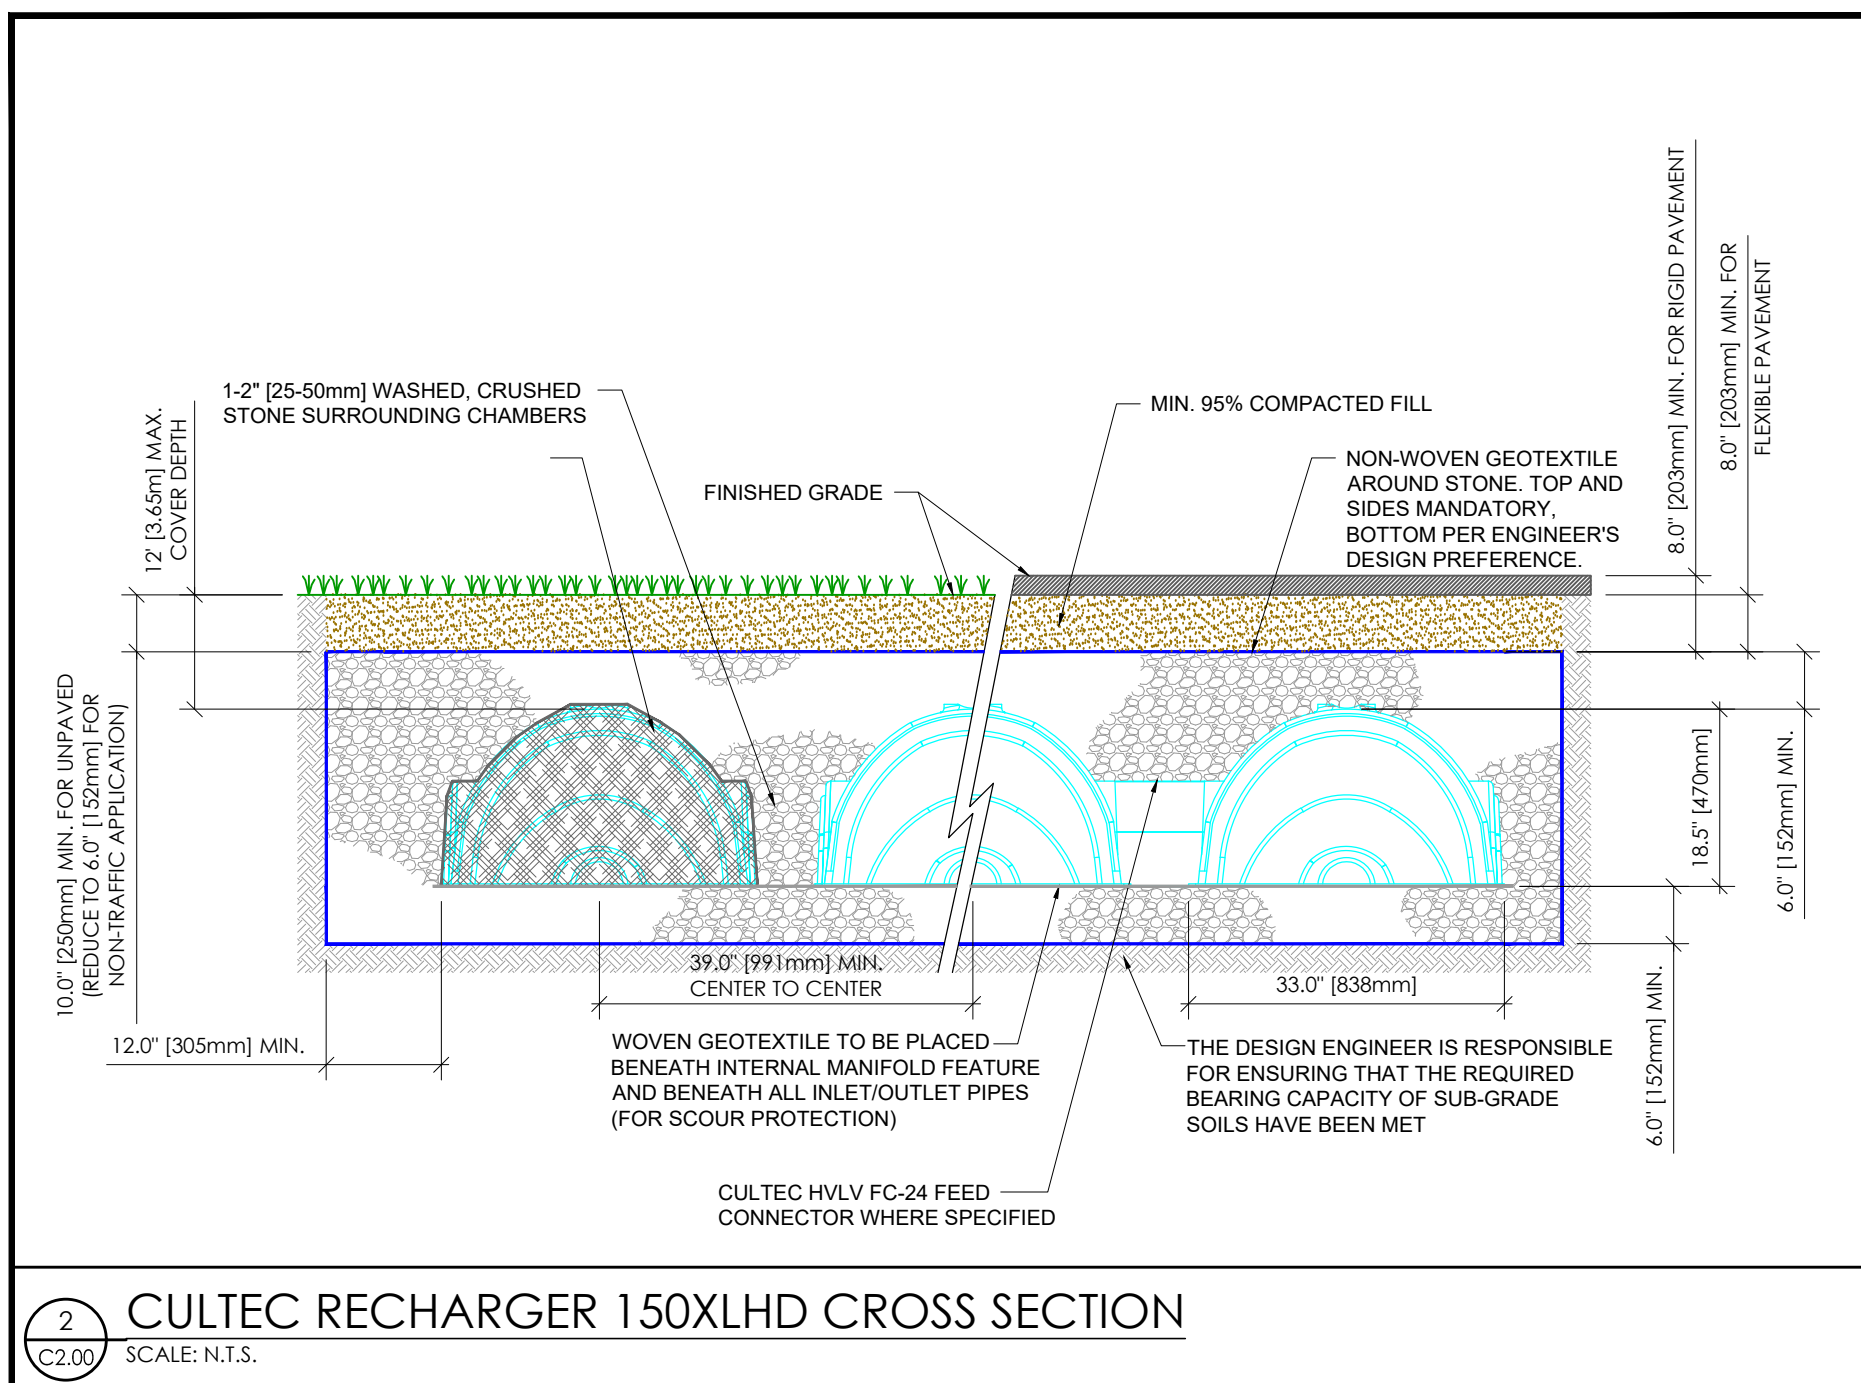

TRUE NORTH

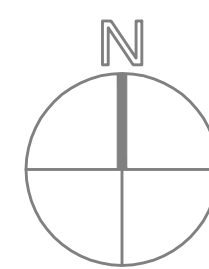

CONSTRUCTION NORTH



STRUCTURAL MECHANICAL ELECTRICAL CIVIL  
ENGINEERS  
15 Foundry Street, Dundas, ON, L9H 2V6  
Phone: (905) 648-0373  
[www.manteconpartners.com](http://www.manteconpartners.com)

SEA



REVIEW ALL DRAWINGS AND VERIFY ALL DIMENSIONS AT THE SITE. DO NOT SCALE THE DRAWINGS. REPORT ALL DISCREPANCIES TO THE ENGINEER BEFORE PROCEEDING WITH ANY CONSTRUCTION OR SHOP FABRICATION. ALL DRAWINGS, SPECIFICATIONS AND RELATED DOCUMENTS ARE THE COPYRIGHT PROPERTY OF 'MANTECON PARTNERS' AND MUST BE RETURNED UPON REQUEST. REPRODUCTION OF DRAWINGS, SPECIFICATIONS AND RELATED DOCUMENTS IN PART OR WHOLE IS FORBIDDEN WITHOUT THE ENGINEER'S WRITTEN PERMISSION.

4.	ISSUED FOR CONSTRUCTION		2025-05-28		Y.T.
3.	ISSUED FOR ADDENDUM C-01		2025-05-08		A.A.
2.	ISSUED FOR PERMIT & TENDER		2025-04-17		Y.T.
1.	ISSUED FOR PROGRESS REVIEW		2025-03-28		A.A.
NO.	ISSUED		DATE		BY

## WORKSHOP

CLIENT:

BLAIR ROAD PUBLIC SCHOOL

PROJECT:

# BLAIR ROAD PUBLIC SCHOOL PARKING LOT EXPANSION

85 SUNSET BLVD, CAMBRIDGE  
ONTARIO, N1S 1A9

DRAWING TITLE:

## SITE SERVICING PLAN

DRAWN BY  
A.A.

AS NOTED

CHECKED BY:  
Y.T.

DRAWING NUMBER:



2025-02

C2.00

25-013

May 26, 2025 - 09:11am Plotted by: aabwarda



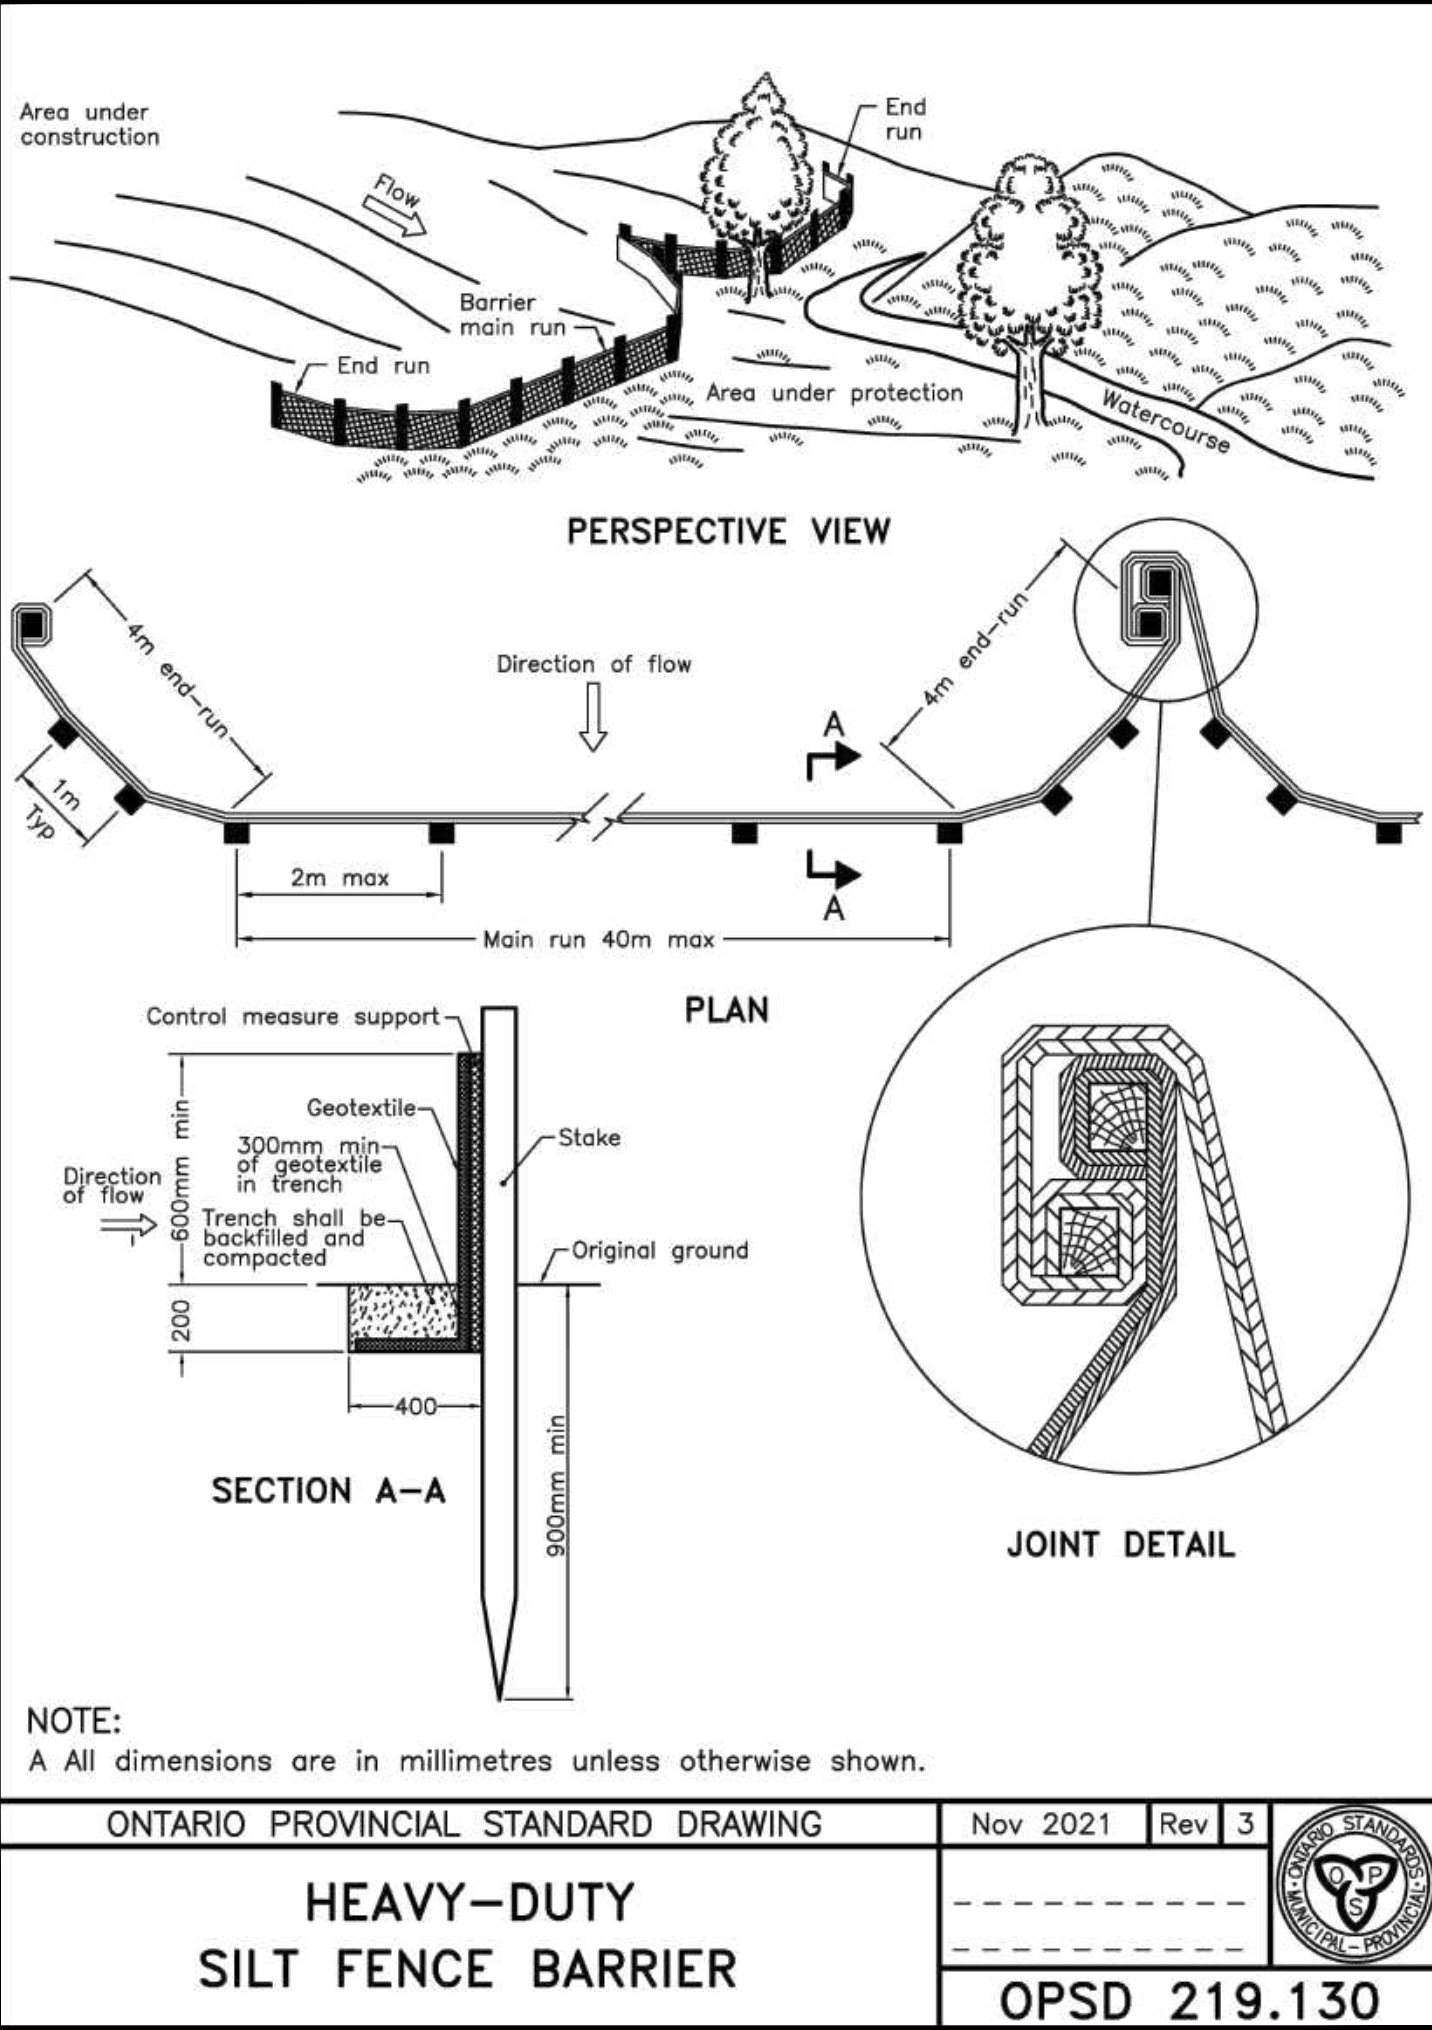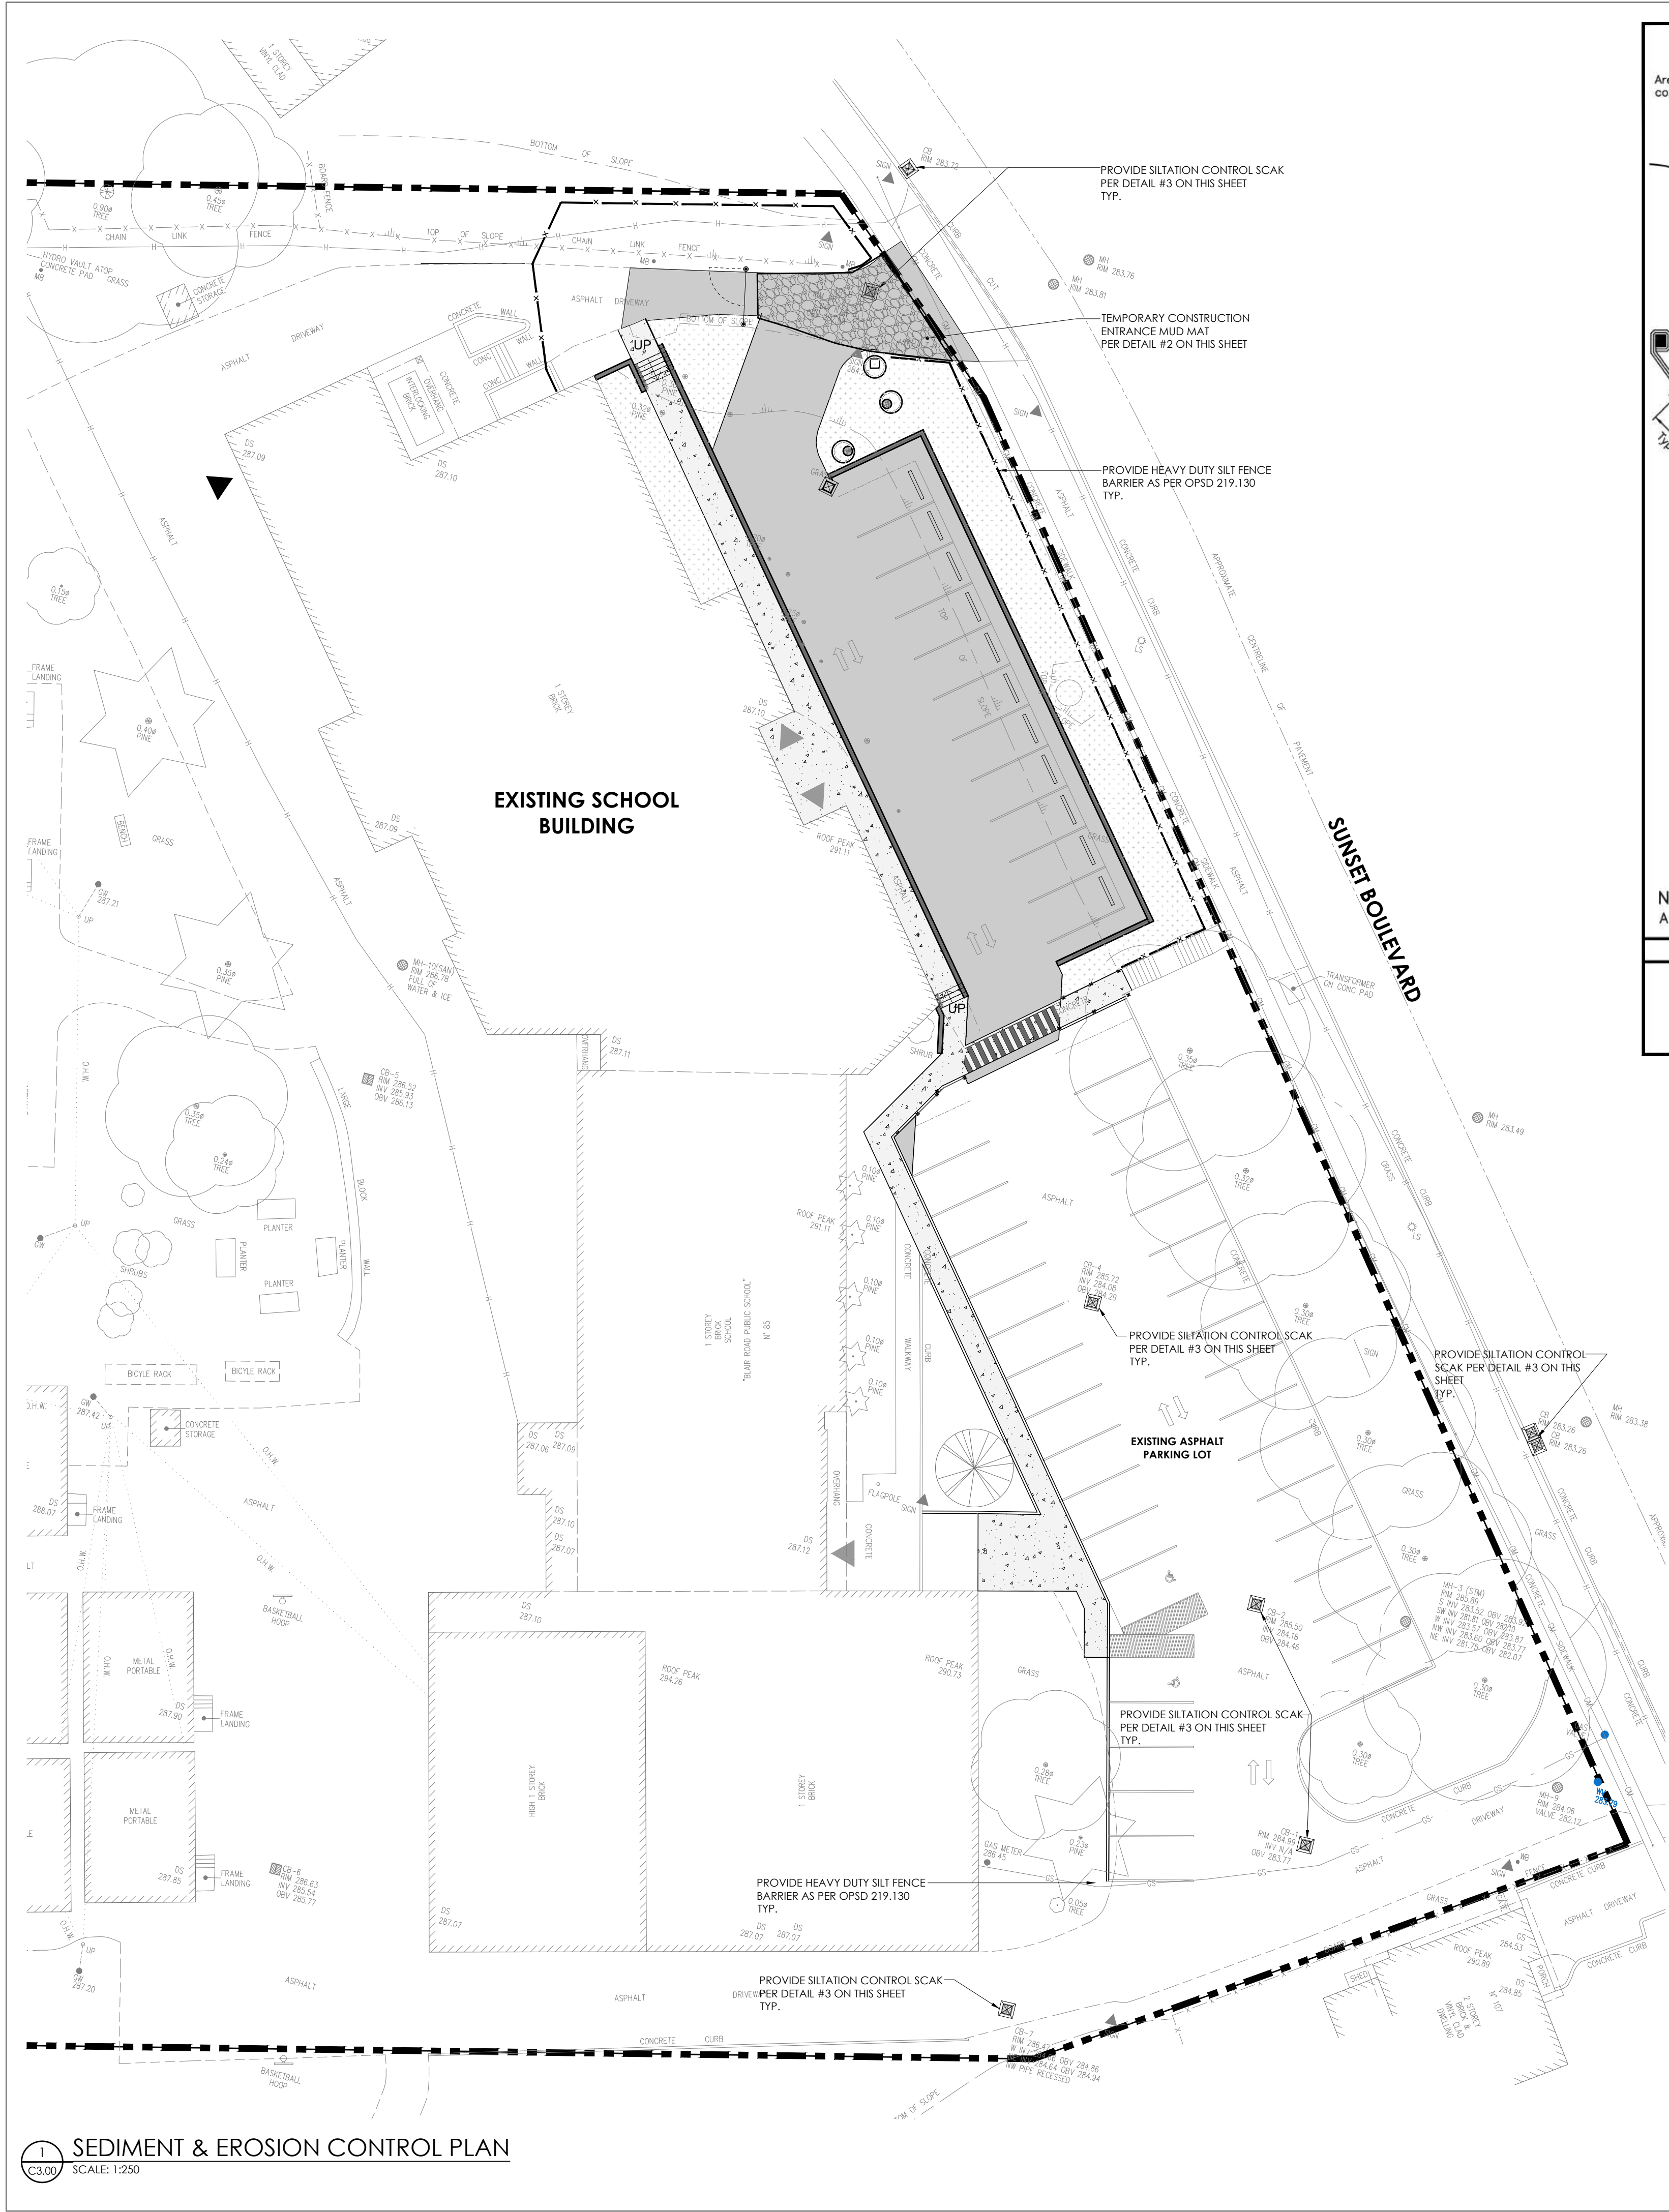

**LEGEND - SITE GRADING**

THIS LEGEND OF SYMBOLS REPRESENTS MANTECON PARTNERS INC. STANDARD/GENERIC LEGEND. ALL SYMBOLS MAY NOT APPEAR ON DRAWINGS.

REFER	DESCRIPTION
---	PROPERTY LINE
▨	EXISTING BUILDING
▨	PROPOSED ASPHALT
▨	PROPOSED CONCRETE
▨	PROPOSED SOD
+	EXISTING ELEVATION
+ [XXX.XX]	PROPOSED ELEVATION
CB	PROPOSED CATCH BASIN
CBMH	PROPOSED CATCH BASIN MANHOLE
2TMMH	PROPOSED STORM MANHOLE

METRIC: DISTANCES SHOWN ON THIS PLAN ARE IN METRES AND CAN BE CONVERTED TO FEET BY DIVIDING BY 0.3048

**SITE PLAN**

PLAN OF TOPOGRAPHICAL SURVEY OF  
BLAIR ROAD PUBLIC SCHOOL  
BEING 1/25 SUNSET BOULEVARD,  
CITY OF CAMBRIDGE  
REGIONAL MUNICIPALITY OF WATERLOO

INFORMATION ON THIS SITE PLAN  
TAKEN FROM SURVEY / TOPOGRAPHY  
PREPARED BY:  
GENESIS LAND SURVEYING INC.  
10 FOUR SEASONS PLACE  
10TH FLOOR TORONTO, M9B 6H7  
T 905-499-2956 - T 1800-262-9784

THE SURVEY WAS COMPLETED ON DECEMBER 30, 2024

**BENCHMARK**



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**SNOW NOTE**

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www.manteconpartners.com

SEAL

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NO.	ISSUED	DATE	BY
3.	ISSUED FOR CONSTRUCTION	2025-05-28	Y.T.
2.	ISSUED FOR PERMIT & TENDER	2025-04-17	Y.T.
1.	ISSUED FOR PROGRESS REVIEW	2025-03-28	A.A.

**WORKSHOP**

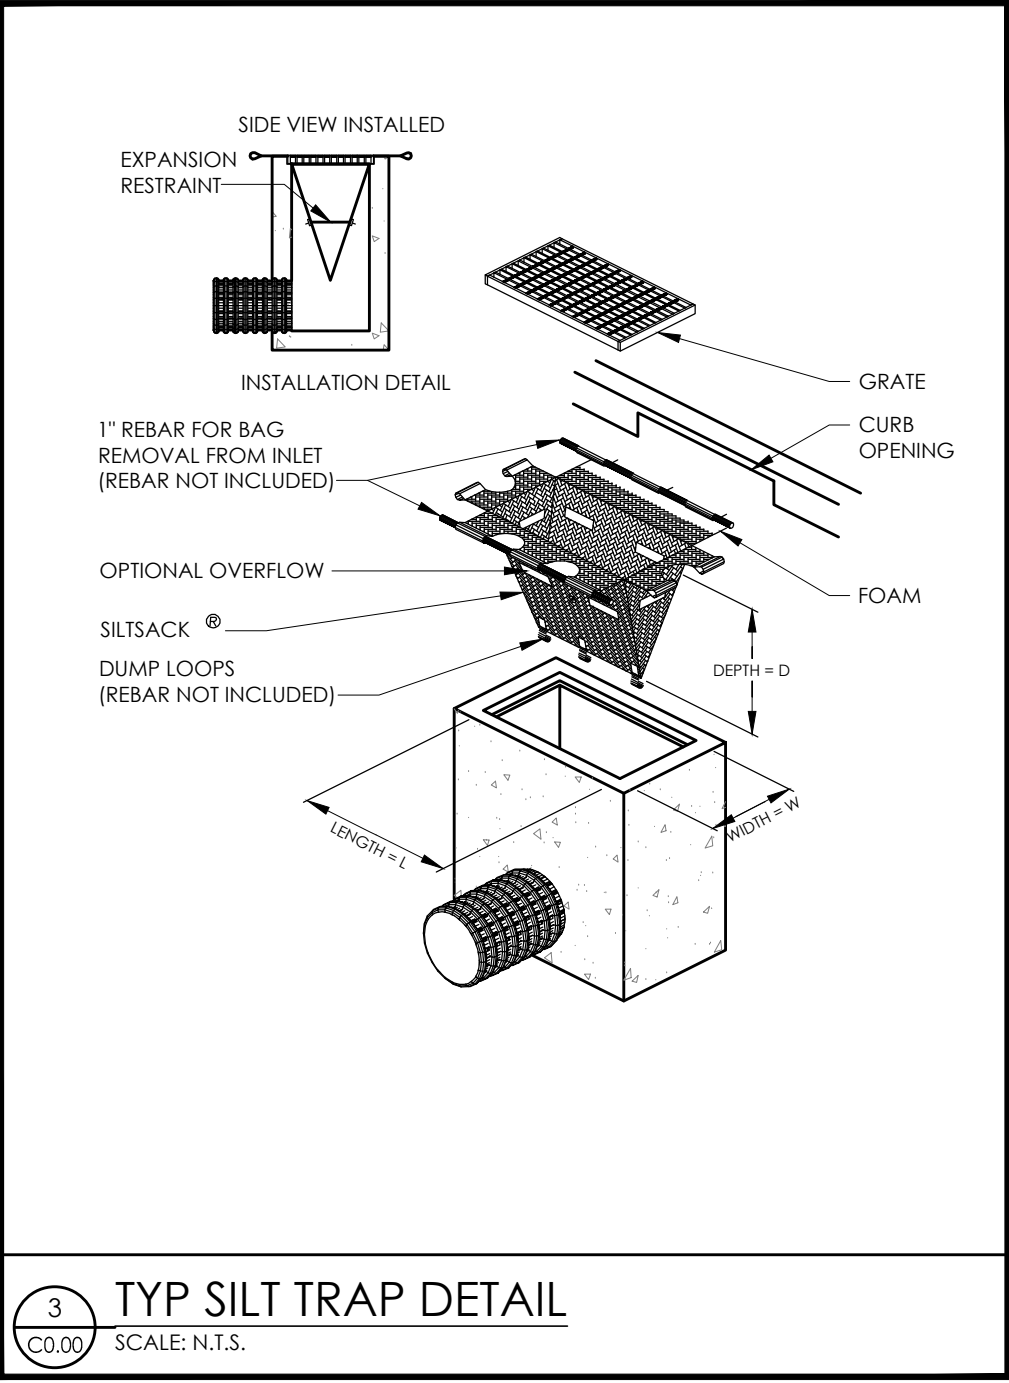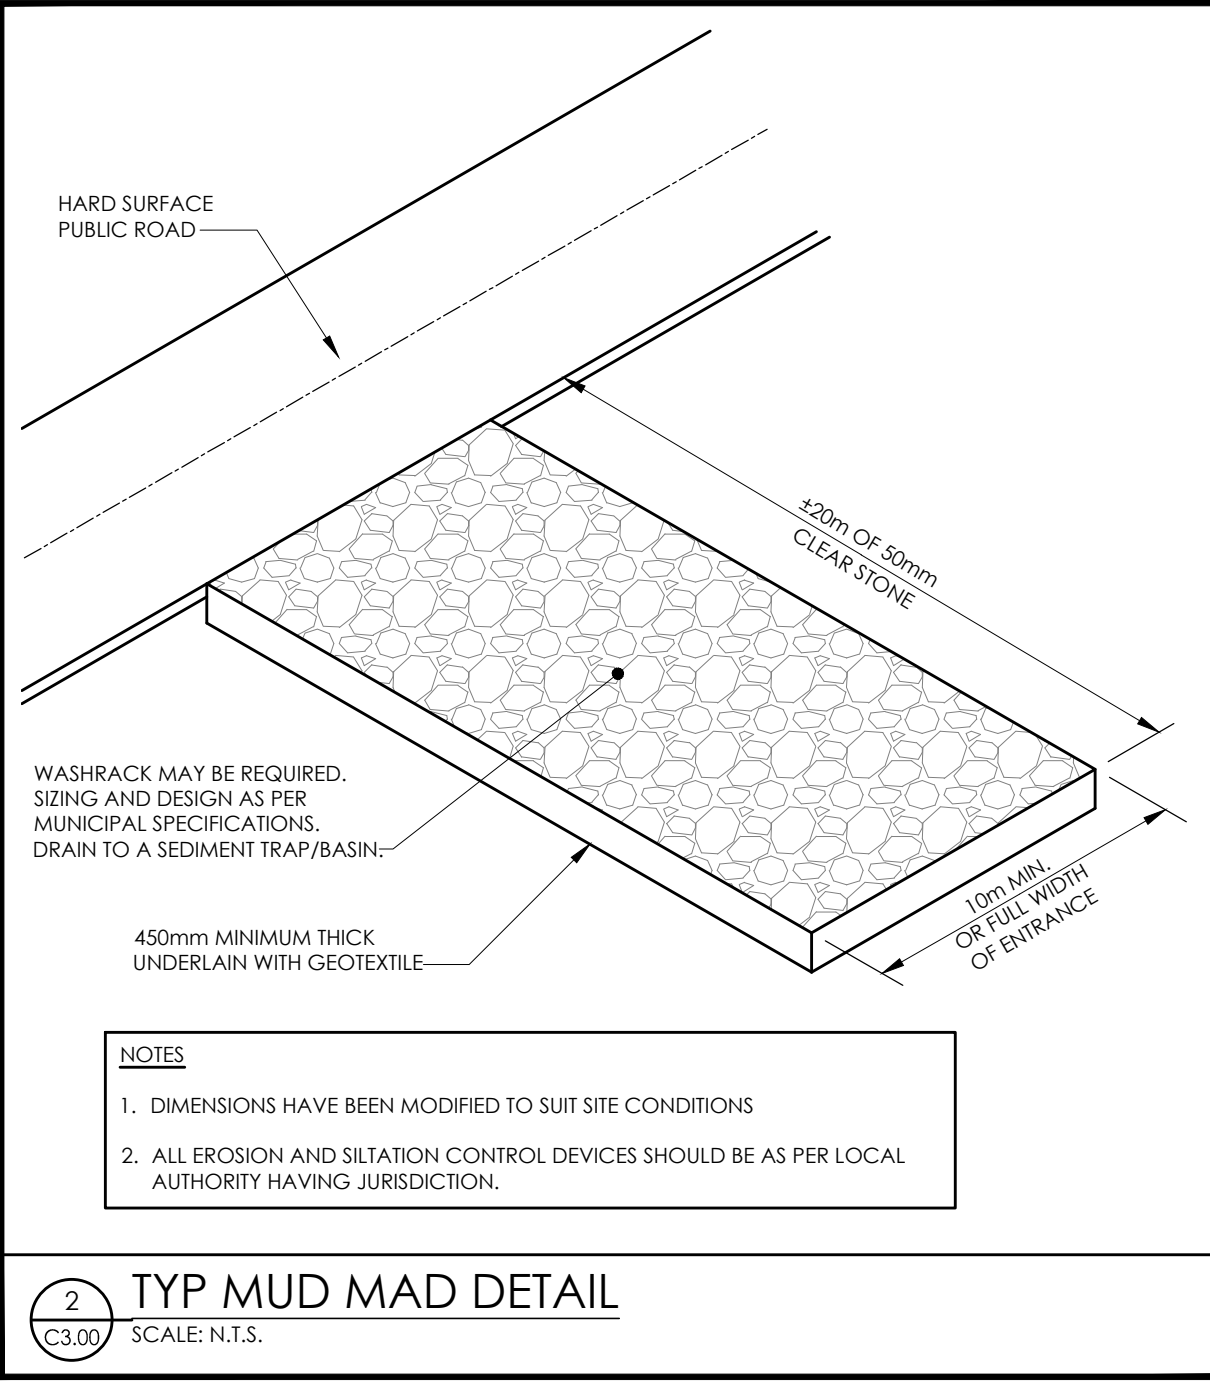CLIENT:  
**BLAIR ROAD PUBLIC SCHOOL**

PROJECT:  
**BLAIR ROAD PUBLIC SCHOOL  
PARKING LOT EXPANSION**

85 SUNSET BLVD, CAMBRIDGE  
ONTARIO, N1S 1A9

DRAWING TITLE:  
**SEDIMENT & EROSION  
CONTROL PLAN**

DRAWN BY:  
**A.A.**

CHECKED BY:  
**Y.T.**

DATE:  
**2025-02**

PROJECT NUMBER:  
**25-013**

SCALE:  
**AS NOTED**

DRAWING NUMBER:  
**C3.00**

May 26, 2025 - 09:11am Plotted by: abuwarda



# BLAIR RD PUBLIC SCHOOL PARKING LOT EXP.

## 85 SUNSET BLVD.

## CAMBRIDGE, ON

### DRAWING INDEX

TITLE	SHEET NO.
COVER SHEET	1 OF 5
SYSTEM LAYOUT SHEET	2 OF 5
SYSTEM CALCULATION SHEET	3 OF 5
SYSTEM OVERLAY SHEET	4 OF 5
150XLHD DETAIL SHEET	5 OF 5

PROJECT INFORMATION						
PROJECT NO:	25-0399					
CULTEC SALES REP:	DOMINIC TURNER 438-266-4033 <a href="mailto:DOMINIC.TURNER@CULTEC.COM">DOMINIC.TURNER@CULTEC.COM</a>					
CULTEC TECHNICAL SALES ENGINEER:						
CULTEC PROJECT COORDINATOR:	TYLER BRUSH 475-289-7120 <a href="mailto:TYLER.BRUSH@CULTEC.COM">TYLER.BRUSH@CULTEC.COM</a>					
ENGINEER OF RECORD	MANTECON PARTNERS					
REVISIONS:	ITERATION	DATE	BY	COMMENTS	EOR SHEET REFERENCE	DATE
	00	04/08/2025	MPW	SUBMITTAL DRAWINGS	DWG NO C2.00 SITE SERVICING PLAN	03/28/2025
	01	04/10/2025	MPW	UPDATES INLET PIPE TO CBMH3 TO OUTLET PIPE	DWG NO C2.00 SITE SERVICING PLAN	03/28/2025



CULTEC

Subsurface Stormwater Management Systems

878 Federal Road  
Brookfield, CT 06804  
[www.cultec.com](http://www.cultec.com)

PH: 1(203) 775-4416  
PH: 1(800) 4-CULTEC  
CT-tech@cultec.com

NOTE: THESE SHOP DRAWINGS MAY CONTAIN COMPONENTS INCLUDING BUT NOT LIMITED TO MANHOLES, CATCH BASINS, STORM PIPES AND FITTINGS, MANIFOLDS, CASTINGS AND OTHER NECESSARY APPURTENANCES THAT MAY NOT BE SUPPLIED BY CULTEC, INC. IT IS THE RESPONSIBILITY OF THE CONTRACTOR AND/OR SUPPLIER TO CONFIRM WITH CULTEC THE MATERIALS PROVIDED.

#### BEFORE YOU BEGIN - REQUIRED MATERIALS AND EQUIPMENT

1. PROPER GEOTECHNICAL SOIL EVALUATION BY A QUALIFIED ENGINEER OR SOIL SCIENTIST TO DETERMINE SUITABILITY OF STRUCTURAL INSTALLATION
2. OSHA COMPLIANCE
3. CULTEC WARNING TAPE, OR EQUIVALENT
4. ASSURANCES FROM LOCAL UTILITIES THAT NO UNDERGROUND GAS, ELECTRICAL OR OTHER POTENTIALLY DANGEROUS PIPELINES OR CONDUITS ARE ALREADY BURIED AT THE SITE
5. ACCEPTABLE 1- 2 INCH (25 - 51 mm) WASHED, CRUSHED STONE AS DETAILED IN CULTEC'S INSTALLATION INSTRUCTIONS. CLEANLINESS OF STONE TO BE VERIFIED BY ENGINEER.
6. ACCEPTABLE FILL MATERIAL AS SHOWN IN CULTEC'S INSTALLATION INSTRUCTIONS.
7. ALL CULTEC CHAMBERS AND ACCESSORIES AS SPECIFIED IN THE ENGINEER'S PLANS INCLUDING CULTEC NO. 410 NON-WOVEN GEOTEXTILE, CULTEC STORMFILTER AND CULTEC NO. 4800 WOVEN GEOTEXTILE, WHERE APPLICABLE.
8. RECIPROCATING SAW OR ROUTER
9. STONE BUCKET
10. STONE CONVEYOR AND/OR TRACKED EXCAVATOR
11. TRANSIT OR LASER LEVEL MEASURING DEVICE
12. COMPACTION EQUIPMENT WITH MAXIMUM GROSS VEHICLE WEIGHT OF 12,000 LBS (5,440 KGS). VIBRATORY ROLLERS MAY ONLY BE USED ON THE STONE BASE PRIOR TO THE INSTALLATION OF CHAMBERS.
13. CHECK CULTEC CHAMBERS FOR DAMAGE PRIOR TO INSTALLATION. DO NOT USE DAMAGED CULTEC CHAMBERS, CONTACT YOUR SUPPLIER IMMEDIATELY TO REPORT DAMAGE OR PACKING-LIST DISCREPANCIES.

#### REQUIREMENTS FOR CULTEC CHAMBER SYSTEM INSTALLATIONS









1. INSTALLING CONTRACTORS ARE EXPECTED TO COMPREHEND AND USE THE MOST CURRENT INSTALLATION INSTRUCTIONS PRIOR TO BEGINNING A SYSTEM INSTALLATION. IF THERE IS ANY QUESTION AS TO WHETHER YOU POSSESS THE MOST CURRENT INSTRUCTIONS, CONTACT CULTEC AT (203) 775-4416 OR VISIT [WWW.CULTEC.COM](http://WWW.CULTEC.COM).
2. CONTACT CULTEC AT LEAST THIRTY DAYS PRIOR TO SYSTEM INSTALLATION TO ARRANGE FOR A PRE-CONSTRUCTION MEETING.
3. ALL CULTEC SYSTEM DESIGNS MUST BE CERTIFIED BY A REGISTERED PROFESSIONAL ENGINEER.
4. USE CULTEC INSTALLATION INSTRUCTIONS AS A GUIDELINE ONLY FOR MINIMUM/MAXIMUM REQUIREMENTS. ACTUAL DESIGN MAY VARY. REFER TO APPROVED CONSTRUCTION DRAWINGS FOR JOB-SPECIFIC DETAILS. BE SURE TO FOLLOW THE ENGINEER'S DRAWINGS AS YOUR PRIMARY GUIDE.
5. THE FOUNDATION STONE SHALL BE LEVEL AND COMPACTED PRIOR TO CHAMBER INSTALLATION.
6. OVERLAPPING RIB CONNECTIONS OF CHAMBERS SHALL BE FULLY SHOULDERED PRIOR TO STONE PLACEMENT.
7. CENTER-TO-CENTER SPACING SHALL BE CHECKED AND MAINTAINED THROUGHOUT INSTALLATION PROCESS.
8. ANY DISCREPANCIES WITH THE SYSTEM SUB-GRADE SOIL'S BEARING CAPACITY MUST BE REPORTED TO THE DESIGN ENGINEER.
9. NON-WOVEN GEOTEXTILE MUST BE USED AS SPECIFIED IN THE ENGINEER'S DRAWINGS.
10. CULTEC REQUIRES THE CONTRACTOR TO REFER TO CULTEC'S INSTALLATION INSTRUCTIONS CONCERNING VEHICULAR TRAFFIC. RESPONSIBILITY FOR PREVENTING VEHICLES THAT EXCEED CULTEC'S REQUIREMENTS FROM TRAVELING ACROSS OR PARKING OVER THE CHAMBER SYSTEM LIES SOLELY WITH THE CONTRACTOR THROUGHOUT THE ENTIRE SITE CONSTRUCTION PROCESS. THE PLACEMENT OF WARNING TAPE, TEMPORARY FENCING, AND/OR APPROPRIATELY LOCATED SIGNS IS HIGHLY RECOMMENDED. IMPRINTED WARNING TAPE IS AVAILABLE FROM CULTEC. FOR ACCEPTABLE VEHICLE LOAD INFORMATION, REFER TO CULTEC INSTALLATION INSTRUCTIONS.
11. TRAFFIC OF INSTALLATION EQUIPMENT OR OTHER VEHICULAR TRAFFIC OVER TOP OF THE CULTEC STORMWATER SYSTEM IS STRICTLY RESTRICTED AND PROHIBITED UNTIL SATISFACTORY COVER AND COMPACTION IS ACHIEVED ACCORDING TO CULTEC'S MANUFACTURER INSTALLATION INSTRUCTIONS.
12. EROSION AND SEDIMENT-CONTROL MEASURES MUST MEET LOCAL CODES AND THE DESIGN ENGINEER'S SPECIFICATIONS THROUGHOUT THE ENTIRE SITE CONSTRUCTION PROCESS.
13. CULTEC SYSTEMS MUST BE DESIGNED AND INSTALLED IN ACCORDANCE WITH CULTEC'S MINIMUM REQUIREMENTS. FAILURE TO DO SO WILL VOID THE LIMITED WARRANTY.
14. CONTACT CULTEC, INC. AT 203-775-4416 WITH ANY QUESTIONS OR FURTHER CLARIFICATION OF REQUIREMENTS.
15. PLACEMENT OF EMBEDMENT STONE MUST BE IN ACCORDANCE WITH CULTEC'S INSTALLATION INSTRUCTIONS. STONE COLUMN HEIGHT DEFERENTIAL MUST NEVER EXCEED 12" (305 mm) BETWEEN CHAMBER ROWS, ADJACENT CHAMBERS OR STONE PERIMETER. STONE MUST BE PLACED OVER THE CROWN OF THE CHAMBERS TO ANCHOR THE CHAMBERS IN PLACE AND MAINTAIN ROW SPACING.
16. EMBEDMENT STONE MUST ONLY BE PLACED BY EXCAVATOR OR TELESCOPING CONVEYOR BOOM. PLACEMENT OF EMBEDMENT STONE WITH BULLDOZER IS NOT AN ACCEPTABLE METHOD OF INSTALLATION AND MAY CAUSE DAMAGE TO THE CHAMBERS. ANY CHAMBERS DAMAGED USING AN UNACCEPTABLE METHOD OF BACKFILL ARE NOT COVERED UNDER THE CULTEC LIMITED WARRANTY.

THIS DRAWING HAS BEEN PREPARED TO SUPPORT THE PROJECT ENGINEER OF RECORD FOR THE PROPOSED SYSTEM. THIS DRAWING HAS BEEN PREPARED BASED ON INFORMATION PROVIDED TO CULTEC UNDER THE DIRECTION OF THE PROJECT ENGINEER OF RECORD OR OTHER PROJECT REPRESENTATIVE. IT IS ULTIMATE RESPONSIBILITY OF THE PROJECT ENGINEER OF RECORD TO ENSURE THAT THE CULTEC SYSTEM'S DESIGN IS IN FULL COMPLIANCE WITH ALL APPLICABLE LAWS, REGULATIONS AND MANUFACTURER REQUIREMENTS.

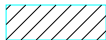

PROPOSED STORMWATER MANAGEMENT SYSTEM ELEVATIONS (TO BE APPROVED BY ENGINEER OF RECORD) *ENGINEER OF RECORD TO CONFIRM MINIMUM AND MAXIMUM BURIAL REQUIREMENTS ARE MET)	
MAXIMUM ALLOWABLE GRADE (TOP OF PAVEMENT OR UNPAVED)	287.03
MINIMUM ALLOWABLE GRADE (UNPAVED TRAFFIC)	283.78
MINIMUM ALLOWABLE GRADE (BASE OF FLEXIBLE PAVEMENT)	283.73
MINIMUM ALLOWABLE GRADE (TOP OF RIGID PAVEMENT)	283.73
TOP OF STONE ELEVATION	283.52
TOP OF CHAMBER ELEVATION	283.37
200mm HIGH-FLOW BYPASS PIPE INVERT	283.09
INLET 300mm PIPE INVERT	282.90
BOTTOM OF CHAMBER ELEVATION	282.90
BOTTOM OF STONE ELEVATION	282.75
CULTEC STORMWATER MANAGEMENT SYSTEM SUMMARY	
TOTAL STORAGE REQUIRED (m³)	21.00
TOTAL STORAGE PROVIDED (m³)	23.00
% STONE POROSITY	40
SYSTEM AREA (m²)	52.38
DEPTH OF EMBEDMENT STONE (mm)	152
DEPTH OF BEDDING STONE (mm)	152
STONE PERIMETER (mm)	305
SPACING BETWEEN CHAMBER ROWS (mm)	152


CULTEC RECHARGER®  
150XLHD LEGEND

	RECHARGER 150XLSHD STARTER
	RECHARGER 150XLIHD INTERMEDIATE
	RECHARGER 150XLEHD END
	RECHARGER 150XLRHD STAND ALONE
	FEED CONNECTORS
	SEPARATOR ROW
	WOVEN GEOTEXTILE
	STONE BORDER

NOTE: ALL EXTERNAL SYSTEM STRUCTURES, INLET/OUTLET PIPES AND PROPOSED ELEVATIONS MUST BE DESIGNED AND APPROVED BY THE ENGINEER OF RECORD. ALL PROPOSED SYSTEM ELEVATIONS PROVIDED MUST BE VERIFIED BY THE ENGINEER OF RECORD AND THE ENGINEER OF RECORD MUST ENSURE CHAMBER BURIAL REQUIREMENTS ARE MET

MATERIALS LIST SUPPLIED BY CULTEC			
PRODUCT DESCRIPTION	SKU	QUANTITY	UNIT OF MEASURE
CULTEC RECHARGER 150XLHD STARTER	150XLSHD	7	PIECES
CULTEC RECHARGER 150XLHD INTERMEDIATE	150XLIHD	0	PIECES
CULTEC RECHARGER 150XLHD END	150XLEHD	7	PIECES
CULTEC HVLV FEED CONNECTORS	FC-24	4	PIECES
CULTEC NO. 410 NON-WOVEN GEOTEXTILE	75NWX410	220	SQ. METERS
CULTEC AFAB-HPF WOVEN GEOTEXTILE	75WGHPPF	28	METERS
CULTEC INSPECTION PORT KIT	1299CGC	2	PIECES
MATERIALS LIST NOT SUPPLIED BY CULTEC			
1-2 INCH WASHED, CRUSHED STONE	---	29	CUBIC METERS
8 OZ. NON-WOVEN GEOTEXTILE	---	N/A	SQ. METERS
30 MIL. PVC THERMOPLASTIC LINER	---	N/A	SQ. METERS

- SPECIAL CONSIDERATIONS FOR SYSTEM PROXIMITY TO BUILDING FOUNDATIONS**
- IT IS ULTIMATELY THE RESPONSIBILITY OF THE ENGINEER OF RECORD TO DETERMINE THE FINAL LOCATION OF THE CULTEC SYSTEM ACCORDING TO ALL APPLICABLE LAWS AND REGULATIONS
  - CULTEC RECOMMENDS A MINIMUM 10.0' (3.66M) SEPARATION BETWEEN THE CHAMBER SYSTEM AND ANY LOAD-BEARING STRUCTURAL SITE ELEMENTS
  - IF REQUIRED, THE ENGINEER OF RECORD MAY LOCATE CHAMBERS CLOSER THAN 10.0' (3.66M) TO STRUCTURAL ELEMENTS, PROVIDING THAT THE FOLLOWING CONSIDERATIONS HAVE BEEN MET  
NO LOADS FROM SITE STRUCTURAL ELEMENTS SHALL BE TRANSFERRED TO THE CULTEC CHAMBER SYSTEM  
THE ENGINEER OF RECORD, STRUCTURAL AND OR GEOTECHNICAL CONSULTANTS REVIEW ANY HYDROSTATIC EFFECTS THE SYSTEM MAY HAVE ON THE STRUCTURAL ELEMENT  
THE ENGINEER OF RECORD, STRUCTURAL AND OR GEOTECHNICAL CONSULTANTS REVIEW ANY EFFECTS OF A SATURATED SOIL CONDITION MAY HAVE ONT HE STRUCTURAL ELEMENT  
THE ENGINEER OF RECORD, STRUCTURAL AND OR GEOTECHNICAL CONSULTANTS REVIEW ANY STRUCTURAL EFFECTS THE SYSTEM MAY HAVE ON THE STRUCTURAL ELEMENT

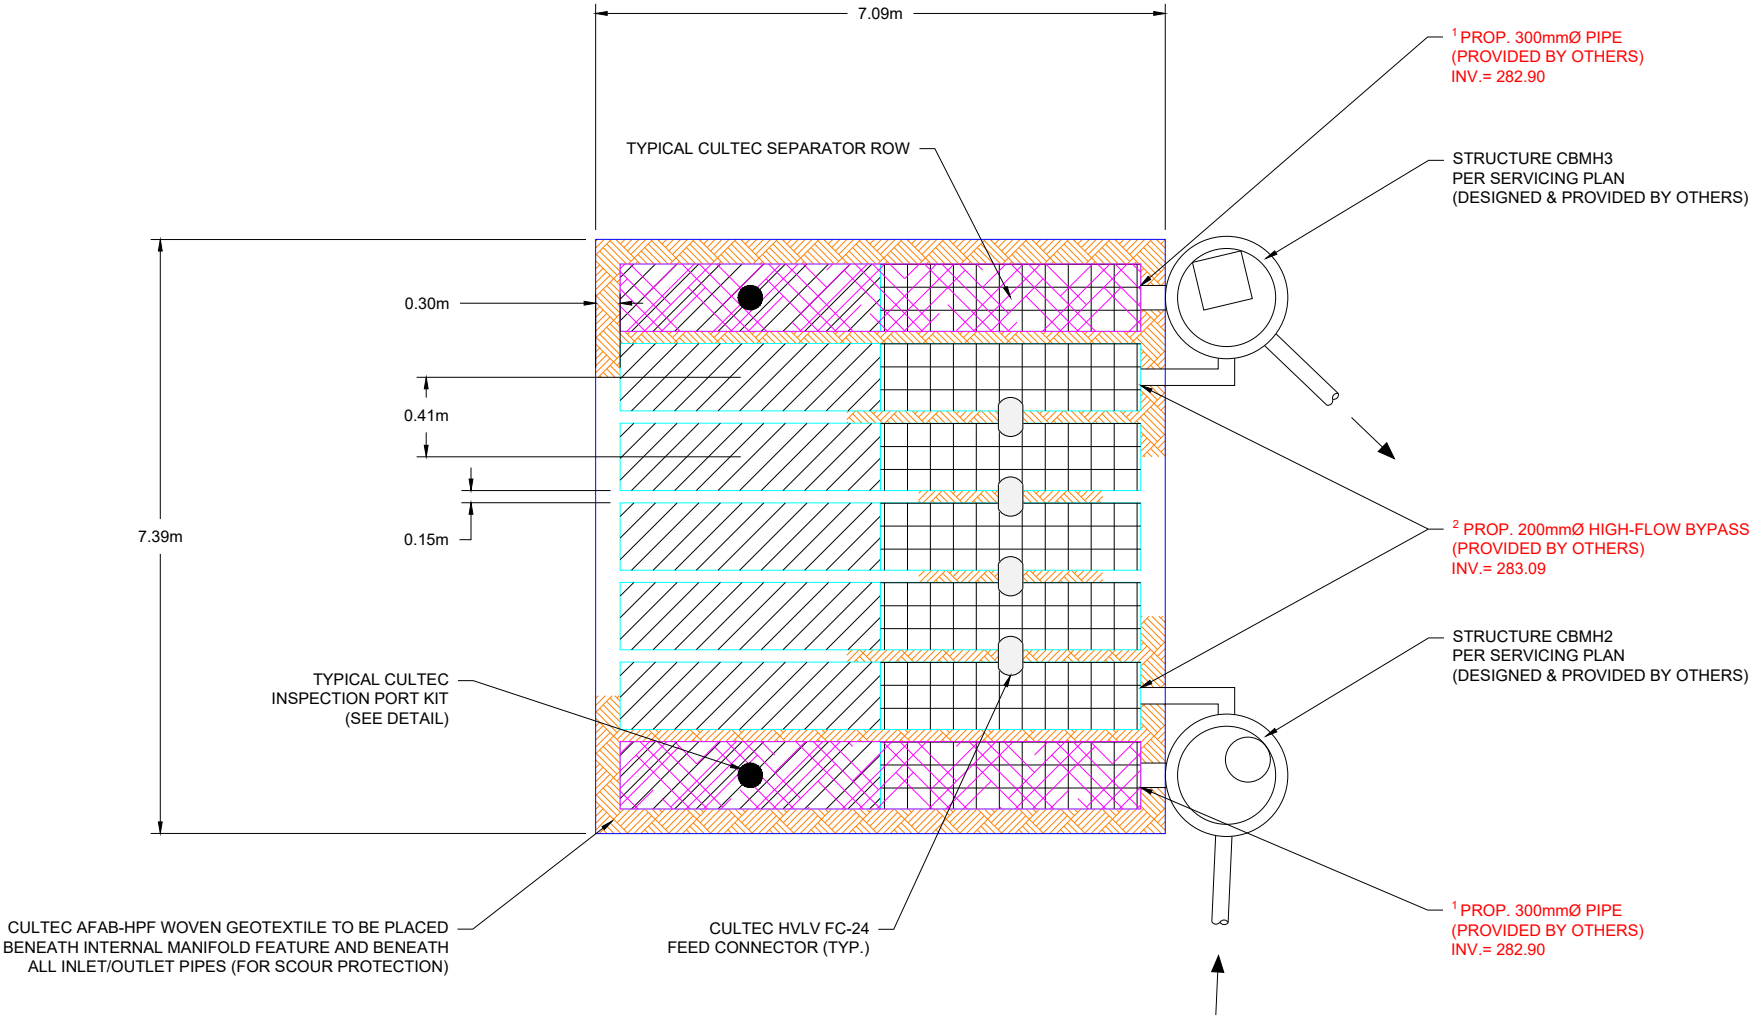

1 SYSTEM LAYOUT DETAIL  
NTS

PROPOSED SYSTEM ALTERATION TABLE	
1	PROPOSED SEPARATOR ROW ACCESS PIPE
2	PROPOSED SEPARATOR ROW HIGH-FLOW BYPASS PIPE



CULTEC

Subsurface Stormwater Management Systems

878 Federal Road  
Brookfield, CT 06804  
www.cultec.com

CULTEC

Blair Rd Public School Parking Lot Exp.  
85 Sunset Blvd.  
Cambridge, ON

PROJECT NO: 25-0399.01

DATE: 04/10/2025

DESIGNED BY: MPW

CHECKED BY: TNB

SCALE: N.T.S

SHEET NO: 2 OF 5

THE DRAWING HAS BEEN PREPARED TO SUPPORT THE PROJECT AND THE ENGINEER OF RECORD AND THE ENGINEER OF RECORD MUST ENSURE CHAMBER BURIAL REQUIREMENTS ARE MET. THE DRAWING HAS BEEN PREPARED BASED ON INFORMATION PROVIDED TO CULTEC UNDER THE DIRECTION OF THE PROJECT ENGINEER. CULTEC DOES NOT WARRANT THE ACCURACY OF THE INFORMATION PROVIDED TO CULTEC. CULTEC IS NOT RESPONSIBLE FOR ANY ERRORS OR OMISSIONS IN THE DRAWING. CULTEC IS NOT RESPONSIBLE FOR ANY CONSEQUENCES OF THE USE OF THE DRAWING FOR ANY PURPOSE OTHER THAN THAT FOR WHICH IT WAS PREPARED.















GENERAL TREE NOTES

1. All dimensions are in metres.
2. Contractor shall verify all conditions in the field and report any discrepancies to the Project Engineer prior to commencement of work.
3. Any soils and vegetation within tree protection zone damaged by the Contractor shall be restored to the satisfaction of the City of Cambridge by the Contractor at the additional cost to the City of Cambridge.
4. All arboricultural work performed on trees such as pruning of branches and roots shall be conducted by an ISA Certified Arborist.
5. Prune and mitigate limbs and roots damaged by construction work in accordance with ANSI A300 (Part 1) - 2008 Pruning and the Best Management Practices companion publication (revised 2008).
6. Tree Protection Fence to be erected prior to the commencement of any construction or grading, and maintained throughout the duration of the work.
7. Tree Protection Zone is delimited by Tree Protection Fence shown on the drawings.
8. No construction or activities including the following to occur within Tree Protection Zone: equipment parking or access, storage of supplies, topsoil or fill, and refueling.
9. Tree removals (if required) will be undertaken in compliance with the Migratory Birds Convention Act. Efforts will be made to remove vegetation outside the General Nesting period (April 1 - Aug 31) for regions C1 and C2 of Ontario. In the event vegetation must be removed within the General Nesting Period, a qualified avian biologist is to review the site prior to removal to ensure compliance with the Migratory Birds Convention Act.

CONSTRUCTION WITHIN MINIMUM TREE PROTECTION ZONE

1. An ISA Certified Arborist must be present on site during construction activities within MTPZ to confirm and/or modify mitigation measures for trees to be preserved.
2. Use trenchless methods (e.g. horizontal directional drilling) to install underground services (e.g. sanitary sewers and water lines) within Minimum Tree Protection Zones.

EXISTING UNDERGROUND SERVICES WITHIN TREE PROTECTION ZONES

1. Existing sanitary/storm sewers and watermain to be discontinued within tree protection zones will be filled (as needed) and abandoned.
2. Excavation and access for construction/removal of abandoned underground services will be conducted outside of tree protection zones.

FINISH GRADING WITHIN TREE PROTECTION ZONES

Where finish grading of cuts and fills, and including swales occurs within tree protection zones, the following steps are required.

Grade Cut:

1. Excavate by hand or Air-spade technology to a maximum depth of 100mm.
2. Roots encountered are to be assessed by the Project Arborist to determine the extent of roots to be pruned. Based on findings, other treatments may be required (e.g. crown reduction, tree removal), and which may require approval from the City.
3. Based on root findings, local, minor adjustments to grading within the tree protection zone may be required based on field consultation between the Project Arborist and Project Engineer.
4. No access by heavy equipment into tree protection zone is permitted. Fine grading to be carried out using light equipment and/or by hand.

Grade Fill:

5. Add topsoil to meet grade requirements to a maximum of 150mm.
6. No topsoil to be added onto trunk base or above-ground section of trunk base flare.
7. Maintain positive drainage away from trunk base.
8. Based on local conditions (e.g. surface drainage), local, minor adjustments to grading within the tree protection zone may be required based on field consultation between the Project Arborist and Project Engineer.

TREES OWNED BY OTHERS

1. Trees owned by others require permission (i.e. written consent) from the land owner(s) prior to activities that may damage or destroy trees. Trees owned by others are Offsite Trees and Shared Trees:
  - a. Offsite Trees - Trees on property adjacent to the subject property
  - b. Shared (Boundary) Trees - Trees whose trunk including the basal trunk flare growing on the boundary between the subject property and adjoining property (from *Ontario Forestry Act*).

The Provincial Forestry Act, R.S.O. 1990 (Section 10):

10. (2) Every tree whose trunk is growing on the boundary between adjoining lands is the common property of the owners of the adjoining lands. 1990, c. 18 Sched. I, s. 21.  
(3) Every person who injures or destroys a tree growing on the boundary between adjoining lands without the consent of the land owners is guilty of an offence under this Act. 1998, c. 18, Sched. I, s. 21.

ROOT SENSITIVE EXCAVATION



A preliminary excavation at the limit of work is recommended to determine the potential magnitude of the impacts posed by the planned work. For excavation in turf or permeable surfaces, the final excavation limit should be marked in the field and arborist supervised excavation shall be performed using air-spade, dry-vac truck, hydro-vac truck or hand tools. For excavation of existing impermeable surfaces, the impermeable top layer may be broken up by machine to allow access to the permeable base layers. The permeable base layers may need to be excavated further to expose existing roots, in which case this excavation shall be performed using air-spade, dry-vac truck, hydro-vac truck or hand tools. All root sensitive excavation must be performed under the supervision of a qualified arborist. All roots exposed must be documented by the supervising arborist. Every effort should be made to preserve as many exposed roots as possible. Roots approved for pruning should be cleanly cut with a sharp, non-vibrating tool such as a handsaw, secateurs, chainsaw at face of trench such that no further disturbance of the roots are to be expected once mechanical excavation begins. All root pruning is to be performed by the arborist only, as per guidelines below.

1. When root sensitive excavation is performed in regards to the installation of a deep site feature such as a foundation, roots of less than 5cm diameter can be cut sharply, if necessary, unless an abundance of smaller roots are involved. If roots of 5cm diameter or greater or an abundance of smaller roots are exposed in the excavation areas inside or just outside the Tree Protection Zone (TPZ) of bylaw trees they should be preserved.
2. When root sensitive excavation is performed in regards to the installation of site features such as post holes, all roots exposed of under 5cm diameter may be cleanly cut at face of hole such that no further disturbance of the roots are to be expected once mechanical excavation begins for the lower portion of the holes (below hand dug area). If roots of 5cm diameter or greater are uncovered they should be preserved, the post holes filled in with viable soil and the hole moved at least 0.5 metre away to avoid significant roots.
3. When root sensitive excavation is performed in regards to the installation of site features such as driveways, walkways, curbs, etc. roots of less than 5cm diameter can be cut sharply, if necessary, unless an abundance of smaller roots are involved. If roots of 5cm diameter or greater or an abundance of smaller roots are exposed in the excavation areas inside or just outside the TPZ of bylaw trees they should be preserved
4. When root sensitive excavation is performed in regards to the installation of utilities such as water lines or sewers, every effort should be made to preserve as many exposed roots as possible by installing the utilities underneath the roots without root pruning. If roots of 5cm diameter or greater are uncovered they should be preserved.

1 GENERAL TREE PROTECTION NOTES

SITE SPECIFIC PRE-CONSTRUCTION ROOT EXPLORATION NOTES

1. Demolition, excavation, and construction work within the dripline of Tree #22, 29 and 30 where tree roots have the potential to be impacted is to be performed under the observation of an ISA Certified Arborist retained by the Contractor
2. The ISA Certified Arborist will observe, document, and respond to Contractor requests for information related to trees, tree roots, and root pruning while the General Contractor and their subcontractor(s) use dry-vac excavation technology within the dripline of Tree #'s listed above. The ISA Certified Arborist will prepare a report documenting above and below grade conditions related to trees, recommended best management practices and next steps based on project requirements including site specific permit conditions, reports, drawings, and specifications.
3. If, during the dry-vac excavation procedure, the ISA Certified Arborist observes the potential for impacts to the roots of Tree #'s listed above that are such that root pruning will be detrimental to the health and structure of the tree, they will contact a City of Cambridge Forestry Division Staff Member for further review and recommendation. All demolition and excavation work is to stop and exposed tree roots are to be covered by General Contractor and their subcontractor(s) within 30 minutes with untreated burap or alternative material acceptable to ISA Certified Arborist, and wet with potable water, free of impurities that may harm trees/tree roots. Maintain moisture until such time that the recommendation to proceed is received in writing.

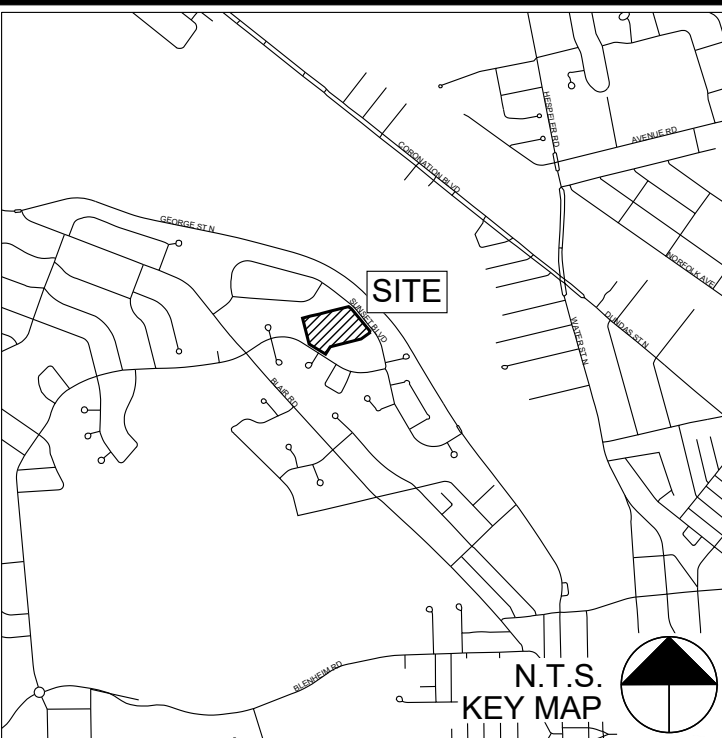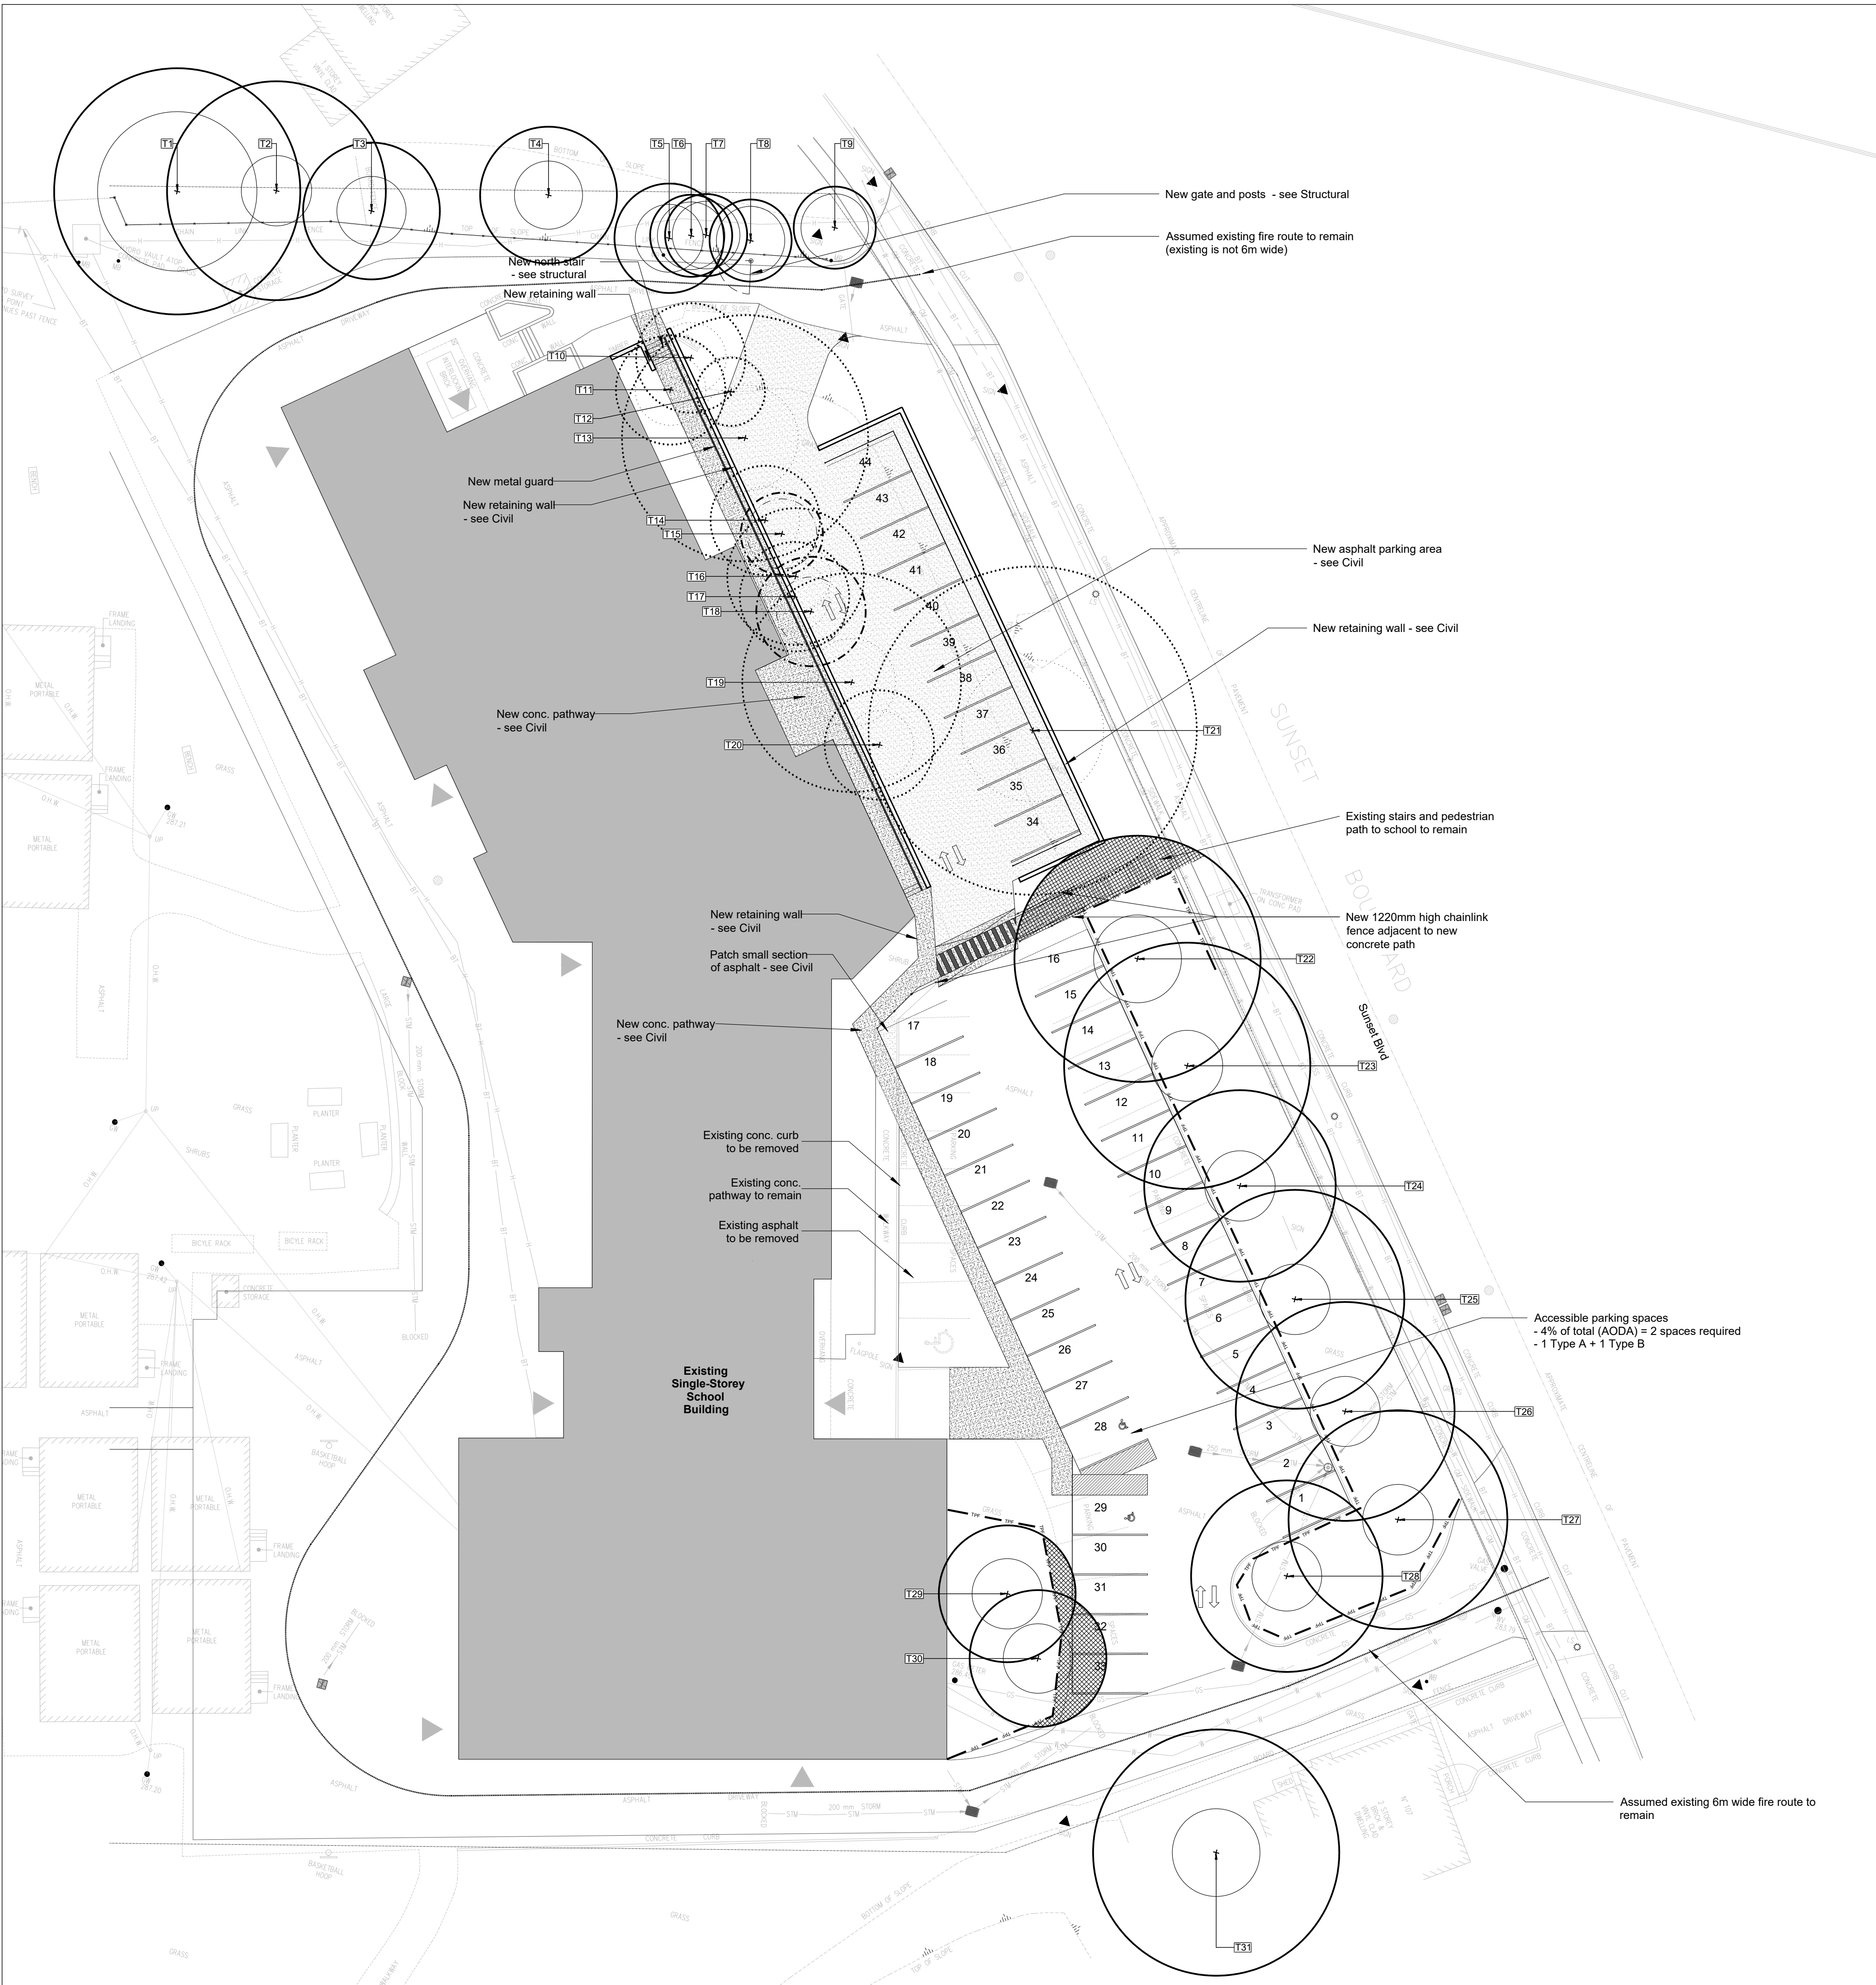

LEGEND:

- EXISTING TREE  
ID NUMBER / OUTER CIRCLE DENOTES APPROX. CROWN RESERVE, INNER CIRCLE DENOTES MINIMUM TREE PROTECTION ZONE (MTPZ)
- PRESERVE TREE  
TREE HAS MODERATE TO HIGH BIOLOGICAL HEALTH AND/OR STRUCTURAL CONDITION AND CAN BE INCORPORATED INTO THE PROPOSED DEVELOPMENT
- REMOVE TREE  
TREE IS IN CONFLICT WITH PROPOSED DEVELOPMENT
- REMOVE TREE  
TREE HAS LOW BIOLOGICAL HEALTH AND/OR STRUCTURAL CONDITION AND IS IN CONFLICT WITH PROPOSED DEVELOPMENT
- TREE PROTECTION FENCE
- ROOT SENSITIVE EXCAVATION  
REFER TO NOTES ON THIS DRAWING

INFORMATION SOURCES

1. Topographic Survey dated January 15, 2025 from Genesis Land Surveyors Inc.
2. Site Plan dated March 18, 2025 from Workshop Architecture
3. Site Grading and Servicing Plans received March 27, 2025 from Mantecon Partners Inc.
4. Tree locations collected by an Aboud & Associates Inc. ISA Certified Arborist on March 24, 2025.

3	ISSUED FOR CONSTRUCTION	MGN	05 JUN-25
2	CITY COMMENTS	MGN	22 MAY-25
1	CITY COMMENTS	MGN	15 MAY-25
0	ISSUED FOR COORDINATION	MGN	28 MAR-25
No.	Description	By	Date

REVISIONS: All previous issues of this drawing are superseded

**ABOUT & ASSOCIATES INC.**  
Consulting Arborists • Ecologists • Landscape Architects  
3-6 Edinburgh Road South, Guelph, Ontario, N1H 5N8 • 519.822.6839 • aboutginc.com


Title:

TREE PRESERVATION PLAN

Project:

**WRDSB PARKING LOT**  
85 SUNSET BOULEVARD  
CAMBRIDGE, ONTARIO

Date: MARCH 2025	Designer: NB
Project: AA25-067A	Drawn: NB
Scale: 1:250	Checked: JD/MGN

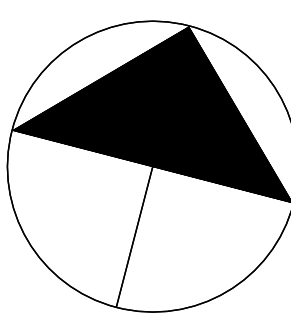

Drawing No:

**TPP-1**



1. DBH (Diameter at breast height): Measurement of tree stem diameter at 1.4 meters above ground.
2. {} Denotes DBH's of Each Stem of Tree with Multiple Stems
3. Tree Protection Zones, Taken from Tree Protection Barrier Detail (TP-1) City of Cambridge, March, 2019.

Removal of trees owned by others (e.g. private off-site, municipal or shared/boundary trees) require approval from the owner.

Removal of trees owned by others (e.g. private off-site, municipal or shared/boundary trees) require approval from the owner.

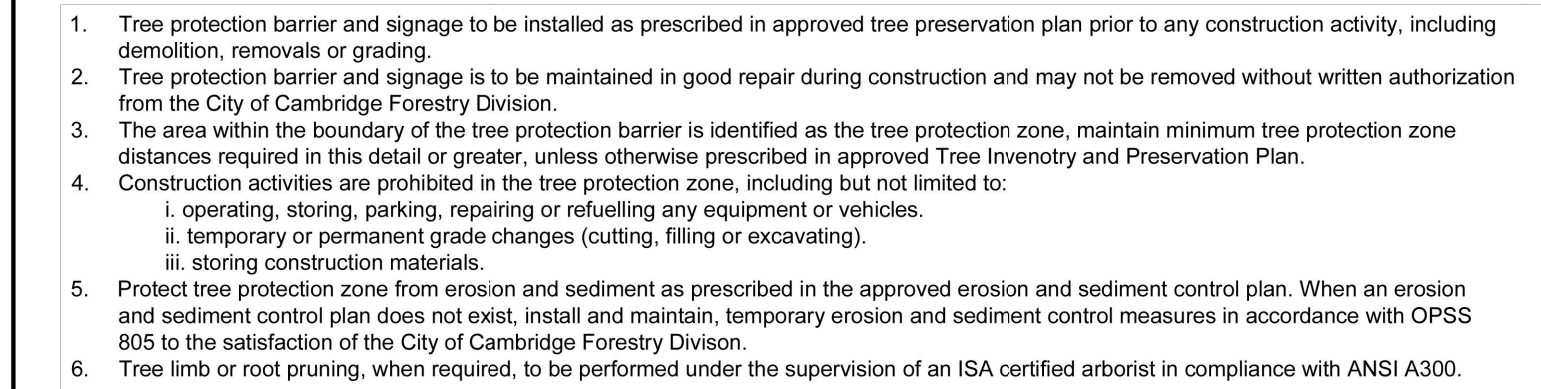


Diagram illustrating the required tree protection structure for an existing tree to be preserved. The structure consists of a 1.2 M (4') high orange plastic web snow fencing, a 0.6 M high T-bar, and a 1.2 M high orange plastic web snow fencing. The structure is labeled "MINIMUM TREE PROTECTION ZONE (TPZ) DISTANCE REQUIRED" and "TPZ - TREE PROTECTION ZONE BOUNDARY". The diagram also shows a "CROWN DRIP LINE" and "EXISTING TREE TO BE PRESERVED".

NOTES:  
<sup>1</sup> DIAMETER AT BREAST HEIGHT (DBH) IS THE MEASUREMENT OF TREE TRUNK AT 1.4 METRES ABOVE GROUND.  
<sup>2</sup> MINIMUM TREE PROTECTION ZONE (MTPZ) ZONE DISTANCES ARE TO BE MEASURED FROM ANY OUTSIDE EDGE OF THE TREE BASE TOWARDS THE DRIP LINE.

Drawing No:  <div style="font-size: 2em; font-weight: bold; text-align: center;">TP-1</div>	Date: MARCH 2019
	Scale: N.T.S.
	Page: 1 of 1




CAMBRIDGE  
CANADA  
PEOPLE • PLACE • PROSPERITY

1  
TPP-2



2  
TPP-2

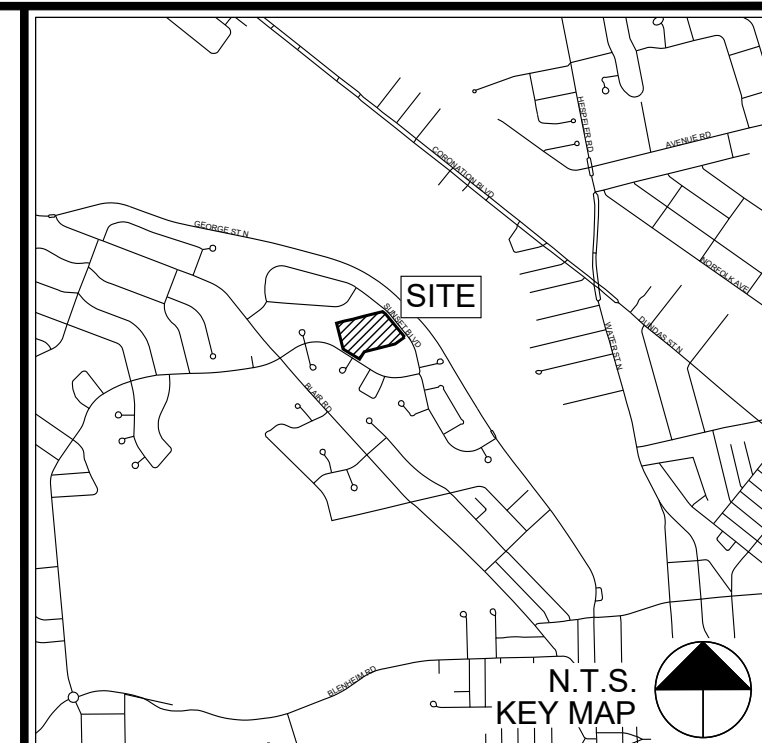

3	ISSUED FOR CONSTRUCTION	MGN	05 JUN-25
2	CITY COMMENTS	MGN	22 MAY-25
1	CITY COMMENTS	MGN	15 MAY-25
0	ISSUED FOR COORDINATION	MGN	28 MAR-25
No.	Description	By	Date

**REVISIONS:** All previous issues of this drawing are superceded



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3-5 Edinburgh Road South, Guelph, Ontario, N1H 5H8, 519.822.6839, [aboutdng.com](http://aboutdng.com)

Title: \_\_\_\_\_

Title: TREE PRESERVATION NOTES AND DETAILS

Project: \_\_\_\_\_

**WRDSB PARKING LOT**  
85 SUNSET BOULEVARD  
CAMBRIDGE, ONTARIO

Date: MARCH 2025	Designer: NB
Project: AA25-067A	Drawn: NB
	Checked: JD/MGN

Drawing No: **TPP-2**